Colwood

CITY OF COLWOOD

3300 Wishart Road | Colwood | BC V9C 1R1 | 250 294-8153 planning@colwood.ca | www.colwood.ca

File: DP000021

DEVELOPMENT PERMIT DP000021

THIS PERMIT, issued OCTOBER 16, 2024, is,

ISSUED BY:

CITY OF COLWOOD, a municipality incorporated under the Local Government Act,

3300 Wishart Road, Victoria, BC, V9C 1R1

(the "City")

PURSUANT TO:

Section 490 of the Local Government Act , RSBC 2015, Chapter 1

ISSUED TO:

ROYAL BAY HOLDINGS NO. 2 LTD. SUITE 1774, FOUR BENTALL CENTRE

1055 DUNSMUIR STREET VANCOUVER BC V6B 4N7

(the "Permittee")

 This Form and Character Development Permit applies to those lands within the City of Colwood described below, and any and all buildings, structures, and other development thereon:

LOT A SECTIONS 40, 41, 42, 51, 52 AND 53 ESQUIMALT DISTRICT PLAN EPP124123 EXCEPT PLAN EPP127784 AND EPP132340

(the "Lands")

- This Development Permit regulates the development and alterations of the Land, and supplements
 the "Colwood Land Use Bylaw, 1989" (Bylaw No. 151), to ensure the Form and Character
 considerations for a 60-unit townhouse development and associated site improvements are
 consistent with the design guidelines for areas designated as "Intensive Residential" in the City of
 Colwood Official Community Plan (Bylaw No. 1700).
- This Development Permit is <u>NOT</u> a Building Permit or a subdivision approval.
- This Development Permit is issued subject to compliance with all of the bylaws of the City of Colwood that apply to the development of the Lands, except as specifically supplemented by this Permit.

- 5. The Director of Development Services or their delegate may approve minor variations to the schedules attached to and forming part of this Development Permit, provided that such minor variations are consistent with the overall intent of the original plans and do not alter the form and character of the development authorized by those plans.
- 6. If the Permittee does not substantially start the construction permitted by this Permit within 24 months of the date of this Permit, the Permit shall lapse and be of no further force and effect.
- 7. The development is to be constructed in accordance with the following plans and specifications, which are attached to and form as part of this permit:

Schedule 1 Architectural Drawings prepared by Proscenium Architecture + Interiors INC. dated September 23, 2024.

Schedule 2 Landscape Plan prepared by LADR Landscape Architects dated September 9, 2024.

Schedule 3 Landscape Budget prepared by LADR Landscape Architects dated August 27, 2024

8. This Development Permit authorizes the construction of a 60-unit townhouse development along with any associated site works. The Lands shall not be altered, nor any buildings or structures constructed, except in accordance with the following conditions:

GENERAL

- 8.1. This Permit shall not be construed as relieving the Permittee from compliance with any of the requirements contained within the Section 219 covenants registered as "CA8439553" (Development Agreement).
- 8.2. British Columbia's archaeological sites are protected under the Heritage Conservation Act and shall not be altered or damaged without the required permits from the Provincial Archaeology Branch.
- 8.3. This permit does not authorize any blasting on the site.

FORM AND CHARACTER CONDITIONS

Building Features

- 8.4. The form and character of the buildings to be constructed on the Lands shall conform to the Architectural Drawings prepared by Proscenium Architecture + Interiors INC. (Schedule 1).
- 8.5. Any future additions of telecommunications antennas or equipment to the exterior of the buildings and/or structures included in this Permit shall be architecturally integrated into the buildings and/or structures they are mounted on or screened from views so as not to be visually obtrusive, to the satisfaction of the Director of Development Services or their delegate.
- 8.6. All mechanical roof elements, including mechanical equipment, elevator housings, and vents shall be visually screened with sloped roofs or parapets, or other forms of solid screening to the satisfaction of the Director of Development Services or their delegate.

8.7. No future construction/installation of unenclosed or enclosed outdoor storage areas or recycling/refuse collection shall be undertaken without the issuance of a further Development Permit or amendment to this Permit.

Signage

8.8. This Development Permit does not include any signage approvals. A separate sign permit will be required for any marketing signage.

Site Lighting

8.9. The site lighting shall be in accordance with the lighting details included in the Landscape Plan prepared by LADR Landscape Architects (Schedule 2).

Landscaping

- 8.10. The design and construction of the proposed landscaping shall be in substantial compliance with the Landscape Plan prepared by LADR Landscape Architects (Schedule 2).
- 8.11. Prior to the issuance of a building permit, the Permittee shall provide the City with a written letter of engagement from a registered landscape architect agreeing to:
 - 8.11.1. Supervise and install the landscape work in accordance with the approved Landscape Plan prepared by LADr Landscape Architects (Schedule 2); and
 - 8.11.2. Perform a final inspection and submit an inspection report to the City confirming substantial compliance with the approved landscape plan.
- 8.12. Prior to the issuance of Building Permit, the Permittee shall obtain a one-year warranty of the landscape works from the landscape contractor. This warranty shall be transferrable to subsequent owners of the property within the warranty period. The warranty must include provision for a further one-year warranty on materials.
- 8.13. Prior to the issuance of a Building Permit, the Permittee must provide to the City in the form of an irrevocable letter of credit or certified cheque, security in the amount of \$318,206.9 based on 110% of the Landscape Cost Estimate prepared by LADR Landscape Architects (Schedule 3), which amount, or a portion therefore, as the case may be, shall be returned, no sooner than 1 year from the date of planting, upon receipt of a signed statement of substantial completion from a registered landscape architect, to the satisfaction of the Director of Development Services.

ISSUED ON THIS 16 DAY OF October, 2024.

JOHN ROSENBERG, A.Sc.T.

DIRECTOR OF ENGINEERING AND DEVELOPMENT SERVICES



PROSCENIUM

ARCHITECTURE + INTERIORS INC.

300 - 151 EAST 2ND AVE VANCOUVER BC V5T 1B4 CANADA

604,879,0118 www.proscenium.ca

DP ARCHITECTURAL DRAWING LIST

DWG.	DRAWING NAME
A001	PROJECT STATISTICS
A002	DEVELOPMENT PLAN (FOR INFO ONLY)
A003	SITE SURVEY (FOR INFO ONLY)
A004	PROPOSED BUILDING RENDERINGS
A005	PROPOSED BUILDING RENDERINGS
A006	PROPOSED BUILDING RENDERINGS
A007	PROPOSED BUILDING RENDERINGS
A100	SITE PLAN
A101	SITE SECTIONS
A102	SITE SECTIONS
A300	ELEVATIONS BLOCK A
A301	ELEVATIONS BLOCK B
A302	ELEVATIONS BLOCK C
A303	ELEVATIONS BLOCK D
A304	ELEVATIONS BLOCK E
A305	ELEVATIONS BLOCK F
A306	ELEVATIONS BLOCK G
A307	ELEVATIONS BLOCK H
A308	ELEVATIONS BLOCK I
A309	ELEVATIONS BLOCK J
A310	ELEVATIONS BLOCK K
A311	BUILDING SECTIONS
A312	BUILDING SECTIONS
A313	BUILDING SECTIONS
A314	BUILDING SECTIONS
A315	BUILDING SECTIONS
A316	LEVEL PLANS - BLOCKS A, B,C
A317	LEVEL PLANS - BLOCKS D,E
A318	LEVEL PLANS - BLOCK F,G
A319	LEVEL PLANS - BLOCKS H, I
A321	LEVEL PLANS - BLOCKS J,K
A350	UNIT PLANS - ISLA
A351	UNIT PLANS - STACKED UNITS
A700	SITE DETAILS



PARCEL 5 EAST

ROYAL BAY, COLWOOD

CLIENT

PCRE GROUP FOUR BENTALL CENTRE 1055 DUNSMUIR ST #1774 VANCOUVER BC

GEOTECH

THURBER ENGINEERING 4464 MARKHAM ST #2302 VICTORIA BC

LANDSCAPE

LADR LANDSCAPE ARCHITECTS 864 QUEENS AVE #3 VICTORIA BC

BUILDING ENVELOPE

EVOKE BUILDINGS 814 BROUGHTON ST #102 VICTORIA BC

BUILDING ELECTRICAL

PARALLEL ENGINEERING 5056 CORDOVA BAY ROAD VICTORIA BC

ENERGY

BERNHARDT CONTRACTING 1535 OAK CREST DR VICTORIA BC

STRUCTURAL

FARHILL ENGINEERING VICTORIA BC

INTERIOR DESIGN

937 DUNFORD AVE #105

MECHANICAL

VICTORIA BC

AVALON MECHANICAL

1245 ESQUIMALT RD #300

PROSCENIUM ARCHITECTURE + INTERIORS 151 EAST 2ND AVE #300 VANCOUVER BC

SITE ELECTRICAL

PRIMARY ENGINEERING 4240 GLANFORD AVE #200 VICTORIA BC

CIVIL

ON POINT PROJECT ENGINEERS 957 LANGFORD PKWY #111 VICTORIA BC

PHASE PHASE EAST - DP SET 09/23/2024

PROJECT STATISTICS: CIVIC ADDRESS: LEGAL DESCRIPTION ZONING: CD28 (AREA 10) SITE AREA: 0 979 HA = 2 41 ACRES = 105 378 SE MAXIMUM LOT COVERAGE MAXIMUM LOT COVERAGE ALLOWED SETBACKS:
FRONT - 3m WITH REAR LANE ACCESS / 6m TO GARAGE FACE
REAR - 6m
EXTERIOR SIDE - 3m
MN. BUILDING SEPARATION - 1.2m PROPOSED SETBACKS:
FRONT (PRODUCERS WAY) - 4.1m
REAR (SRW) - 11.8m
EXTERIOR SIDE (RESTORATION WAY) - 5m
EXTERIOR SIDE (PARK) - 3m
MIN. BUILDING SEPARATION - 2.45m ALLOWABLE BUILDING HEIGHTS: 12.5m FROM AVERAGE PROPOSED GRADE PROPOSED BUILDING HEIGHTS: 9 TO 12m FROM AVERAGE PROPOSED GRADE TOTAL BUILDABLE AREA: TOTAL BUILDABLE AREA: PROPOSED - 91.039 SF FLOOR SPACE RATIO: FLOOR SPACE RATIO: ISABLE OPEN SPACE USABLE OPEN SPACE:

UNIT BREAKDOWN			
UNIT TYPE	NUMBER OF UNITS	BUILDABLE SURFACE/UNIT	TOTAL DEVELOPED
STACKED UNITS - GROUND LEVEL	13	92 m² - 994 SF	1,201 m2 - 12,927 SF
STACKED UNITS - UPPER LEVEL	26	116 m2 - 1,250 SF	3,020 m2 - 32,507 SF
ISLA	21	168 m ² - 1,811 SF	3,534 m2 - 38,039 SF
TOTAL 60 UNITS			7,755 m ² = 83,473 SF
ACCESSORY BUILDINGS (BIKE AND GA EXTERIOR SPACES BUILT (PATIOS. BA			7,922 m ² - 85,270 SF 8,478 m ² - 91,254 SF

ACCESSORY BUILDINGS HEIGHTS	
ACCESSORY BUILDING	BUILDING HEIGHT AT HIGHEST POINT
1	52,243 F.F.E.
2	51,759 F.F.E.
3	51,661 F.F.E.
4	51,082 F.F.E.
5	50,618 F.F.E.

VEHICLE PARKING					
UNIT TYPE	ZONING PARKING RA	ITIO REQUIRE	D PARKING	PROPOSED PARKING STALLS	
GROUND LEVEL	1,5/UNIT	20		22	
UPPER LEVEL	1,5/UNIT	39		42	
SLA	1.5/UNIT	32		21 OUTSIDE + 21 GARAGES	
VISITOR	0.1/UMT	6		6	
	TOTAL STALLS REQ	UIRED: 97	TOTAL PROVIDED:	112	
	NG REQUIRED FOR TOTA ZONING BIKES	L PARKING SUPPLY		E STRUCTURED IN CLOSED GARAGES ACES: 2 SPACES PROPOSED BIKES STALLS	
LONG TERM	1.0/UNIT	60	QUITED DINES	62 (41 IN ENCLOSED BUILDINGS, 21 PRIVATE IN	ISLAS)
SHORT TERM	6.0/LOT	6		6	
OVERSIZED LONG T		6		6	
OVERSIZED SHORT		1			
	TOTAL BIKES	REQUIRED: 66	TOTAL PROVID	DED: 68	

DESIGN RATIONALE

PROGRAM

The project is comprised of 60 residential townhome units that carefully respond to Colwood Official Community Plan, the Royal Bay Area Plan, and the Latoria South Sub-Area Plan, and adher to relevant bylaws and zoning regulations. The can be categorized into three types: sits (three-storey homes), and stacked townhomes that are divided into ground level units (one-storey homes) and upper-level units (two-storey homes).

The three-level townhouse "slas" are organized in groups of three to five units. With a half-buried basement, each isla unit features an individual garage accessible from the internal road of the site, Located on the western side of the site, these units have their main access on level two from Restoration Way. Their area is about 168 m² (1,811 SF).

The stacked units (representing two distinct volumes) are comprised of a ground floor unit with a private garden and two upper-level units. While these units are accessed from the ground floor, their primary living reasa are situated on levels two and three. The entrances of the stacked units are oriented towards the parking area and gardens for both functionally and aesthetic. The stacked units are arranged in pairs primarily on the easier side of the site with two rows on the northern side comprising three and two units, Each ground level has an area of about 92 m² (994 SF) and each upper level unit is about 118 m; (1,280 SF). All the areas combined give an FSR of 0.86, which is far below the 1.0 maximum FSR, yet aligns with community data intensits to sucord tuble, and active transcortation.

The proposal's key characteristics can be evaluated against the Colwood Official Community Plan goals as follows:

- · Goal: Transit-friendly residential densities with a minimum of 45 people per hectare
- The project supports 60 units across 0.97 hectares, achieving between 60 and 180 people per hectare, well above the desired minimum.
- Goal: Create housing choices for a diverse age-mixed community
- 3 distinct housing models offering 1, 2 and 3 storey home options are provided in the proposed development, appealing to a diverse demographic.
- · Goal: Walkable neighbourhoods with access to amenities that support daily life
- Retail and commercial amenties at the Latoria South Commons are within a 15-minutes walk of the proposed development, with pedestrian connections at all edges of the
 property and multiple pathways through the site.
- The east edge of the site features a community park, and the south edge of the site contains a utility SRW, which is proposed to have the dual purpose of being a walking path connecting the west and east, with ground-oriented units animating the public realm.
- · Goal: Plan for alternative transportation
- The project is designed to be experienced at a pedestrian level, calming the movement of vehicles.
- Garages have been designed to contain multiple bicycles each, encouraging active transportation.

FORM AND CHARACTER

The proposal's key characteristics can be evaluated against the Colwood Official Community Plan goals as follows:

- · Goal: Establish a neighbourhood character
- The architecture is distinct from other projects in the Royal Bay area, drawing on contemporary west coast modern materiality and Northern European simplicity of form.
- The neighbourhood achieves a unique character that is varied but consistently applied.
- Details and materials are consistently modern, and present clean lines, volumetric forms, and attention to human scaled.
- · Goal: Town houses are to express individual units through architectural massing or materials, such as varied step backs, varied roof lines, or distinct colours
- An essential objective of the design is to avoid a repetitive suburban aesthetic and instead differentiate each unit from its counterparts, Although the floor plans and window
 patterns remain consistent across all units, the exterior expressions stand alone through the playful juxtaposition of scale and colour, deploying cementitious panel rain screens as
 framino elements, shringes, benieve and cearles to from individual identities.
- · Goal: Vary the number of attached housing units per block
- The islas are attached by groups of 3 to 5 units.
- Goal: Respond to significant natural topographic features and site buildings to take advantage of slope
- The isla units take advantage of the sloping terrain with basement garages that accommodate the natural topography of the site.
- · Goal: Use entrances, windows, patios and balconies that are clearly visible from and, overlook public sidewalks and open spaces
- Playful openings on the facades are visible from every street.
- The balconies are proudly standing out from the massing and cantilevered over the parking stalls, overlooking the public space.
- · Goal: Reduce building setback where this would improve the relationship between a building and an access route or public road
- On Retoration Way, every second isla unit is completed by an A frame to bring more variety and improve the relationship between the building and the sublic sidewalk.
 These A frames also act as shading devices to provide solar protection as well as weather protection above the entrance.
- Goal: Ensure buildings are designed to receive daylight from at least two sides of a building
- Islas receive daylight from two sides when they are in the middle of the block, or from three sides when they are on the sides.
- Either lower or upper stacked units receive daylight from three sides.
- Goal: All ground-floor units are to be ground-oriented with individual entries to the outside
- Every unit from the stacked units, whether they are on the upper or the lower level, beneficiates from a private entrance from the street.

Each stacked unit represents two distinct volumes, to visually divide at-grade units from upper-level units within the composition. This distinction is achieved through the application of different cladding material and the form of the alternating privacy frames that stop at the L2 balcony level.

Every isla dwelling is also intended to be unique and exude a sense of individuality. To this end, the design incorporates four variations of facades for both street-facing elevations, employing diverse façade elements and cladding. The floor plans and window patterns remain uniform across all isla units.

Site wide podium language is carried over to each block by similarly cladding all basements within a given block. The upper floors stand elegantly above this podium, with cantilevered balconies that float over the parking stall.

SITE

The site features a notable decline in elevation from west to east, with a relatively milder slope from north to south. The design seamlessly integrates the buildings by capitalizing on the site slopgraphy. From the two entrances on Restoration Way, there is a gredual descent by one full level to reach the man internal road, equivalent to the basement level of the islas. Subsequently, the site gentyl solpes down from the main internal road to align with the natural grade of the park on the eastern side.

To accommodate the grade difference, retaining walls run along the eastern and southern boundaries of the parcel, Additionally, the stacked units' gardens are sunken from street level to minimize the height of the retaining walls between the units and the internal road on the northern side.

The site features stair connections at three points, facilitating easy access to and from the surrounding park to the East and South.

COMMON AREAS

Common areas serve as a focal point for fostering community activity and facilitating social gatherings. Central to the site design is a central park space featuring picnic tables and timber trellis, providing unprogrammed recreation opportunities and overlooking a children's play area (1-6 years) with play hut on fiber safety surfacing.

Planting beds features mixture of native and adaptive shrubs, ferns and omamental grasses, and planting bed extensions allow for groundcover planting under car overhangs. To ensure site-wide access, secure and weather protected bike lockers are divided into three rooms strategically distributed across the site. These facilities exclusively serve the stacked units, as the islas contain dedicated bike spaces in their basements. Visitor bicycle parking is distributed throughout the site. The garbage area is divided into two distinct rooms situated at the North and South extremilies of the site.

PROSCENIUM ARCHITECTURE + INTERIORS INC.

BLEAST 2ND AVE

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PCRE GROUP

LADR LANDSCAPE ARCHITECTS

PARALLEL ENGINEERING _

FARHILL ENGINEERING

AVALON MECHANICAL

SITE ELECTRICAL PRIMARY ENGINEERING

CML

ON POINT PROJECT ENGINEERS

CODE

EVOKE BUILDINGS

BERNHARDT CONTRACTING

PROSCENIUM ARCHITECTURE + INTERIORS








ROYAL BAY, COLWOOD

DRAWING TIT	LE		PROJECT NUMBER
PROJE			23-02
STATISTICS			DWG.NO.
			A001
DATE 09/23/2024	SCALE	DRAWN	CHECKED

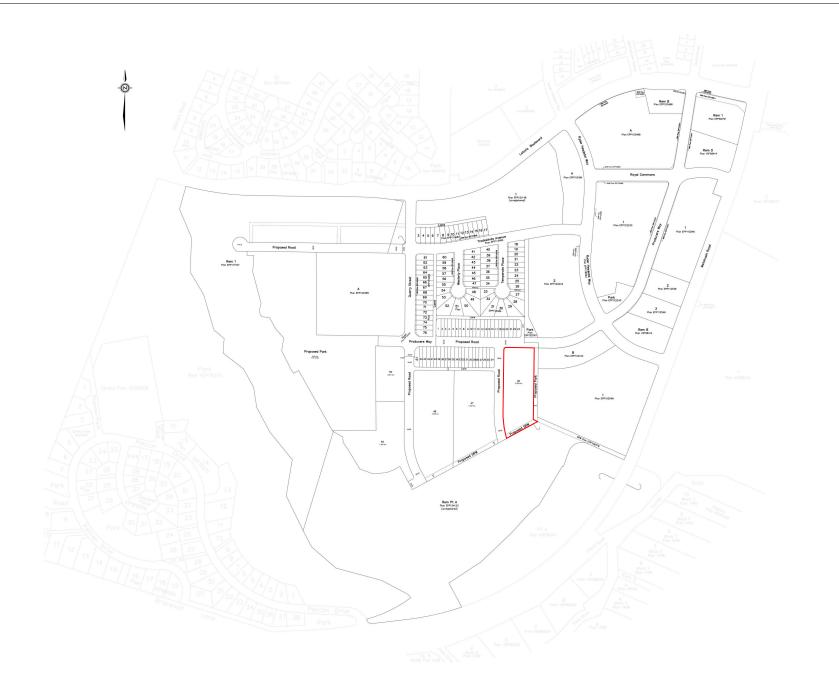

PCRE GROUP

LADR LANDSCAPE ARCHITECTS

BUILDING ELECTRICAL PARALLEL ENGINEERING

STRUCTURAL FARHILL ENGINEERING

MECHANICAL AVALON MECHANICAL

SITE ELECTRICAL
PRIMARY ENGINEERING

ON POINT PROJECT ENGINEERS

GEOTECH CODE

BUILDING ENVELOPE EVOKE BUILDINGS


EVORE BUILDINGS
ENERGY MODEL
BERNHARDT CONTRACTING
INTERIOR DESIGN
PROSCENIUM ARCHITECTURE + INTERIORS

BY DATE



PROJECT ADDRESS ROYAL BAY, COLWOOD

DEVELO PLAN (F	PMENT	PR	23-0;
INFO ONLY)		Å	⁰⁰⁰
DATE	SCALE	DRAWN	CHECKED

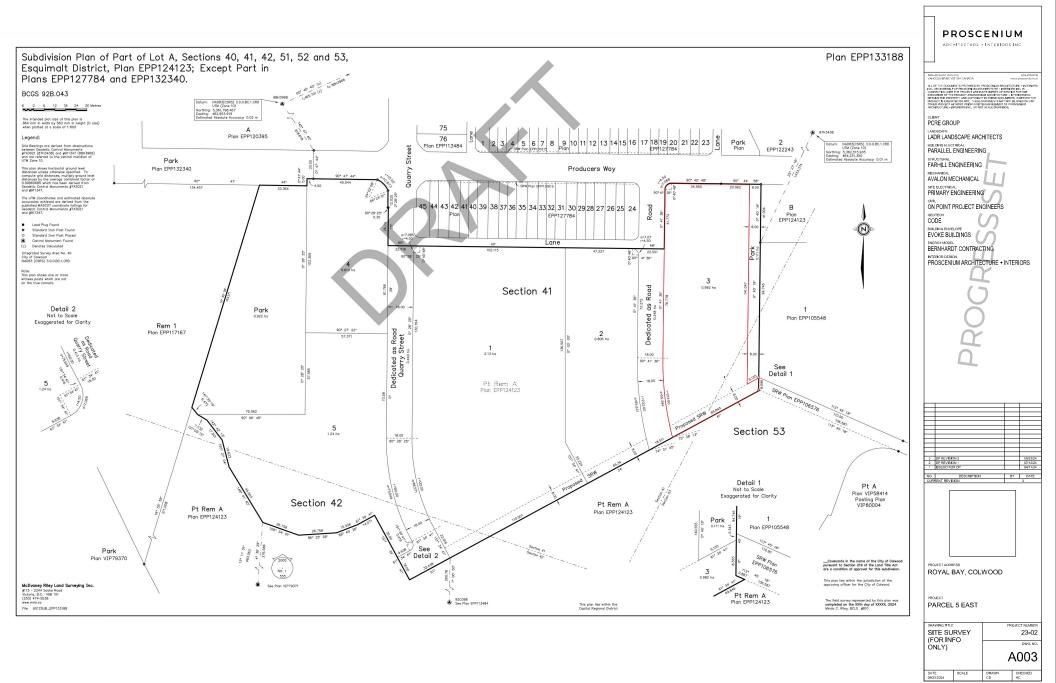



VIEW 1 - THE NORTHERN UNITS ON THE CORNER OF PRODUCERS WAY / RESTORATION WAY




VIEW 3 - THE NORTHERN STACKED UNITS ON PRODUCERS WAY



VIEW 2 - THE NORTHERN ISLAS ON RESTORATION WAY



VIEW 4 - THE NORTHERN STACKED UNITS FROM THE ENTRANCE OF THE SITE

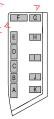

PCRE GROUP

LADR LANDSCAPE ARCHITECTS

PARALLEL ENGINEERING

FARHILL ENGINEERING

AVALON MECHANICAL

SITE ELECTRICAL PRIMARY ENGINEERING

ON POINT PROJECT ENGINEERS

GEOTECH CODE

BUILDING ENVELOPE EVOKE BUILDINGS ENERGY MODEL
BERNHARDT CONTRACTING

INTERIOR DESIGN
PROSCENIUM ARCHITECTURE + INTERIORS

	RENT REVISION		3
NO.	DESCRIPTION	BY	DATE
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1	ISSUED FOR DP		04/11/
2	DP REVISION 1		07/12/
ŝ	DP REVISION 2		09/23/
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PROJECT ADDRESS ROYAL BAY, COLWOOD

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PROPOSED BUILDING RENDERINGS			23-02
			DWG. NO.
			A004
DATE 09/23/2024	SCALE 1:2000	DRAWN	CHECKED



VIEW 1 - THE ISLAS ON RESTORATION WAY




VIEW 3 - THE SITE FROM THE INNER STREET



VIEW 2 - THE SOUTH ENTRANCE OF THE SITE



VIEW 4 - THE ISLAS FROM THE INNER STREET

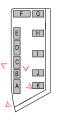

PCRE GROUP

LADR LANDSCAPE ARCHITECTS PARALLEL ENGINEERING

FARHILL ENGINEERING

MECHANICAL AVALON MECHANICAL

SITE ELECTRICAL PRIMARY ENGINEERING

ON POINT PROJECT ENGINEERS GEOTECH CODE

BUILDING ENVELOPE EVOKE BUILDINGS

ENERGY MODEL
BERNHARDT CONTRACTING INTERIOR DESIGN
PROSCENIUM ARCHITECTURE + INTERIORS



PROJECT ADDRESS ROYAL BAY, COLWOOD

DRAWING TITLE			
			PROJECT NUMBER
PROPOSED BUILDING RENDERINGS			23-02
			DWG.NO.
			A005
DATE	SCALE 4 - 2000	DRAWN	CHECKED
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VIEW 1 - THE PLAYGROUND FROM THE INNER STREET




VIEW 3 - THE STACKED UNITS FROM THE PARK



VIEW 2 - THE PLAYGROUND FROM THE PARK



VIEW 4 - THE STACKED UNITS FROM THE INNER STREET

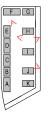

PCRE GROUP

LADR LANDSCAPE ARCHITECTS

PARALLEL ENGINEERING

FARHILL ENGINEERING

MECHANICAL AVALON MECHANICAL

SITE ELECTRICAL PRIMARY ENGINEERING


ON POINT PROJECT ENGINEERS

GEOTECH CODE

BUILDING ENVELOPE EVOKE BUILDINGS

ENERGY MODEL
BERNHARDT CONTRACTING

INTERIOR DESIGN
PROSCENIUM ARCHITECTURE + INTERIORS

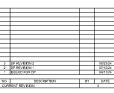



PROJECT ADDRESS ROYAL BAY, COLWOOD

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DRAWING TITL	E		PROJECT NUMBER
PROPOSED BUILDING RENDERINGS			23-02
			DWG.NO.
			A006
DATE 09/23/2024	SCALE 1:2000	DRAWN CD	CHECKED



VIEW 1 - THE ACCESSORY BUILDINGS 4 AND 5 FROM THE PEDESTRIAN PATH




VIEW 3 - THE ACCESSORY BUILDINGS 1 AND 2 FROM THE INNER STREET



VIEW 2 - THE GAZEBO FROM THE PLAYGROUND



VIEW 4 - THE ACCESSORY BUILDING 3 FROM THE INNER STREET

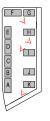

PCRE GROUP

LADR LANDSCAPE ARCHITECTS

BUILDING ELECTRICAL PARALLEL ENGINEERING

FARHILL ENGINEERING

MECHANICAL AVALON MECHANICAL

SITE ELECTRICAL PRIMARY ENGINEERING

ON POINT PROJECT ENGINEERS

GEOTECH CODE

BUILDING ENVELOPE EVOKE BUILDINGS

ENERGY MODEL
BERNHARDT CONTRACTING

INTERIOR DESIGN
PROSCENIUM ARCHITECTURE + INTERIORS





PROJECT ADDRESS ROYAL BAY, COLWOOD

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DATE 09/23/2024	SCALE 1:2000	DRAWN	CHECKED



PCRE GROUP

LADR LANDSCAPE ARCHITECTS

BUILDING ELECTRICAL PARALLEL ENGINEERING

FARHILL ENGINEERING

AVALON MECHANICAL

SITE ELECTRICAL PRIMARY ENGINEERING

ON POINT PROJECT ENGINEERS

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BUILDING ENVELOPE EVOKE BUILDINGS

BERNHARDT CONTRACTING
INTERIOR DESIGN
PROSCENIUM ARCHITECTURE + INTERIORS








PROJECT ADDRESS ROYAL BAY, COLWOOD


PROJECT
PARCEL 5 EAST

	DRAWING TITLE			
DRAWING TITL	E		PROJECT NUMBER	
SITE PLAN			23-02	
			DWG.NO.	
			A100	
DATE 09/23/2024	SCALE 1:400	DRAWN CD	CHECKED	



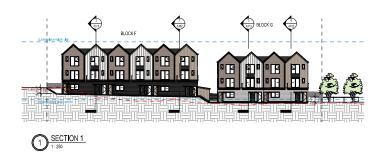




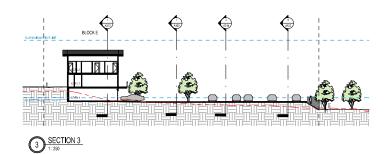





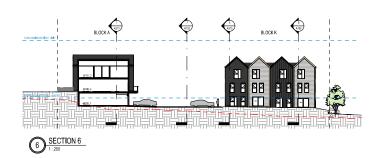

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PCRE GROUP

LADR LANDSCAPE ARCHITECTS

PARALLEL ENGINEERING

FARHILL ENGINEERING

MECHANICAL AVALON MECHANICAL

SITE ELECTRICAL PRIMARY ENGINEERING

ON POINT PROJECT ENGINEERS

GEOTECH CODE

BUILDING ENVELOPE EVOKE BUILDINGS

ENERGY MODEL
BERNHARDT CONTRACTING

INTERIOR DESIGN
PROSCENIUM ARCHITECTURE + INTERIORS

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PROJECT ADDRESS ROYAL BAY, COLWOOD

PROJECT PARCEL 5 EAST

SITE SECTIONS


A101

ATE SCALE DRAWN CHECKED HC CD HC

23-02





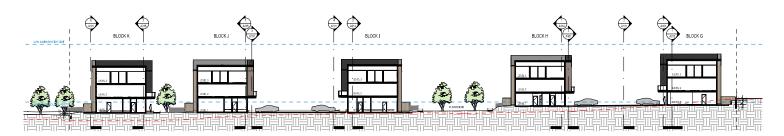



PCRE GROUP

LADR LANDSCAPE ARCHITECTS

BUILDING ELECTRICAL PARALLEL ENGINEERING

STRUCTURAL FARHILL ENGINEERING

AVALON MECHANICAL

SITE ELECTRICAL PRIMARY ENGINEERING

ON POINT PROJECT ENGINEERS

GEOTECH CODE

BUILDING ENVELOPE EVOKE BUILDINGS

EVORE BUILDINGS
ENERGY MODEL
BERNHARDT CONTRACTING
INTERIOR DESIGN
PROSCENIUM ARCHITECTURE + INTERIORS






PROJECT ADDRESS ROYAL BAY, COLWOOD


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SITE SECTIONS			23-02
			DWG.NO.
			A102
DATE	SCALE	DRAWN	CHECKED





BLOCK A - WEST ELEVATION



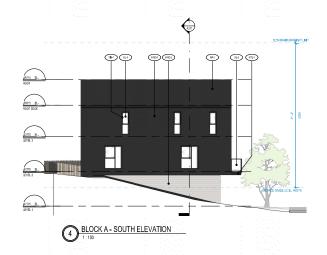

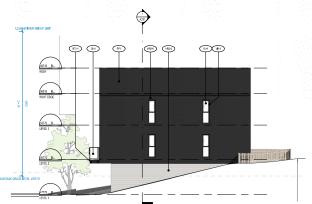

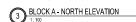

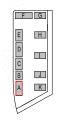

EXTERIOR FINISHES

HRD-1	CEMENT PANEL HORIZONTAL - TAUPE
HRD-2	CEMENT PANEL HORIZONTAL - LIGHT GREY
HRD-3	CEMENT PANEL VERTICAL - BEIGE
HRD-4	CEMENT PANEL VERTICAL - BLACK
HRD-5	CEMENT PANEL SHINGLES - BLACK
HRD-6	CEMENT PANEL HORIZONTAL - DARK GREY
HRD-7	CEMENT PANEL VERTICAL - WHITE
HRD-8	CEMENT PANEL HORIZONTAL - WHITE

-1 VERTICAL WOODEN SHADING SCREEN

MTL-1 METAL FLASHING - CHARCOAL MTL-2 METAL FLASHING - BEIGE

F-1 ASPHALT SHINGLES ROOFING - DARK GREY F-2 ASPHALT SHINGLES ROFFING - LIGHT GREY

INSULATED GLAZING UNIT (VISION GLASS)
INSULATED GLAZING UNIT (FROSTED GLASS)
GLASS GUARDRAIL (TEMPERED, LAMINATED)

VINYL WINDOWS - BLACK

PROSCENIUM ARCHITECTURE + INTERIORS INC.

WANCOVEREC VETTE CAMICA

ALLO PIE DOCUMENTS PREPINED BY PROSCINUM ARCHITECTURE - INTERDR

NO, ON CHEARLY OF PROSCINUM ARCHITECTURE - INTERDRE NO.

ON CHEARLY OF PROSCINUM ARCHITECTURE - INTERDRE NO.

DESCURING OF THE PROSCINUM ARCHITECTURE - INTERDRE NO.

BETWARD THE PROSCINUM ARCHITECTURE - INTERDRE NO.

BETWARD THE PROSCINUM ARCHITECTURE - INTERDRE NO.

BETWARD THE PROSCINUM ARCHITECTURE - INTERDRE NO.

ARCHITECTURE - PROSPERIE NO. DOUGHT TO MAY DE CHEARLY OR ARCHITECTURE
PROSCINUM ARCHITECTURE - PROSPERIE NO. DOUGHT SALA (DEVONING OCCUMENT

ARCHITECTURE - PROSPERIE NO.

PCRE GROUP

LADR LANDSCAPE ARCHITECTS

PARALLEL ENGINEERING

FARHILL ENGINEERING

AVALON MECHANICAL

SITE ELECTRICAL
PRIMARY ENGINEERING
CML
ON POINT PROJECT ENGINEERS

GEOTECH CODE

BUILDING ENVELOPE EVOKE BUILDINGS

ENERGY MODEL
BERNHARDT CONTRACTING

NTERIOR DESIGN PROSCENIUM ARCHITECTURE + INTERIORS



ROYAL BAY, COLWOOD

PARCEL 5 EAST

 DRAWING TILE
 FROJECT NUMBER

 ELEVATIONS
 23-02


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 DWG NO.


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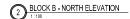



BLOCK B - WEST ELEVATION 1: 100





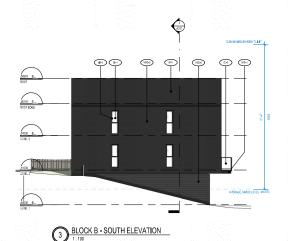

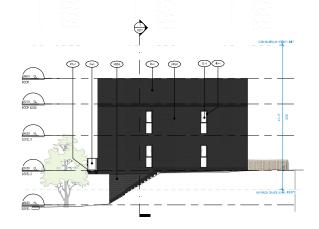

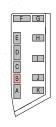

EXTERIOR FINISHES

HRD-1	CEMENT PANEL HORIZONTAL - TAUPE
HRD-2	CEMENT PANEL HORIZONTAL - LIGHT GREY
HRD-3	CEMENT PANEL VERTICAL - BEIGE
HRD-4	CEMENT PANEL VERTICAL - BLACK
HRD-5	CEMENT PANEL SHINGLES - BLACK
HRD-6	CEMENT PANEL HORIZONTAL - DARK GREY
HRD-7	CEMENT PANEL VERTICAL - WHITE
HRD-8	CEMENT PANEL HORIZONTAL - WHITE

VERTICAL WOODEN SHADING SCREEN

METAL FLASHING - CHARCOAL METAL FLASHING - BEIGE

ASPHALT SHINGLES ROOFING - DARK GREY ASPHALT SHINGLES ROFFING - LIGHT GREY

INSULATED GLAZING UNIT (VISION GLASS) INSULATED GLAZING UNIT (FROSTED GLASS) GLASS GUARDRAIL (TEMPERED, LAMINATED)

VINYL WINDOWS -BLACK

PROSCENIUM ARCHITECTURE + INTERIORS INC.

PCRE GROUP

LADR LANDSCAPE ARCHITECTS

PARALLEL ENGINEERING

FARHILL ENGINEERING

AVALON MECHANICAL


SITE ELECTRICAL PRIMARY ENGINEERING

ON POINT PROJECT ENGINEERS

GEOTECH CODE

BUILDING ENVELOPE EVOKE BUILDINGS

ENERGY MODEL
BERNHARDT CONTRACTING
INTERIOR DESIGN
PROSCENIUM ARCHITECTURE + INTERIORS

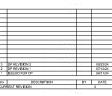




ROYAL BAY, COLWOOD


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DATE 09/23/2024	SCALE As indicated	DRAWN	CHECKED








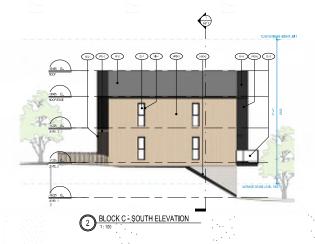

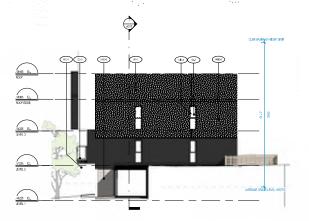

BLOCK C - NORTH ELEVATION

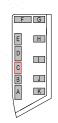

EXTERIOR FINISHES

HRD-1	CEMENT PANEL HORIZONTAL - TAUPE
HRD-2	CEMENT PANEL HORIZONTAL - LIGHT GREY
HRD-3	CEMENT PANEL VERTICAL - BEIGE
HRD-4	CEMENT PANEL VERTICAL - BLACK
HRD-5	CEMENT PANEL SHINGLES - BLACK
HRD-6	CEMENT PANEL HORIZONTAL - DARK GREY
HRD-7	CEMENT PANEL VERTICAL - WHITE

HRD-8 CEMENT PANEL HORIZONTAL - WHITE

WD-1 VERTICAL WOODEN SHADING SCREEN

METAL FLASHING - CHARCOAL METAL FLASHING - BEIGE ASPHALT SHINGLES ROOFING - DARK GREY ASPHALT SHINGLES ROFFING - LIGHT GREY

INSULATED GLAZING UNIT (VISION GLASS) INSULATED GLAZING UNIT (FROSTED GLASS) GLASS GUARDRAIL (TEMPERED, LAMINATED)

VINYL WINDOWS -BLACK

PROSCENIUM ARCHITECTURE + INTERIORS INC.

PCRE GROUP

LADR LANDSCAPE ARCHITECTS

PARALLEL ENGINEERING

FARHILL ENGINEERING

MECHANICAL AVALON MECHANICAL

PRIMARY ENGINEERING

ON POINT PROJECT ENGINEERS

GEOTECH CODE

BUILDING ENVELOPE EVOKE BUILDINGS

ENERGY MODEL
BERNHARDT CONTRACTING

INTERIOR DESIGN
PROSCENIUM ARCHITECTURE + INTERIORS







ROYAL BAY, COLWOOD


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DECON	•	100	DWG.NO.
			A302
DATE 09/23/2024	SCALE As indicated	DRAWN CD	CHECKED HC





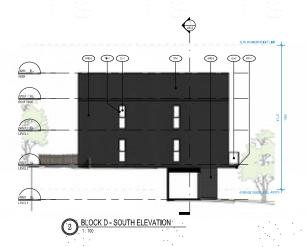

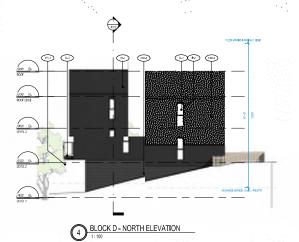

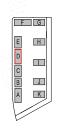

D-1	CEMENT PANEL HORIZONTAL - TAUPE	
D-2	CEMENT PANEL HORIZONTAL - LIGHT GREY	
D-3	CEMENT PANEL VERTICAL - BEIGE	
D-4	CEMENT PANEL VERTICAL - BLACK	
D-5	CEMENT PANEL SHINGLES - BLACK	
D-6	CEMENT PANEL HORIZONTAL - DARK GREY	
D-7	CEMENT PANEL VERTICAL - WHITE	
D-8	CEMENT PANEL HORIZONTAL - WHITE	

VERTICAL WOODEN SHADING SCREEN

WD-1 METAL FLASHING - CHARCOAL METAL FLASHING - BEIGE

VINYL WINDOWS -BLACK

ASPHALT SHINGLES ROOFING - DARK GREY ASPHALT SHINGLES ROFFING - LIGHT GREY

INSULATED GLAZING UNIT (VISION GLASS) INSULATED GLAZING UNIT (FROSTED GLASS) GLASS GUARDRAIL (TEMPERED, LAMINATED)

PROSCENIUM ARCHITECTURE + INTERIORS INC.

PCRE GROUP

LADR LANDSCAPE ARCHITECTS

PARALLEL ENGINEERING

FARHILL ENGINEERING

AVALON MECHANICAL

SITE ELECTRICAL PRIMARY ENGINEERING

ON POINT PROJECT ENGINEERS

GEOTECH CODE

BUILDING ENVELOPE EVOKE BUILDINGS

ENERGY MODEL
BERNHARDT CONTRACTING

INTERIOR DESIGN
PROSCENIUM ARCHITECTURE + INTERIORS

BY DATE



ROYAL BAY, COLWOOD

PARCEL 5 EAST

ELEVATIONS BLOCK D


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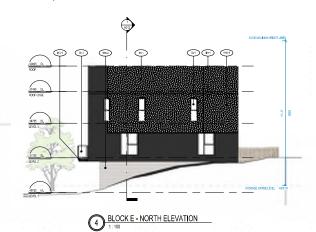
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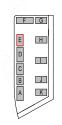










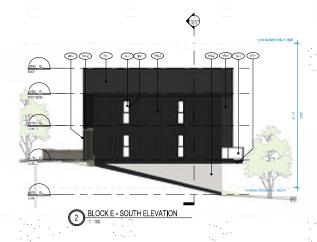

HRD-1	CEMENT PANEL HORIZONTAL - TAUPE
HRD-2	CEMENT PANEL HORIZONTAL - LIGHT GREY
HRD-3	CEMENT PANEL VERTICAL - BEIGE
HRD-4	CEMENT PANEL VERTICAL - BLACK
HRD-5	CEMENT PANEL SHINGLES - BLACK
HRD-6	CEMENT PANEL HORIZONTAL - DARK GREY
HRD-7	CEMENT PANEL VERTICAL - WHITE

HRD-8 CEMENT PANEL HORIZONTAL - WHITE WD-1 VERTICAL WOODEN SHADING SCREEN

METAL FLASHING - CHARCOAL METAL FLASHING - BEIGE

ASPHALT SHINGLES ROOFING - DARK GREY ASPHALT SHINGLES ROFFING - LIGHT GREY

INSULATED GLAZING UNIT (VISION GLASS) INSULATED GLAZING UNIT (FROSTED GLASS) GLASS GUARDRAIL (TEMPERED, LAMINATED)

VINYL WINDOWS -BLACK

PROSCENIUM ARCHITECTURE + INTERIORS INC.

PCRE GROUP

LADR LANDSCAPE ARCHITECTS

PARALLEL ENGINEERING

FARHILL ENGINEERING

AVALON MECHANICAL

SITE ELECTRICAL PRIMARY ENGINEERING

ON POINT PROJECT ENGINEERS

GEOTECH CODE

BUILDING ENVELOPE EVOKE BUILDINGS

ENERGY MODEL
BERNHARDT CONTRACTING

INTERIOR DESIGN
PROSCENIUM ARCHITECTURE + INTERIORS







ROYAL BAY, COLWOOD


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ELEVATIONS BLOCK E		1000	23-02
5500		100	DWG.NO.
			A304
DATE	SCALE	DRAWN	CHECKED



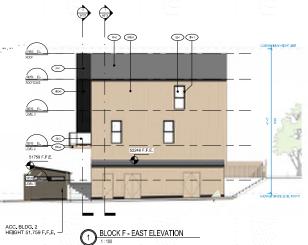



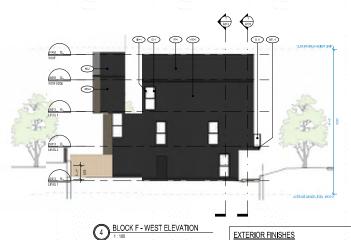

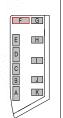

- CEMENT PANEL HORIZONTAL TAUPE CEMENT PANEL HORIZONTAL LIGHT GREY CEMENT PANEL VERTICAL BEIGHT CEMENT PANEL VERTICAL BLACK CEMENT PANEL SINICIES BLACK CEMENT PANEL VERTICAL DAPK GREY CEMENT PANEL VERTICAL WHITE CEMENT PANEL HORIZONTAL DAPK GREY CEMENT PANEL HORIZONTAL WHITE CEMENT PANEL HORIZONTAL WHITE HRD-1 HRD-2 HRD-3 HRD-4 HRD-5 HRD-6 HRD-7 HRD-8
- WD-1 VERTICAL WOODEN SHADING SCREEN
- METAL FLASHING CHARCOAL METAL FLASHING BEIGE

VINYL WINDOWS - BLACK

- ASPHALT SHINGLES ROOFING DARK GREY ASPHALT SHINGLES ROFFING LIGHT GREY
- INSULATED GLAZING UNIT (VISION GLASS) INSULATED GLAZING UNIT (FROSTED GLASS) GLASS GUARDRAIL (TEMPERED, LAMINATED)

PROSCENIUM ARCHITECTURE + INTERIORS INC.

PCRE GROUP

LADR LANDSCAPE ARCHITECTS

PARALLEL ENGINEERING

FARHILL ENGINEERING

MECHANICAL AVALON MECHANICAL

SITE ELECTRICAL PRIMARY ENGINEERING

ON POINT PROJECT ENGINEERS

CODE

BUILDING ENVELOPE EVOKE BUILDINGS

ENERGY MODEL
BERNHARDT CONTRACTING

INTERIOR DESIGN
PROSCENIUM ARCHITECTURE + INTERIORS







ROYAL BAY, COLWOOD


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BEGGIN			A305		
DATE	SCALE As indicated	DRAWN	CHECKED		



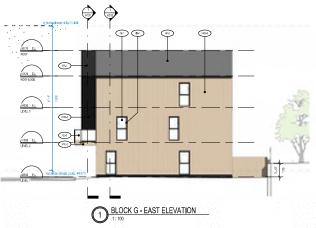



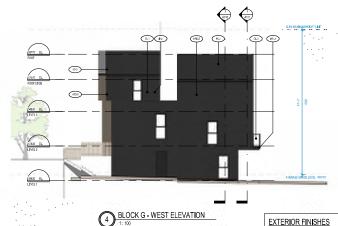

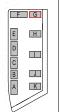

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- VERTICAL WOODEN SHADING SCREEN
- WD-1 METAL FLASHING - CHARCOAL METAL FLASHING - BEIGE
- ASPHALT SHINGLES ROOFING DARK GREY ASPHALT SHINGLES ROFFING LIGHT GREY
- INSULATED GLAZING UNIT (VISION GLASS) INSULATED GLAZING UNIT (FROSTED GLASS) GLASS GUARDRAIL (TEMPERED, LAMINATED)
- VINYL WINDOWS BLACK

PROSCENIUM ARCHITECTURE + INTERIORS INC.

PCRE GROUP

LADR LANDSCAPE ARCHITECTS

PARALLEL ENGINEERING

FARHILL ENGINEERING

AVALON MECHANICAL

SITE ELECTRICAL PRIMARY ENGINEERING

ON POINT PROJECT ENGINEERS

GEOTECH CODE

BUILDING ENVELOPE EVOKE BUILDINGS

ENERGY MODEL
BERNHARDT CONTRACTING

INTERIOR DESIGN
PROSCENIUM ARCHITECTURE + INTERIORS







ROYAL BAY, COLWOOD

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			A306
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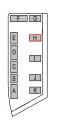






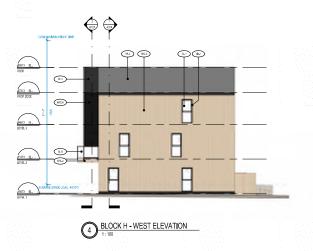

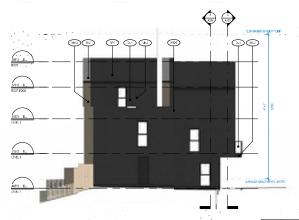BLOCK H - EAST ELEVATION



EXTERIOR FINISHES

- CEMENT PANEL HORIZONTAL TAUPE CEMENT PANEL HORIZONTAL LIGHT GREY CEMENT PANEL VERTICAL BEIGHT CEMENT PANEL VERTICAL BLACK CEMENT PANEL SINICIES BLACK CEMENT PANEL HORIZONTAL DARK GREY CEMENT PANEL HORIZONTAL DARK GREY CEMENT PANEL HORIZONTAL WHITE CEMENT PANEL HORIZONTAL WHITE
- WD-1 VERTICAL WOODEN SHADING SCREEN
- METAL FLASHING CHARCOAL METAL FLASHING BEIGE ASPHALT SHINGLES ROOFING - DARK GREY ASPHALT SHINGLES ROFFING - LIGHT GREY
- INSULATED GLAZING UNIT (VISION GLASS) INSULATED GLAZING UNIT (FROSTED GLASS) GLASS GUARDRAIL (TEMPERED, LAMINATED)
- VINYL WINDOWS BLACK

PROSCENIUM ARCHITECTURE + INTERIORS INC.

PCRE GROUP

LADR LANDSCAPE ARCHITECTS

PARALLEL ENGINEERING

FARHILL ENGINEERING

AVALON MECHANICAL

SITE ELECTRICAL
PRIMARY ENGINEERING

ON POINT PROJECT ENGINEERS

GEOTECH CODE

BUILDING ENVELOPE EVOKE BUILDINGS

ENERGY MODEL
BERNHARDT CONTRACTING

INTERIOR DESIGN
PROSCENIUM ARCHITECTURE + INTERIORS






ROYAL BAY, COLWOOD

DANTE SPALE DRAIN OMEONED	l .			
BLOCK H DING, HO, A307 DATE SCALE DRAWN CHECKED	DRAWING TITE	E .	1000000	PROJECT NUMBER
DATE SCALE DRAWN CHECKED			100	23-02
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			1000	, 1001
	DATE 09/23/2024	SCALE As indicated	DRAWN CD	CHECKED







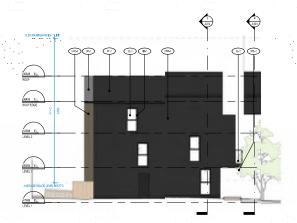

BLOCK I - WEST ELEVATION



EXTERIOR FINISHES

- CEMENT PANEL HORIZONTAL TAUPE CEMENT PANEL HORIZONTAL LIGHT GREY CEMENT PANEL VERTICAL BEIGHT CEMENT PANEL VERTICAL BLACK CEMENT PANEL SINICIES BLACK CEMENT PANEL HORIZONTAL DARK GREY CEMENT PANEL HORIZONTAL DARK GREY CEMENT PANEL HORIZONTAL WHITE CEMENT PANEL HORIZONTAL WHITE HRD-1 HRD-2 HRD-3 HRD-4 HRD-5 HRD-6 HRD-7 HRD-8
- WD-1 VERTICAL WOODEN SHADING SCREEN
- METAL FLASHING CHARCOAL METAL FLASHING BEIGE ASPHALT SHINGLES ROOFING - DARK GREY ASPHALT SHINGLES ROFFING - LIGHT GREY
- INSULATED GLAZING UNIT (VISION GLASS) INSULATED GLAZING UNIT (FROSTED GLASS) GLASS GUARDRAIL (TEMPERED, LAMINATED)
- VINYL WINDOWS BLACK

PROSCENIUM ARCHITECTURE + INTERIORS INC.

PCRE GROUP

LADR LANDSCAPE ARCHITECTS

PARALLEL ENGINEERING

FARHILL ENGINEERING

MECHANICAL AVALON MECHANICAL

SITE ELECTRICAL
PRIMARY ENGINEERING

ON POINT PROJECT ENGINEERS

GEOTECH CODE

BUILDING ENVELOPE EVOKE BUILDINGS

ENERGY MODEL
BERNHARDT CONTRACTING

INTERIOR DESIGN
PROSCENIUM ARCHITECTURE + INTERIORS

BY DATE




ROYAL BAY, COLWOOD

PARCEL 5 EAST


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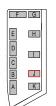




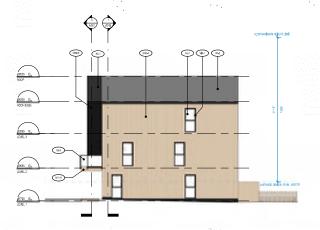

BLOCK J - WEST ELEVATION



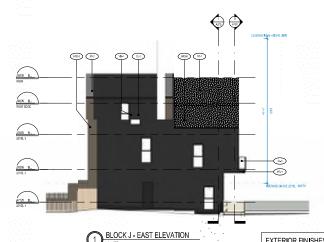

EXTERIOR FINISHES

CEMENT PANEL HORIZONTAL - TAUPE CEMENT PANEL HORIZONTAL - LIGHT GREY CEMENT PANEL VERTICAL - BEIGHT CEMENT PANEL VERTICAL - BLACK CEMENT PANEL SINICIES - BLACK CEMENT PANEL HORIZONTAL - DARK GREY CEMENT PANEL HORIZONTAL - DARK GREY CEMENT PANEL HORIZONTAL - WHITE CEMENT PANEL HORIZONTAL - WHITE

VERTICAL WOODEN SHADING SCREEN

WD-1 METAL FLASHING - CHARCOAL METAL FLASHING - BEIGE

ASPHALT SHINGLES ROOFING - DARK GREY ASPHALT SHINGLES ROFFING - LIGHT GREY

INSULATED GLAZING UNIT (VISION GLASS) INSULATED GLAZING UNIT (FROSTED GLASS) GLASS GUARDRAIL (TEMPERED, LAMINATED)

VINYL WINDOWS - BLACK

PROSCENIUM

ARCHITECTURE + INTERIORS INC.

PCRE GROUP

LADR LANDSCAPE ARCHITECTS

PARALLEL ENGINEERING

FARHILL ENGINEERING

AVALON MECHANICAL

PRIMARY ENGINEERING

ON POINT PROJECT ENGINEERS

GEOTECH CODE

BUILDING ENVELOPE EVOKE BUILDINGS

BERNHARDT CONTRACTING

INTERIOR DESIGN PROSCENIUM ARCHITECTURE + INTERIORS

BY DATE




ROYAL BAY, COLWOOD

PARCEL 5 EAST

ELEVATIONS 23-02 BLOCK J DWG.NO A309






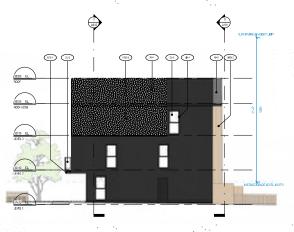

BLOCK K - WEST ELEVATION

1: 100



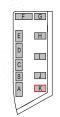

D-1	CEMENT PANEL HORIZONTAL - TAUPE
D-2	CEMENT PANEL HORIZONTAL - LIGHT GREY
D-3	CEMENT PANEL VERTICAL - BEIGE
04	CEMENT PANEL VERTICAL - BLACK
D-5	CEMENT PANEL SHINGLES - BLACK
D-6	CEMENT PANEL HORIZONTAL - DARK GREY
D-7	CEMENT PANEL VERTICAL - WHITE

HRD-8 CEMENT PANEL HORIZONTAL - WHITE VERTICAL WOODEN SHADING SCREEN

WD-1 METAL FLASHING - CHARCOAL METAL FLASHING - BEIGE

ASPHALT SHINGLES ROOFING - DARK GREY ASPHALT SHINGLES ROFFING - LIGHT GREY

INSULATED GLAZING UNIT (VISION GLASS) INSULATED GLAZING UNIT (FROSTED GLASS) GLASS GUARDRAIL (TEMPERED, LAMINATED)

VINYL WINDOWS -BLACK

PROSCENIUM ARCHITECTURE + INTERIORS INC.

PCRE GROUP

LADR LANDSCAPE ARCHITECTS

PARALLEL ENGINEERING

FARHILL ENGINEERING

AVALON MECHANICAL

PRIMARY ENGINEERING

ON POINT PROJECT ENGINEERS

GEOTECH CODE

BUILDING ENVELOPE EVOKE BUILDINGS

ENERGY MODEL
BERNHARDT CONTRACTING


INTERIOR DESIGN
PROSCENIUM ARCHITECTURE + INTERIORS


BY DATE





ROYAL BAY, COLWOOD

DRAWING TITLE		10, 5, 10, 91	PROJECT NUMBER
ELEVAT BLOCK		1000	23-02
BLOCK I		1000	. DWG.NO
			A310
DATE 09/23/2024	SCALE As indicated	DRAWN CD	HC

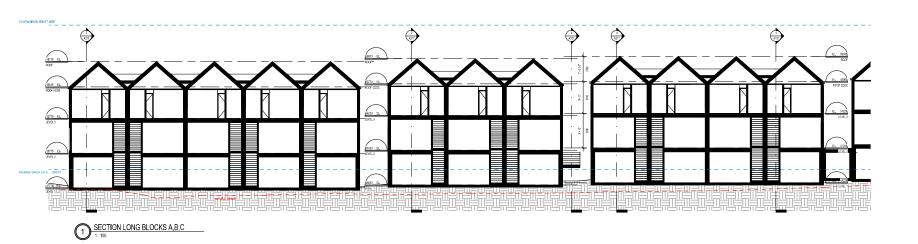

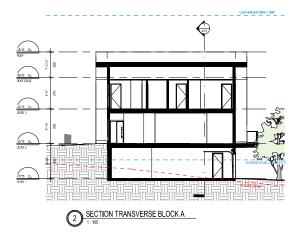

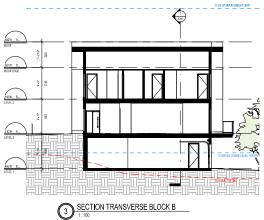

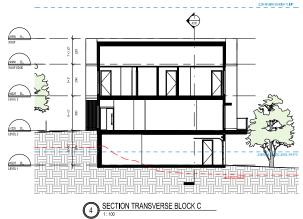



PCRE GROUP

LADR LANDSCAPE ARCHITECTS

PARALLEL ENGINEERING

FARHILL ENGINEERING MECHANICAL AVALON MECHANICAL

SITE ELECTRICAL PRIMARY ENGINEERING

ON POINT PROJECT ENGINEERS

GEOTECH CODE

BUILDING ENVELOPE EVOKE BUILDINGS

EVOICE DOLLDINGS
ENERGY MODEL
BERNHARDT CONTRACTING
INTERIOR DESIGN
PROSCENIUM ARCHITECTURE + INTERIORS






PROJECT ADDRESS ROYAL BAY, COLWOOD

PROJECT PARCEL 5 EAST

BUILDING SECTIONS 23-02 A311

FG Н J K



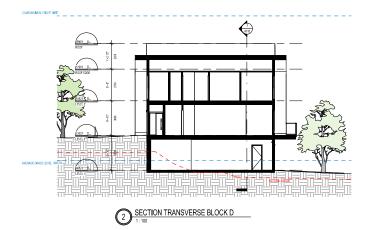



PCRE GROUP

LADR LANDSCAPE ARCHITECTS

PARALLEL ENGINEERING

FARHILL ENGINEERING

MECHANICAL AVALON MECHANICAL

SITE ELECTRICAL PRIMARY ENGINEERING

ON POINT PROJECT ENGINEERS

GEOTECH CODE

BUILDING ENVELOPE EVOKE BUILDINGS

ENERGY MODEL
BERNHARDT CONTRACTING

INTERIOR DESIGN
PROSCENIUM ARCHITECTURE + INTERIORS

BY DATE



PROJECT ADDRESS ROYAL BAY, COLWOOD


PROJECT PARCEL 5 EAST

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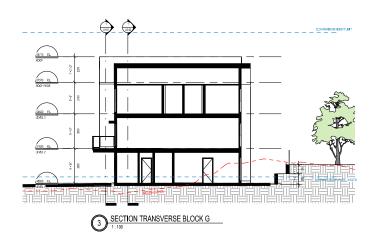
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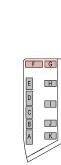
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BUILDING SECTIONS			23-02
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PCRE GROUP

LADR LANDSCAPE ARCHITECTS

PARALLEL ENGINEERING

FARHILL ENGINEERING

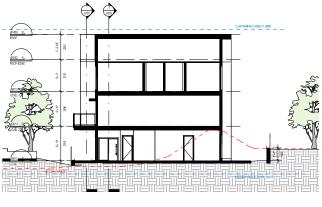MECHANICAL AVALON MECHANICAL

SITE ELECTRICAL PRIMARY ENGINEERING

ON POINT PROJECT ENGINEERS

CODE

BUILDING ENVELOPE EVOKE BUILDINGS

ENERGY MODEL
BERNHARDT CONTRACTING

INTERIOR DESIGN
PROSCENIUM ARCHITECTURE + INTERIORS

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ROYAL BAY, COLWOOD


PROJECT PARCEL 5 EAST

DEADNING TITLE
BUILDING
SECTIONS
PROJECT NAMEER
23-02
DWG-NGA313







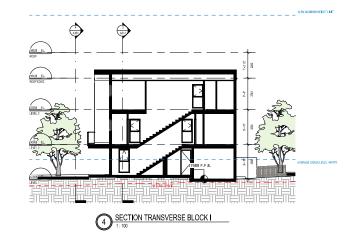



PROSCENIUM

Jacob Monta Charles Control Co





ROYAL BAY, COLWOOD

PROJECT
PARCEL 5 EAST

FG


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			A314
DATE 09/23/2024	SCALE As indicated	DRAWN CD	CHECKED







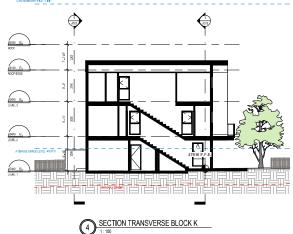

SECTION LONG BLOCK K



PCRE GROUP

LADR LANDSCAPE ARCHITECTS

PARALLEL ENGINEERING

FARHILL ENGINEERING

MECHANICAL AVALON MECHANICAL

SITE ELECTRICAL PRIMARY ENGINEERING

ON POINT PROJECT ENGINEERS

GEOTECH CODE

BUILDING ENVELOPE EVOKE BUILDINGS

ENERGY MODEL
BERNHARDT CONTRACTING

INTERIOR DESIGN
PROSCENIUM ARCHITECTURE + INTERIORS




PROJECT ADDRESS
ROYAL BAY, COLWOOD


PROJECT PARCEL 5 EAST

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Н J

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BUILDIN			23-02
	•0		DWG.NO.
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DATE 09/23/2024	SCALE As indicated	DRAWN CD	CHECKED



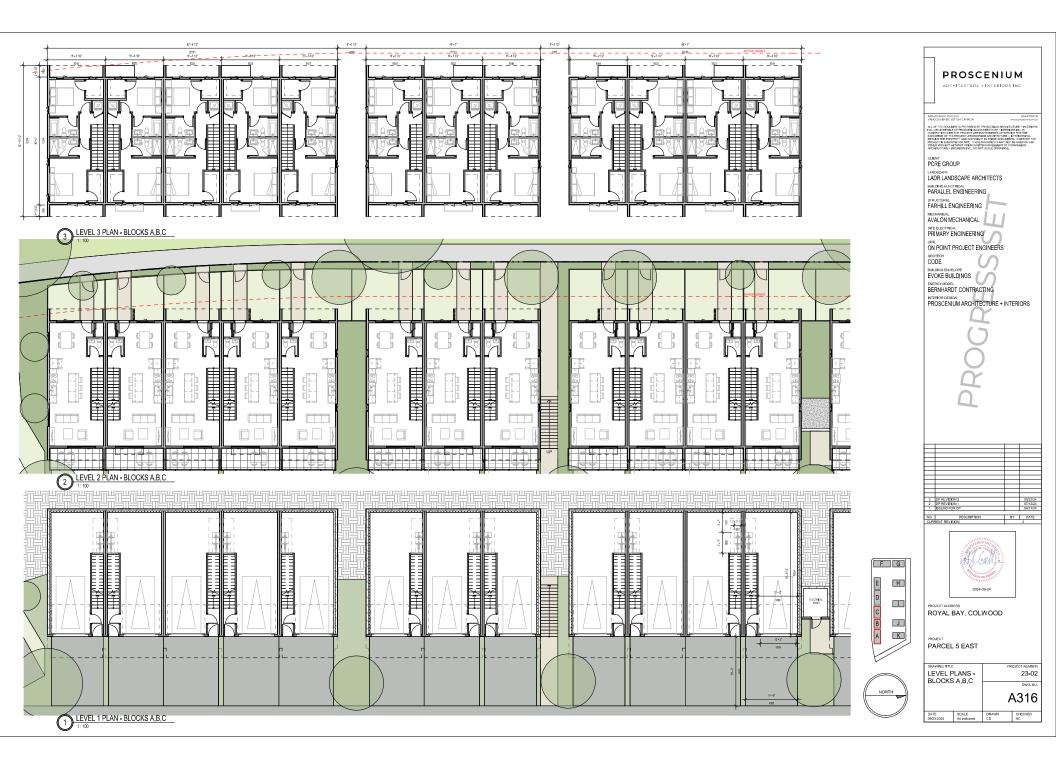

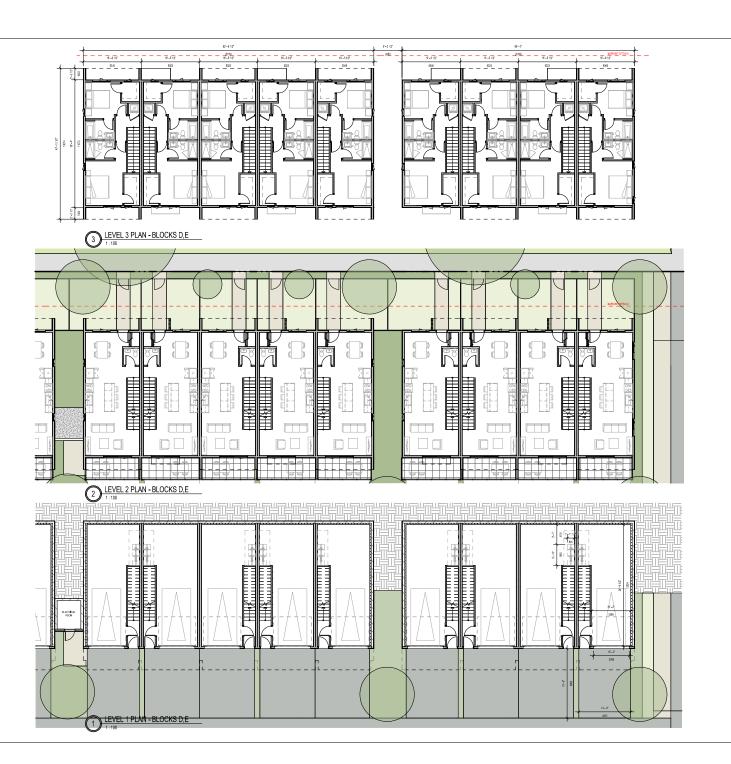PCRE GROUP

LADR LANDSCAPE ARCHITECTS

PARALLEL ENGINEERING

FARHILL ENGINEERING

MECHANICAL AVALON MECHANICAL SITE ELECTRICAL
PRIMARY ENGINEERING

ON POINT PROJECT ENGINEERS

GEOTECH CODE

BUILDING ENVELOPE EVOKE BUILDINGS

ENERGY MODEL
BERNHARDT CONTRACTING

PROSCENIUM ARCHITECTURE + INTERIORS





ROYAL BAY, COLWOOD

PARCEL 5 EAST





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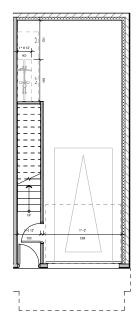
J K

LEVEL	RAWING TILE LEVEL PLANS - BLOCKS D,E		PROJECT NUMBER 23-02
DECOR	O D,L		DWG.NO.
			A317
DATE 09/23/2024	SCALE As indicated	DRAWN CD	CHECKED






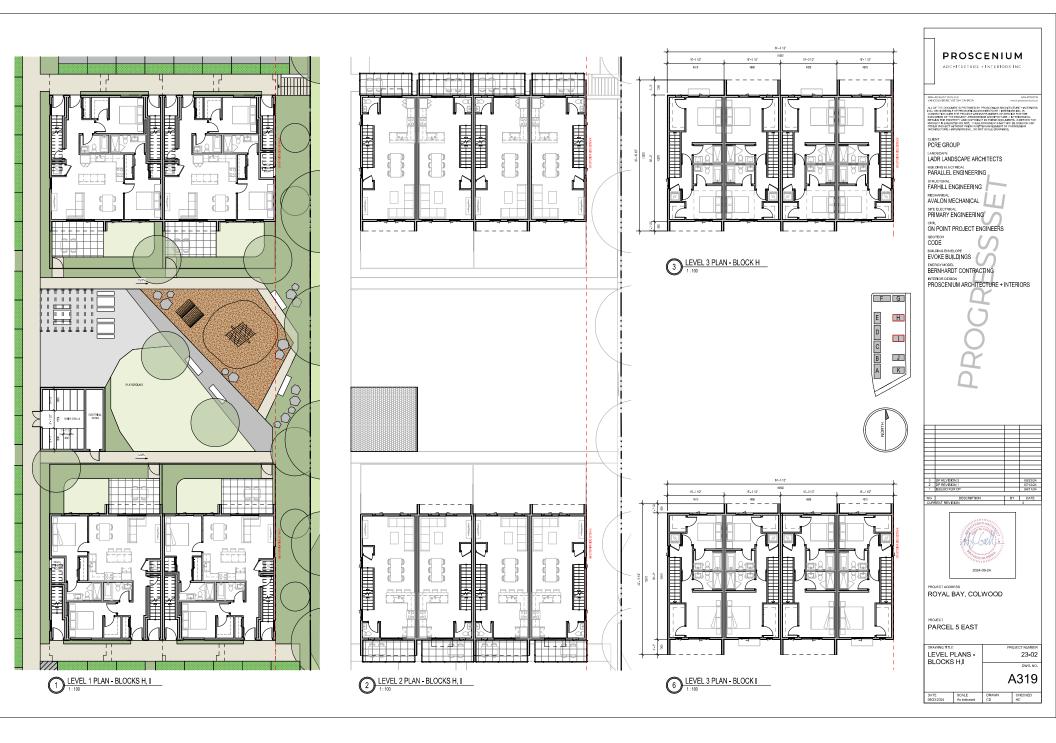


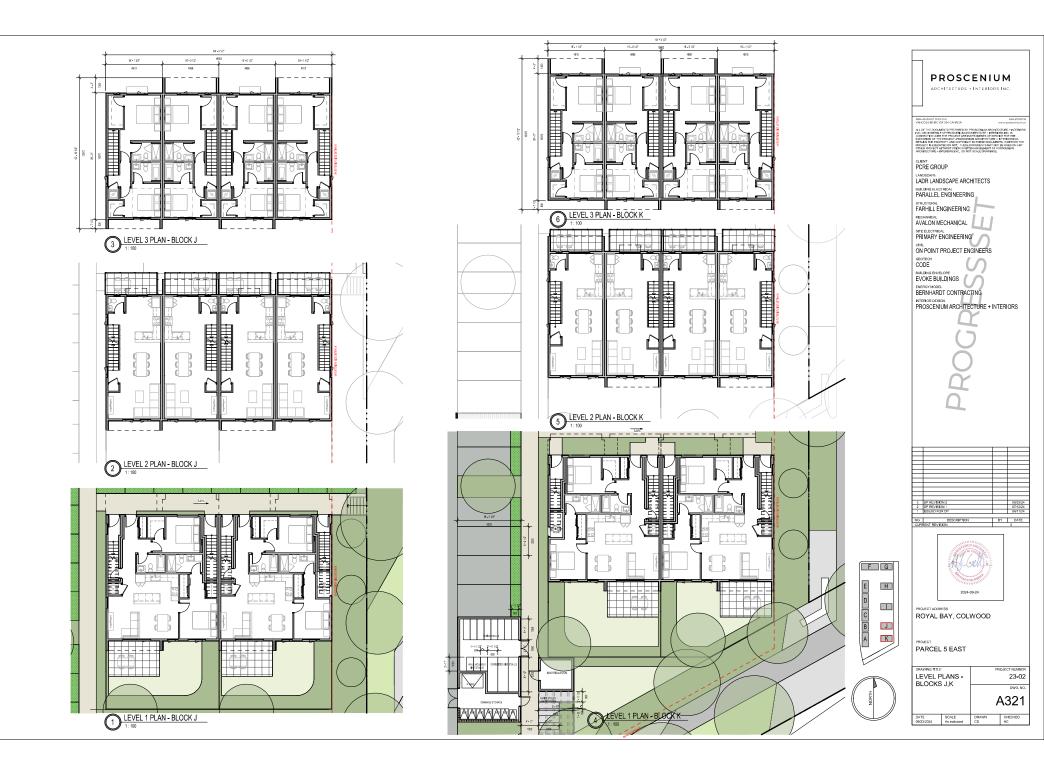



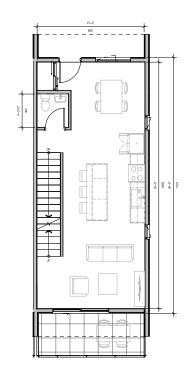



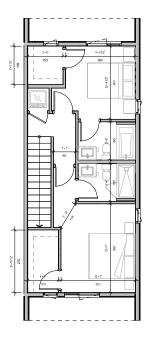

ISLA LEVEL 3

PROSCENIUM

ARCHITECTURE + INTERIORS INC.

PCRE GROUP

LADR LANDSCAPE ARCHITECTS

PARALLEL ENGINEERING

STRUCTURAL FARHILL ENGINEERING

AVALON MECHANICAL SITE ELECTRICAL PRIMARY ENGINEERING

ON POINT PROJECT ENGINEERS

GEOTECH CODE

BUILDING ENVELOPE EVOKE BUILDINGS


EVORE BUILDINGS
ENERGYMOREL
BERNHARDT CONTRACTING
INTERIOR DESIGN
PROSCENIUM ARCHITECTURE + INTERIORS


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3	DP REVISION 2		09/23/
2	DP REVISION 1		07/12/
1	ISSUED FOR DP	_	04/11/
NO.	DESCRIPTION	BY	DATE
	RENT REVISION		3




PROJECT ADDRESS
ROYAL BAY, COLWOOD

DRAWING TITL	E		PROJECT NUMBER	
UNIT PI	_ANS -		23-02	
ISLA			DWG.NO.	
			A350	
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STACKED UNIT LEVEL 2

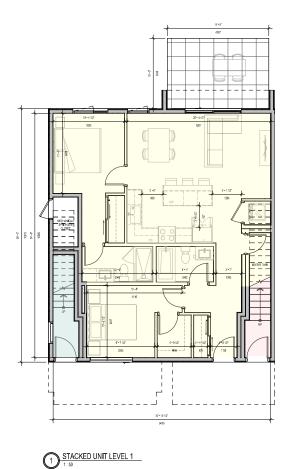3 STACKED UNIT LEVEL 3

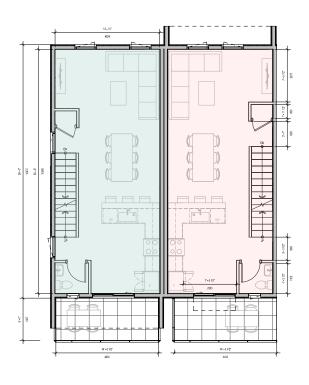PROSCENIUM ARCHITECTURE + INTERIORS INC.

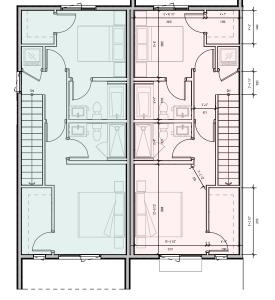PCRE GROUP

LADR LANDSCAPE ARCHITECTS

PARALLEL ENGINEERING FARHILL ENGINEERING

MECHANICAL AVALON MECHANICAL

SITE ELECTRICAL
PRIMARY ENGINEERING

ON POINT PROJECT ENGINEERS

GEOTECH CODE

BUILDING ENVELOPE EVOKE BUILDINGS


EVOICE DOLLDINGS
ENERGY MODEL
BERNHARDT CONTRACTING
INTERIOR DESIGN
PROSCENIUM ARCHITECTURE + INTERIORS






PROJECT ADDRESS
ROYAL BAY, COLWOOD

UNIT PL STACKE	ANS -		PROJECT NUMB 23-0
UNITS			A35′
DATE 09/23/2024	SCALE 1:50	DRAWN CD	HC CHECKED

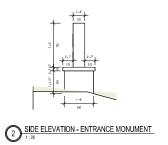

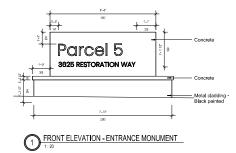

PCRE GROUP

LADR LANDSCAPE ARCHITECTS

PARALLEL ENGINEERING

FARHILL ENGINEERING

MECHANICAL AVALON MECHANICAL

SITE ELECTRICAL PRIMARY ENGINEERING

ON POINT PROJECT ENGINEERS

GEOTECH CODE

BUILDING ENVELOPE EVOKE BUILDINGS


EVIDATE DUILDINGS
ENERGY MODEL
BERNHARDT CONTRACTING
INTERIOR DESIGN
PROSCENIUM ARCHITECTURE + INTERIORS

BY DATE



ROYAL BAY, COLWOOD

DRAWING TITLE			PROJECT NUMBER
SITE DE	TAILS		23-02
			DWG.NO
			A700
DATE 09/23/2024	SGALE 1:20	DRAWN CD	CHECKED HC

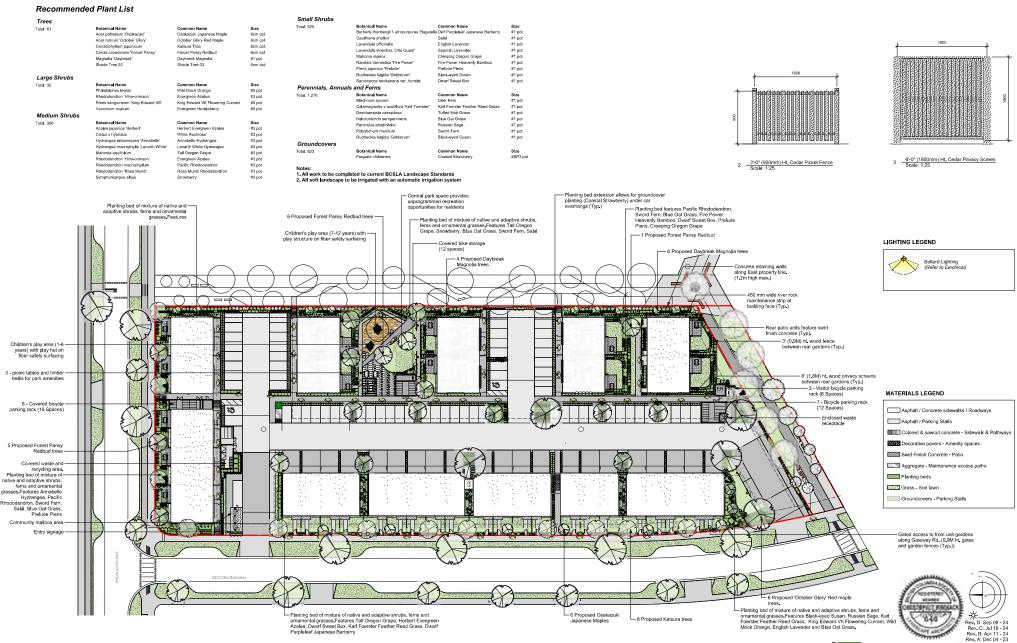


Landscape Concept Plan | Phase 5 Townhouses East



Project No: 2329 Dec 4 - 23

#3-864 Queens Ave. Victoria B.C. V8T 1M5 Phone: (250) 596-0105 Fax: (250) 412-0696

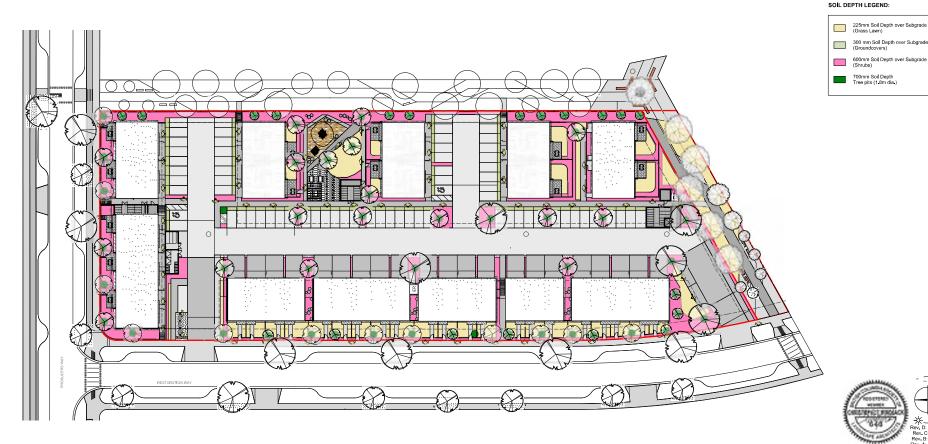

Landscape Concept Plan | Phase 5 Townhouses East



LADR LANDSCAPE ARCHITECTS

225mm Soil Depth over Subgrade (Grass Lawn) 300 mm Soil Depth over Subgrade (Groundcovers)



#3-864 QUEENS AVE VICTORIA, BC V8T 1M5 P. 250.598.0105 ADMINBLADRLA.CA WWW.LADRLA.CA

Phase 5 East: Landscape Class D Cost Estimate

A. SOFT LANDSCAPE	Quantity Units	Price	Extension
1. PLANTS			
Trees (6 cm caliper)	55 each	\$600.00	
Shrubs (#5 pot/1m ht)	19 each	\$70.00	
Shrubs (#3 pot)	415 each	\$55.00	
Shrubs, Perennials, Annuals, and Ferns (#1 pot)	2219 each	\$20.00	
Groundcovers (#SP3 pot)	823 each	\$8.00	
SUB-TOTAL PLANTS			\$108,119.00
2. GRASS AND GROWING MEDIUM			
Topsoil and Sod	674 m.sq.	\$30.00	\$20,220.00
Soil Planting Beds	739 m.cu.	\$32.00	•
Mulch 100mm depth	125 m.cu.	\$40.00	
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SUBTOTAL SOFT LANDSCAPE			\$156,987.00
D. HADD I ANDOGADE			
B. HARD LANDSCAPE			
1. IRRIGATION ALLOWANCE			\$22,000.00
2. AGGREGATE, ROCK, AND SURFACING			
River Rock 155mm depth	31 m.cu.	\$98.00	\$3,038.00
Boulders ~300mm diameter	42 each	\$60.00	
Engineered Wood Fibre Play Surface 355mm depth	25 m.cu.	\$60.00	
Decorative Concrete Pavers	159 m.sq.	\$135.00	
		Ţ.00.00	Ψ=1,100.00
3. SITE FURNISHINGS			
Inverted 'U' Bicycle Racks	24 each	\$500.00	\$12,000.00
Benches	4 each	\$1,100.00	\$4,400.00
Picnic Tables	3 each	\$2,500.00	\$7,500.00
4. FENCING			
900mm Timber Fence and Gates	206 l.m.	\$114.00	\$23,484.00
1800mm Timber Privacy Fence	200 i.m. 105 l.m.	\$114.00 \$137.00	\$14,385.00
Trellis and Bike Shelter Allowance	100 1.111.	φ137.00	
THEIRS AND DIKE SHEREI AROWANCE			\$20,000.00

SUBTOTAL HARD LANDSCAPE

TOTAL LANDSCAPE BUDGET ESTIMATE

Note: Boulevard is not included within the scope of this develope Bay submission. Prices include labor and materials unless Estimate for bonding purposes only; it is not a construction stir Prepared by LADR Landscape Architects \$132,292.00

\$289,279.00 Exclusive of GST

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27-Aug-24