## Colwood

### CITY OF COLWOOD

3300 Wishart Road | Colwood | BC V9C 1R1 | 250 294-8153 planning@colwood.ca | www.colwood.ca

File: DP000034 - Single Family Dwellings with Suites at Temperate PI (Lots 18-27)

### **DEVELOPMENT PERMIT DP000034**

THIS PERMIT, issued NOVEMBER 26, 2024 is,

ISSUED BY:

CITY OF COLWOOD, a municipality incorporated under the Local Government Act,

3300 Wishart Road, Victoria, BC, V9C 1R1

(the "City")

**PURSUANT TO:** 

Section 490 of the Local Government Act, RSBC 2015, Chapter 1

ISSUED TO:

**ROYAL BAY HOLDINGS NO 2 LTD** 

PO BOX 49221 STN BENTALL CENTRE

VANCOUVER BC V7X 1L2

(the "Permittee")

 This Form and Character Intensive Residential) Development Permit applies to those lands within the City of Colwood described below, and any and all buildings, structures, and other development thereon:

LOT 18, SECTION 40, ESQUIMALT LAND DISTRICT, PLAN EPP113484

LOT 19, SECTION 40, ESQUIMALT LAND DISTRICT, PLAN EPP113484

LOT 20, SECTION 40, ESQUIMALT LAND DISTRICT, PLAN EPP113484

LOT 21, SECTION 40, ESQUIMALT LAND DISTRICT, PLAN EPP113484

LOT 22, SECTION 40, ESQUIMALT LAND DISTRICT, PLAN EPP113484

LOT 23, SECTION 40, ESQUIMALT LAND DISTRICT, PLAN EPP113484

LOT 24, SECTION 40, ESQUIMALT LAND DISTRICT, PLAN EPP113484 LOT 25, SECTION 40, ESQUIMALT LAND DISTRICT, PLAN EPP113484

LOT 26, SECTION 40, ESQUIMALT LAND DISTRICT, PLAN EPP113484

LOT 27, SECTION 40, ESQUIMALT LAND DISTRICT, PLAN EPP113484, & SEC 41

3581 TEMPERATE PL

3583 TEMPERATE PL

3585 TEMPERATE PL

3587 TEMPERATE PL

3589 TEMPERATE PL

3591 TEMPERATE PL

3593 TEMPERATE PL 3595 TEMPERATE PL 3597 TEMPERATE PL 3599 TEMPERATE PL

(the "Lands")

- This Development Permit regulates the development and alterations of the Land, and supplements the "Colwood Land Use Bylaw, 1989" (Bylaw No. 151), to ensure the Form and Character considerations for the development of ten single family homes with secondary suites and associated site improvements are consistent with the design guidelines for areas designated as "Intensive Residential" in the City of Colwood Official Community Plan (Bylaw No. 1700).
- This Development Permit is <u>NOT</u> a Building Permit or a subdivision approval.
- 4. This Development Permit is issued subject to compliance with all of the bylaws of the City of Colwood that apply to the development of the Lands, except as specifically supplemented by this Permit.
- 5. The Director of Development Services or their delegate may approve minor variations to the schedules attached to and forming part of this Development Permit, provided that such minor variations are consistent with the overall intent of the original plans and do not alter the form and character of the development authorized by those plans.
- 6. If the Permittee does not substantially start the construction permitted by this Permit within 24 months of the date of this Permit, the Permit shall lapse and be of no further force and effect.
- 7. The development is to be constructed in accordance with the following plans and specifications, which are attached to and form as part of this permit:

Schedule 1 Architectural Plans prepared by Victoria Design Group for Lots 18-21 dated November 4, 2024, for Lots 22-24 dated November 14, 2024, for Lot 25 dated November 25, 2024, and for Lot 26 dated November 5, 2024, and for Lot 27 dated November 15, 2024

Schedule 2 Landscape Plans prepared by Verity Construction for Lots 18-20 dated November 1, 2024, for Lot 21 dated November 4, 2024, for Lots 22-25 dated November 14, 2024, for Lot 26 dated November 5, 2024, and for Lot 27 dated November 18, 2024.

8. This Development Permit authorizes the development of ten single family homes with secondary suites along with any associated site works. The Lands shall not be altered, nor any buildings or structures constructed, except in accordance with the following conditions:

### **GENERAL**

8.1. This Permit shall not be construed as relieving the Permittee from compliance with any of the requirements contained within the Section 219 covenants registered as "CA8439553", "CB201032", "CB201034", "CB201038", and "CB201040" and as amended.

### FORM AND CHARACTER CONDITIONS

### **Building Features**

- 8.2. The form and character of the buildings to be constructed on the Lands shall conform to the Architectural Drawings prepared by Victoria Design Group (Schedule 1).
- 8.3. Any future additions of telecommunications antennas or equipment to the exterior of the buildings and/or structures included in this Permit shall be architecturally integrated into the buildings and/or structures they are mounted on or screened from views so as not to be visually obtrusive, to the satisfaction of the Director of Development Services or their delegate.
- 8.4. All mechanical roof elements, including mechanical equipment, elevator housings, and vents shall be visually screened with sloped roofs or parapets, or other forms of solid screening to the satisfaction of the Director of Development Services or their delegate.
- 8.5. No future construction/installation of unenclosed or enclosed outdoor storage areas or recycling/refuse collection shall be undertaken without the issuance of a further Development Permit or amendment to this Permit.

### Landscaping

8.6. The design and construction of the proposed landscaping shall be in substantial compliance with the Landscape Plan prepared by Verity Construction (Schedule 2).

ISSUED ON THIS 26 DAY OF NOVEMBER 2024.

JOHN ROSENBERG, A.Sc.T.

**DIRECTOR OF ENGINEERING AND DEVELOPMENT SERVICES** 

### Schedule 1 #103 - 891ATTREE AVENUE 12.27M TEMPERATE PLACE - LOT 18 LOT 26 LOT LOT 25 LOT 21 LOT 20 LOT 23 LOT 22 SITE DATA 52.50m—— Finished CD28 (Area 10) PERMITTED PROPOSED LOT 29 LOT AREA 278 sq.m. 391.54 sq.m. 14'-0"x10'-0" LOT COVERAGE 50.00 % 33.07 % 3.58m**BUILDING HEIGHT** 9.50 m. 7.26 m. LOT 30 9.00 m. LOT WIDTH 9.98 m. SETBACKS 10.16 m. 4.50 m. LOT /M.F.E.-53.30M FRONT (GARAGE) 6.00 m. 10.16 m. G.F.E.-53.10M 6.00 m. 6.00 m. LOT 38 LOT 37 LOT 36 LOT NATURAL AVG 1.20 m. 1.20 m. 34 GRADE: 52.65M 3.00 m. - SIDE 3.00 m. 33 PROPOSED FLOOR AREA PROPOSED 128.53 sq.m. RESIDENCE 90.40 sq.m. MAIN GARAGE 39.04 sq.m. **LOT 18** SUB-TOTAL G.F.A. 257.97 sq.m. GARAGE ALLOWANCE 50.00 sq.m. -39.04 sq.m. **GROSS FLOOR AREA** 218.93 sq.m. Scale: Not To Scale 0.56 TO 1.0 24.97M SECONDARY SUITE 40.00 % SECONDARY SUITE (%) 25.44 % SECONDARY SUITE (SQ.M.) 90.00 sq.m. 55.70 sq.m. AVERAGE NATURAL GRADE CALCULATION 100mm (4") Depth Mulch. 52.53 m. + 53.10 m. + 52.45 m. + 52.50 m. = 210.58 m. Keep Mulch 100mm off Trunk divided by 4 = ave. grade 52.65 m. Min. 750mm 100mm (4") Depth Mulch.-Root Flare to be 25-50mm Above SEE LANDSCAPING PLAN FOR TREE SCHEDULE Adjacent Growing Medium RETAINING WALLS \*XX.Xm\* = DESIGNER APPROXIMATE HEIGHT MEASUREMENT, VERIFY ON SITE Finished Grade - TO BE CERTIFIED BY AN ENGINEER AND MEET BCBC REQUIREMENTS FOR EARTHQUAKE DESIGN (REFER TO STRUCTURAL DRAWINGS) - ALL LANDSCAPE RETAINING WALLS TO HAVE A 1.2m MAX. EXPOSED HT 3.00m OR A MAX. 1:1 RATIO OF HEIGHT TO HORIZONTAL SEPARATION IF TERRACED —Set Rootball on Compacted Subgrade Tree Planting Detail Scale: Not To Scale All trees and plants by the home owner to be planted in minimum 10m³ of fertile topsoil, 700mm Deep 6.51M TYPICAL FENCE NOTES: PARKING STALL SMALL CAR PARKING 1. ALL WOOD P.T. HEM FIR. R: 2.50M\_ STALL DIMENSIONS 2. ALL HARDWARE HOT DIPPED GALVANIZED DIMENSIONS 3. GATE HARDWARE TO BE PREAPPROVED BY OWNER $^{\star}$ \* as per 2.2.02a allowing one stall to be a small car parking stall A: 3.50M PATH OF OVERHANG-**STOP & READ** -1X6 BOARDS PATH OF FRONT WHEEL Driveway Crossing PATH OF REAR WHEEL-←──6X6 WOOD POST► RETAINING WALLS <u>MAY NOT</u> EXCEED 1.2m IN HEIGHT OR A 1:1 RATIO OF HEIGHT TO HORIZONTAL SEPARATION IF TERRACED ALL FENCING, RETAINING AND LANDSCAPING MUST MEET THE GUIDELINE REQUIREMENTS MAXIMUM PROJECTIONS / CANTILEVERS / OVERHANGS INTO SETBACKS ARE 0.65m —1X6 BOTHSIDES— IN YARDS OF LESS THAN 3.0m AND 1.0m IN YARDS OF 3.0m+. 7.47m Siteplan THE WIDTH OF THE DRIVEWAY ACCESS (AT PROPERTY LINE - CROSSING THE CITY COMPACTED SUBGRADE 1/3RD POST HT. BOULEVARD) MAY NOT EXCEED 7.0m IN WIDTH IN CONC. FOOTING PASSENGER VEHICLE ON 75MM OF DRAIN ROCK 2.13M X 5.8M (7'x19') TURNING TEMPLATE CONTRACTOR TO ENSURE A MINIMUM 2% SLOPE SIDE YARD SWALING (BOTH SIDES) MAY BE REQUIRED Typical Fence Detail Turning Template ALL FENCING, RETAINING AND LANDSCAPINING MUST MEET GUIDELINE REQUIREMENTS Scale: Not To Scale Scale: Not To Scale 2.13m \*TYPICAL FENCE DETAIL BASED OFF FENCE DETAIL 1/L1 FROM ROYAL BAY DESIGN GUIDELINES PAGE 21 Development Permit Presentation

Colwood, B.C. Prepared for

Project #

Verity Construction

Date

Nov 4, 2024

**Project Address** 

3581 Temperate Place

Lot 18 - Royal Bay

VICTORIA, B.C.

V9B 0A6

P. 250.382.7374

F. 250.382.7364


8298-18


Scale

As Noted

Drawn By MRB

BASEPLAN B TYPE A

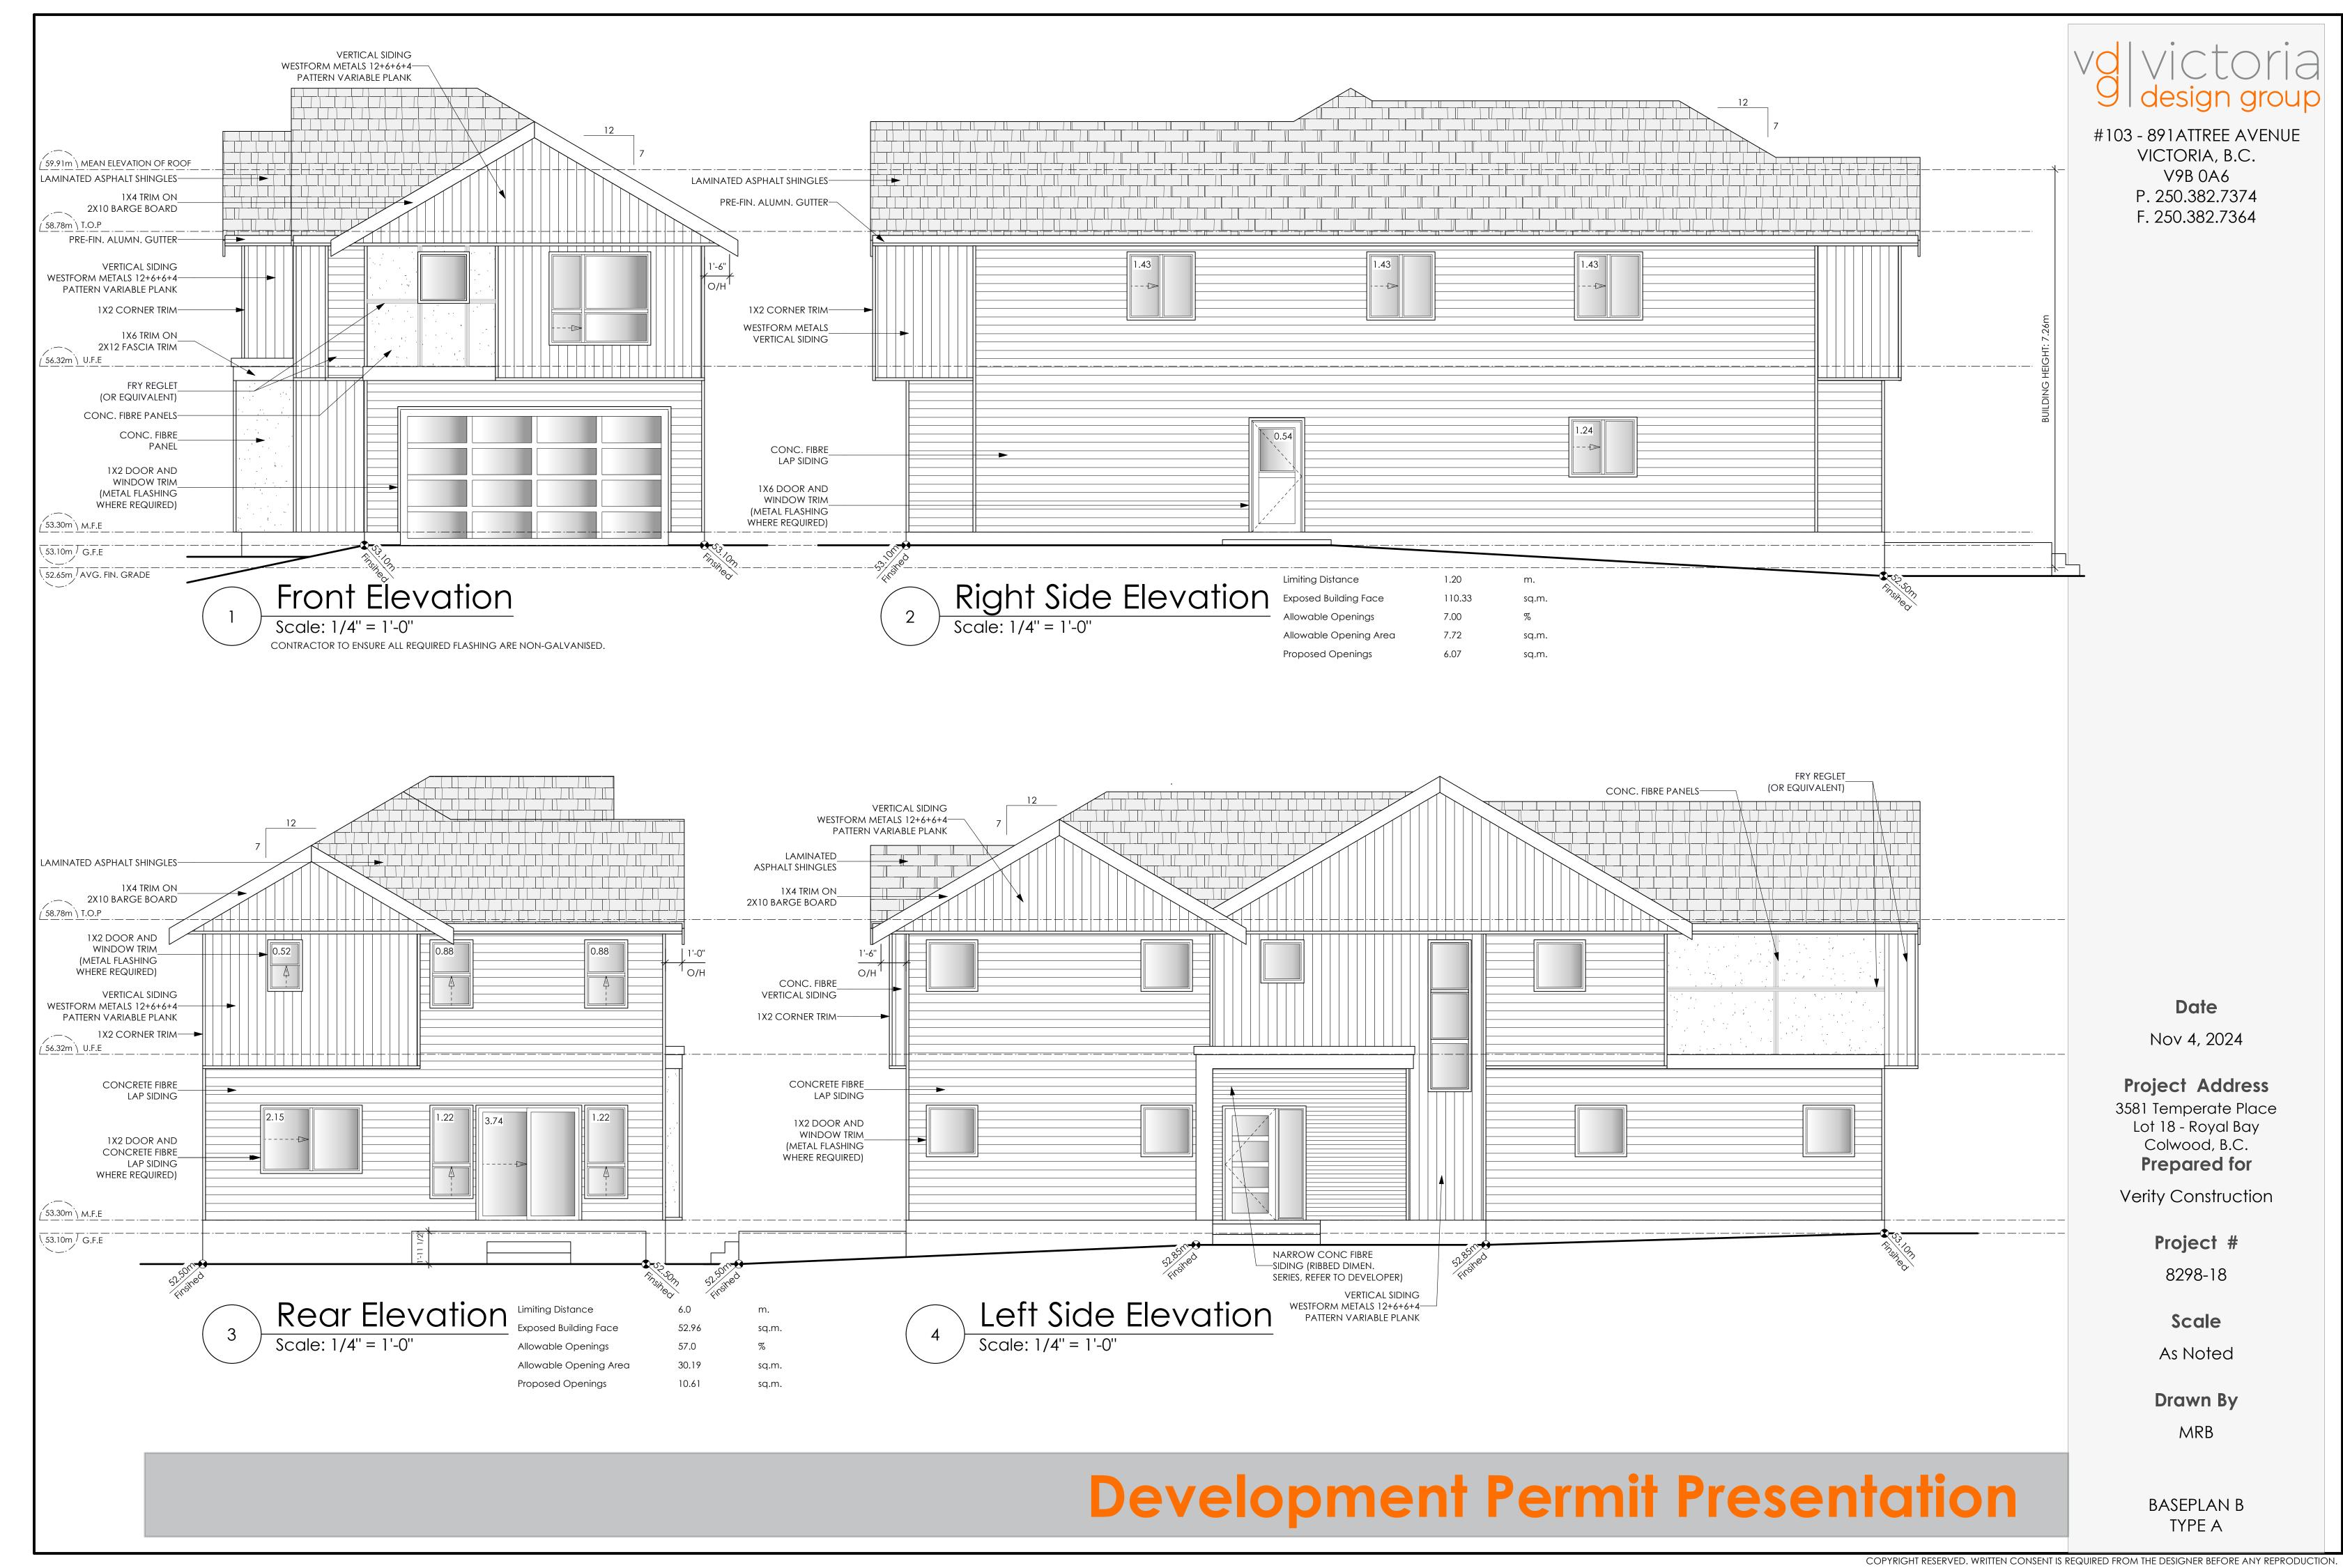

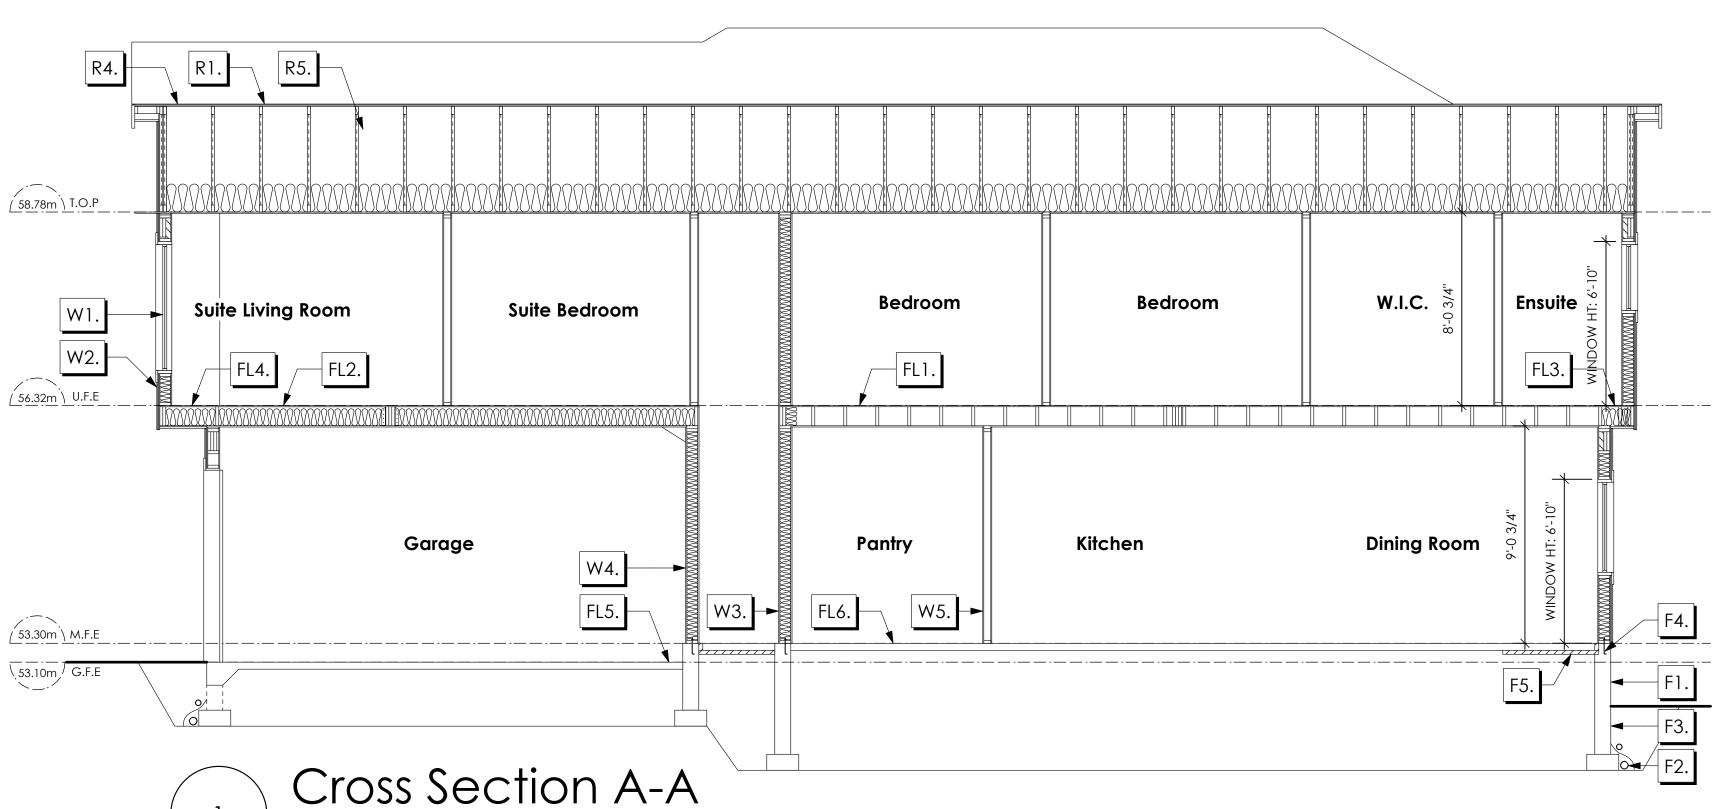

volvictoria 9 design group

#103 - 891 ATTREE AVENUE VICTORIA, B.C. V9B 0A6 P. 250.382.7374 F. 250.382.7364

## GROUND LEVEL SHALL BE PRESSURE TREATED WITH A PRESERVATIVE FOR TERMITE AND DECAY PROTECTION B.C.B.C. 9.3.2.9.(3)

Scale: 1/4" = 1'-0" NOTE:

R1. LAMINATED ASPHALT SHINGLES ON
7/16" ORIENTED STRAND BOARD C/W "H" CLIPS
WD TRUSSES (DESIGNED BY MANUF.)
R-40 FIBRE GLAS BATT INSULATION OR
14 1/2" FIBRE GLASS LOOSE FILL INSULATION
6 MIL POLY'N V.B.
5/8" GYPSUM BOARD OR
5/8" X-TYPE GYPSUM BOARD
45 MINUTE RATED F.R.R.

ROOFS

R2. 2 PLY S.B.S.MODIFIED BITUMEN FULLY
ADHERED MEMBRANE
(TO COMPLY WI. CGSB 37-GP-56M
AND CGSB-37-6P-9MA) ON
7/16" ORIENTED STRAND BOARD C/W "H" CLIPS
2×10 ROOF JOISTS @ 16" O/C
VENTED SOFFIT

(OVER SECONDARY SUITE)

- R3. PROVIDE 2 1/2" (63MM) CLEAR BETWEEN R-20 INSULATION AND SHEATHING.
  (MIN. R-20 @ ROOF-WALL CONNECTION FOR 4'-0" (1.2M) AROUND PERIMETER OF BUILDING. AIR VENTILATION BAFFLES TO BE INSTALLED WHERE REQUIRED IN AS PER BCBC 9.19.)
  (NOT SHOWN IN SECTION)
- R4. EAVE PROTECTION
  CONT. UP ROOF SLOPE FOR 12"
  PAST EXTERIOR WALL.
- R5. PROVIDE 1 SQ.FT. ATTIC VENT PER
  300 SQ.FT. OF INSULATED AREA MIN.
  25% OF REQUIRED TO BE @ TOP AND BOTTOM
  (TO COMPLY WI. B.C. BLDG. CODE 9.19.1)
- R6. PRE-FIN. FASCIA GUTTER
  2×8 FASCIA BD.
  2×4 SUB. FASCIA BD.
  VENTED SOFFIT
  (SEE CONTRACTOR)
  (NOT SHOWN IN SECTION)
- R7. PRE-FIN. FASCIA GUTTER
  2×8 FASCIA BD.
  2×4 SUB. FASCIA BD.
  1/2" ORIENTED STRAND BOARD
  VENTED SOFFIT
  (SEE CONTRACTOR)
  (NOT SHOWN IN SECTION)

### **FLOORS**

FL1. FINISHED FLOORING ON
19/32" ORIENTED STRAND BOARD
(NAILED & GLUED TO FLOOR STRUCT. BELOW) ON
2×10 FLOOR JOISTS @ 16" OR 12" O/C
C/W 2×2 X-BRIDGING @ 7.0' O/C (MAX)
1/2" GYPSUM BOARD

ALL STRUCTURE TO BE VERIFIED OR DESIGNED BY A STRUCTURAL ENGINEER. STRUCTURAL ENGINEER TO LOCATE AND DESIGN REQUIRED EXTERIOR AND INTERIOR WALL BRACING TO RESIST LATERAL LOADS IN COMPLIANCE WITH B.C. BUILDING CODE 9.23.13. AND SUPPLY DETAILS IF REQUIRED

STRUCTURAL WOOD ELEMENTS WITHIN 150MM (6") FROM FINISHED

FL2. B.C. BUILDING CODE (TABLE-9.10.3.1.B)
RATED FLOOR ASSEMBLY F8D
FINISHED FLOORING ON
11/16" ORIENTED STRAND BOARD
(FASTENED & GLUED TO FLOOR STRUCT. BELOW) ON
2×10 FLOOR JOISTS @ 16" OR 12" O/C
C/W 2×2 X-BRIDGING @ 7.0' O/C (MAX)
R-31 INSULATION
RESILIENT METAL CHANNELS @ 24" O/C
1 LAYERS 5/8" X-TYPE GYPSUM BOARD

30 MINUTE F.R.R., 50 S.T.C.

- FL3. FINISHED FLOORING ON
  11/16" ORIENTED STRAND BOARD
  (FASTENED & GLUED TO FLOOR STRUCT. BELOW) ON
  2×10 FLOOR JOISTS @ 16" OR 12" O/C
  C/W 2×2 X-BRIDGING @ 7.0' O/C (MAX)
  PROVIDE R-31 F/G BATT INSULATION IN
  JOIST CAVITY C/W
  BUILDING WRAP
  VENTED SOFFIT (TO OWNERS SPEC'S)
  TO ALL SUSPENDED FLOOR AREAS
- FL4. FINISHED FLOORING ON

  11/16" ORIENTED STRAND BOARD

  (FASTENED & GLUED TO FLOOR STRUCT. BELOW) ON

  2×10 FLOOR JOISTS @ 16" OR 12" O/C

  C/W 2×2 X-BRIDGING @ 7.0' O/C (MAX)

  PROVIDE R-31 F/G BATT INSULATION IN

  JOIST CAVITY C/W

  BUILDING WRAP

  1/2" ORIENTED STRAND BOARD

  VENTED SOFFIT (TO OWNERS SPEC'S)
- FL5. 3 1/2" CONCRETE SLAB
  6 MIL. POLY'N V.B.
  6" COMPACTED GRAVEL OR SAND
  SLOPE TO DOORS 1"

TO ALL SUSPENDED FLOOR AREAS

FL6. 3 1/2" CONCRETE SLAB 6 MIL. POLY'N V.B. 6" COMPACTED GRAVEL OR SAND

### WALLS

- W1. DOUBLE GLAZING
  ENERGY STAR LOW "E" RATING IN
  THERMAL BREAK FRAMES
  2/2"X10" LINTEL OVER (@ bearing walls only)
  (TYPICAL, wi. 2 1/2" XPS insulation)
  FLASHING OVER @ EXTERIOR
  (glazing in all exterior doors & within 3 ft.
  of exterior doors to be shatterproof (SP))
- W2. CONC. FIBRE BOARD ON
  9.5MM (3/8") AIR SPACE / STRAPPING
  3/8"×2" BORATE TREATED PLYWOOD STRAPPING
  HOUSE WRAP (A.B.) (TYVEK OR EQ.)
  7/16" ORIENTED STRAND BOARD SHEATHING
  2×6 STUDS @ 16" O/C
  R-20 INSULATION
  6 MIL. POLYETHYLENE VAPOUR BARRIER
  1/2" GYPSUM BOARD
- W3. B.C. BUILDING CODE (TABLE 9.10.3.1.A)
  RATED WALL ASSEMBLY W3C

  1 LAYER 1/2" X-TYPE GYPSUM BOARD
  RESILIENT METAL CHANNELS @ 24" O/C
  2×4 STUDS @ 16" O/C OR
  2×6 STUDS @ 16" O/C (IF NOTED) C/W
  3 1/2" FIBRE GLASS SOUND BATTS
  1 LAYER 1/2" X-TYPE GYPSUM BOARD
  45 MIN. F.R.R 43 S.T.C
  (BETWEEN PRIMARY LIVING & SECONDARY SUITE)
- W4. B.C. BUILDING CODE (TABLE 9.10.3.1.A)
  RATED WALL ASSEMBLY W3C

  1 LAYER 1/2" X-TYPE GYPSUM BOARD
  RESILIENT METAL CHANNELS @ 24" O/C
  2×4 STUDS @ 16" O/C OR
  2×6 STUDS @ 16" O/C (IF NOTED) C/W
  3 1/2" FIBRE GLASS SOUND BATTS
  6 MIL. POLY'N V.B
  1 LAYER 1/2" X-TYPE GYPSUM BOARD
  45 MIN. F.R.R 43 S.T.C
  (BETWEEN GARAGE & SECONDARY SUITE)
- W5. INTERIOR PARTITION
  1/2" GYPSUM BOARD ON EACH SIDE
  OF 2×4 STUDS @ 16" O/C OR
  2×6 STUDS @ 16" O/C (IF NOTED)

  W6. 5/8" X-TYPE GYPSUM BOARD ON
- W6. 5/8" X-TYPE GYPSUM BOARD C 2×6 STUDS @ 16" O/C C/W R-20 INSULATION 6 MIL. POLY'N V.B 1/2" GYPSUM BOARD (BETWEEN GARAGE & LIVING) (NOT SHOWN IN SECTION)

### **FOUNDATION**

- F1. DAMP PROOFING (WHERE REQUIRED) ON 8" THK. CONC. FOUNDATION WALL C/W 15 M BARS @ 24" O/C B/W
- F2. 16"X 8" CONC. FOOTINGS

  C/W 2 (TWO) 15M BARS CONT. 3 IN. FROM BOTT.

  ON UNDISTURBED SOIL (SOLID BEARING)
- F3. 4" PERIMETER DRAIN
  3" TIGHT PIPE FOR RWL
  DRAIN ROCK
- F4. ANCHOR BOLTS @ 4.0 FT. O/C MAX C/W SILL GASKETS
- F5. UNDER SLAB INSULATION
  2 1/2" (RSI 2.15) EXTRUDED POLYSTYRENE
  RIGID INSULATION 4'-0" (1.2M)
  CONT. AROUND PERIMETER UNDER
  SLAB INSTALLED HORIZONTALLY
  (VERIFY WITH MUNICIPALITY DEPTH OF FROST LINE)

Date

Nov 4, 2024

Project Address
3581 Temperate Place
Lot 18 - Royal Bay
Colwood, B.C.
Prepared for

Verity Construction

Project #


8298-18


**Scale**As Noted

Drawn By

MRB

BASEPLAN B TYPE A

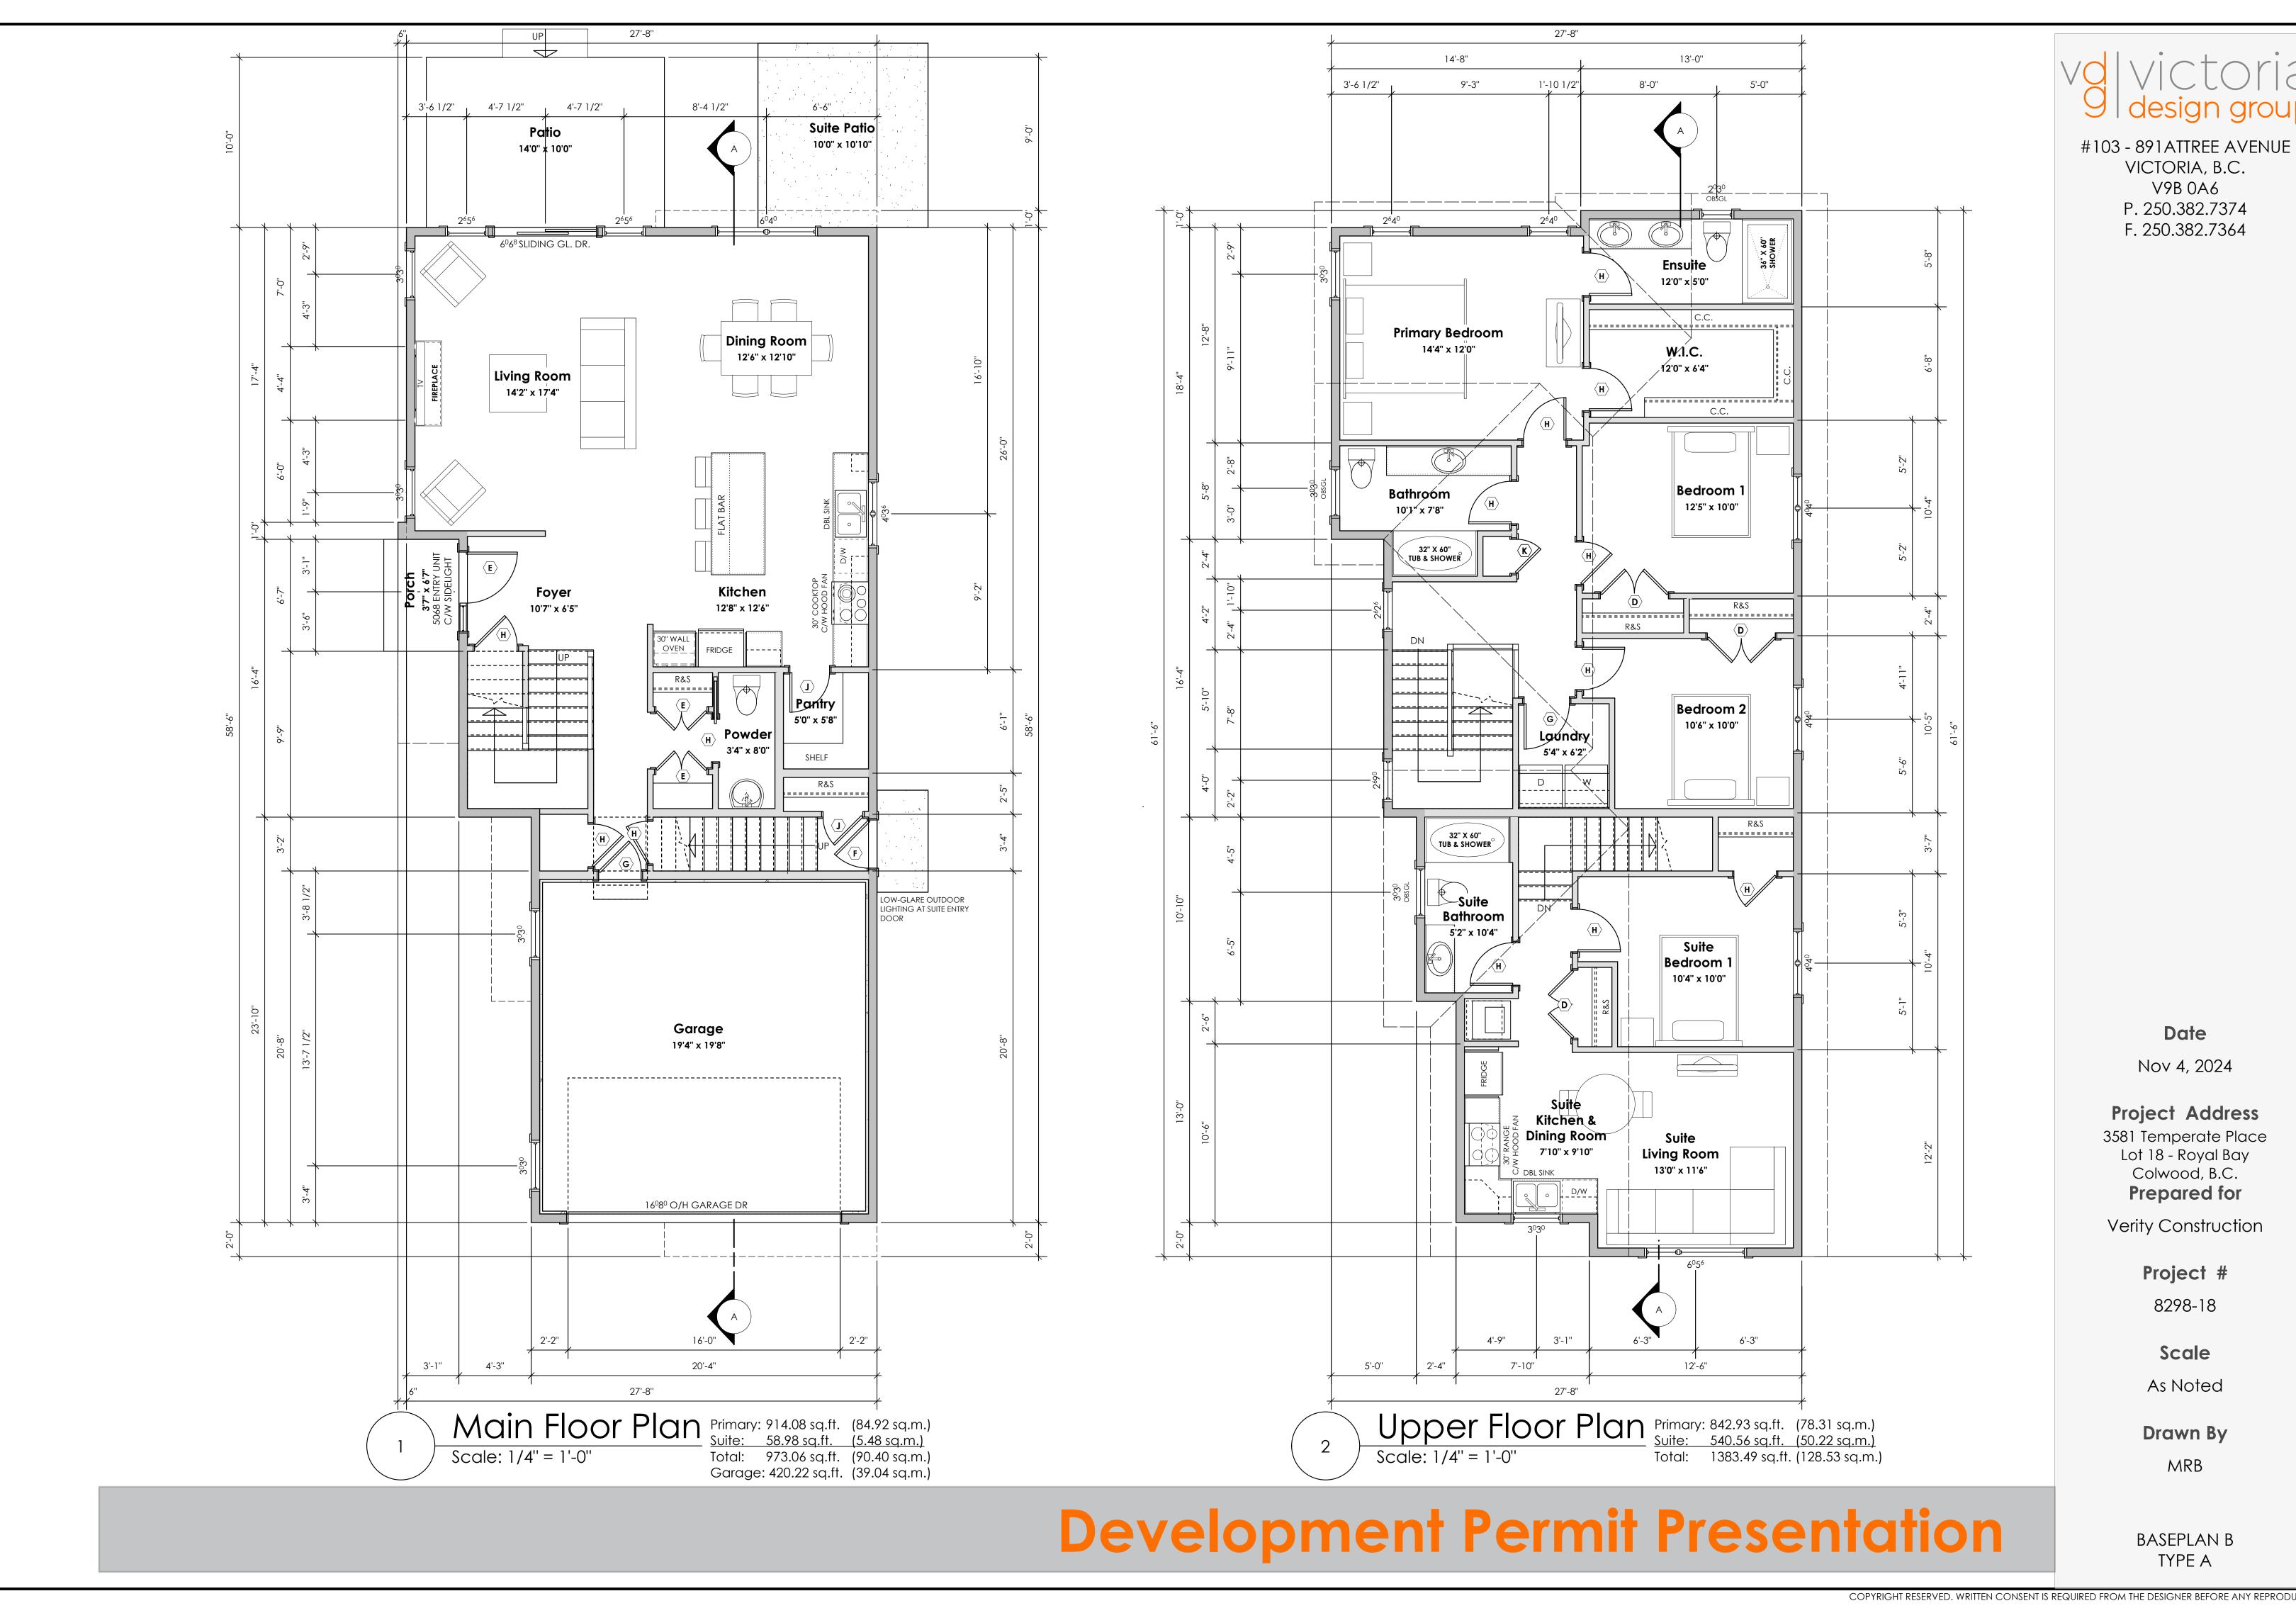


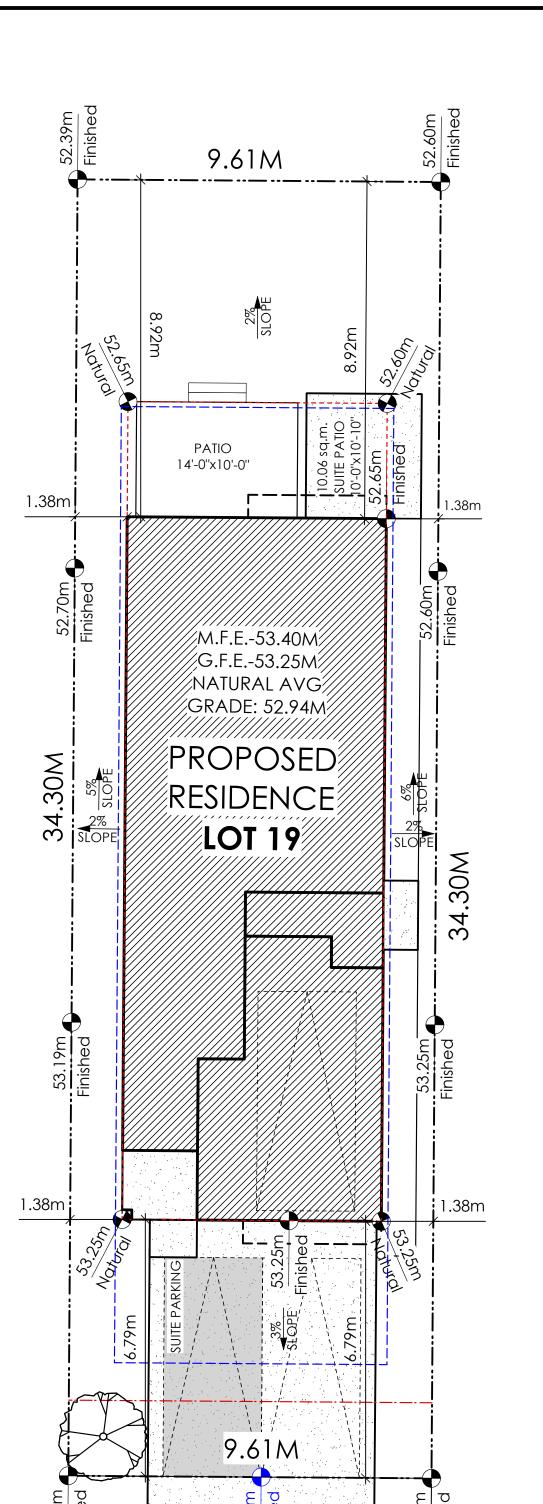



6.00m

Driveway Crossing

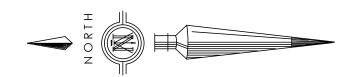


## TEMPERATE PLACE - LOT 19

SITE DATA	CD28 (Area 10)	
ITEMS	PERMITTED	PROPOSED
LOT AREA	278 sq.m.	329.62 sq.m.
LOT COVERAGE	50.00 %	40.03 %
BUILDING HEIGHT	9.50 m.	6.83 m.
LOT WIDTH	9.00 m.	9.61 m.
SETBACKS		
- FRONT	4.50 m.	6.79 m.
- FRONT (GARAGE)	6.00 m.	6.79 m.
- REAR	6.00 m.	8.92 m.
- SIDE	1.20 m.	1.38 m.
- SIDE	1.20 m.	1.38 m.
PROPOSED FLOOR AREA		
- UPPER		131.97 sq.m.
- MAIN		93.28 sq.m.
- GARAGE		30.61 sq.m.
SUB-TOTAL G.F.A.		255.86 sq.m.
GARAGE ALLOWANCE	50.00 sq.m.	-30.61 sq.m.
GROSS FLOOR AREA		225.25 sq.m.
F.A.R.		0.68 TO 1.0
SECONDARY SUITE		
SECONDARY SUITE (%)	40.00 %	27.28 %
SECONDARY SUITE (SQ.M.)	90.00 sq.m.	61.45 sq.m.

AVERAGE NATURAL GRADE CALCULATION 53.25 m. + 53.25 m. + 52.65 m. + 52.60 m. = 211.75 m. divided by 4 = ave. grade 52.94 m.

SEE LANDSCAPING PLAN FOR TREE SCHEDULE

\*XX.Xm\* = DESIGNER APPROXIMATE HEIGHT MEASUREMENT, VERIFY ON SITE - TO BE CERTIFIED BY AN ENGINEER AND MEET BCBC REQUIREMENTS FOR EARTHQUAKE DESIGN (REFER TO STRUCTURAL DRAWINGS) - ALL LANDSCAPE RETAINING WALLS TO HAVE A 1.2m MAX. EXPOSED HT

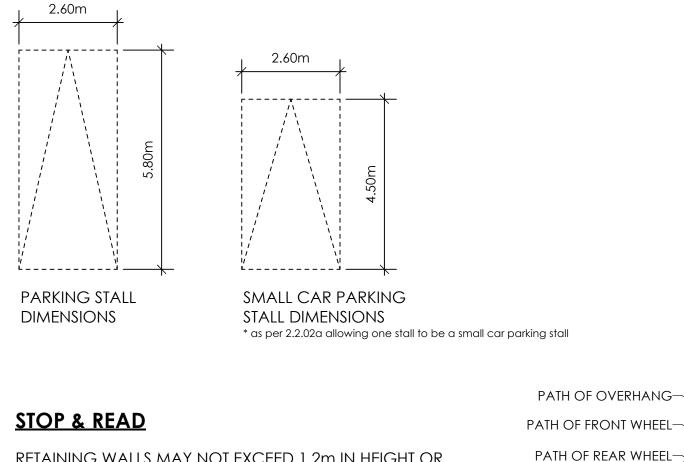

RETAINING WALLS <u>MAY NOT</u> EXCEED 1.2m IN HEIGHT OR A 1:1 RATIO OF HEIGHT TO HORIZONTAL SEPARATION IF TERRACED

ALL FENCING, RETAINING AND LANDSCAPING MUST MEET THE GUIDELINE REQUIREMENTS

MAXIMUM PROJECTIONS / CANTILEVERS / OVERHANGS INTO SETBACKS ARE 0.65m IN YARDS OF LESS THAN 3.0m AND 1.0m IN YARDS OF 3.0m+.

7.47m

2.13m

PASSENGER VEHICLE

2.13M X 5.8M (7'x19')

TURNING TEMPLATE


Scale: Not to Scale


Turning template


THE WIDTH OF THE DRIVEWAY ACCESS (AT PROPERTY LINE - CROSSING THE CITY BOULEVARD) MAY NOT EXCEED 7.0m IN WIDTH

CONTRACTOR TO ENSURE A MINIMUM 2% SLOPE SIDE YARD SWALING (BOTH SIDES) MAY BE REQUIRED

ALL FENCING, RETAINING AND LANDSCAPINING MUST MEET GUIDELINE REQUIREMENTS

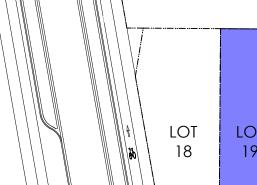

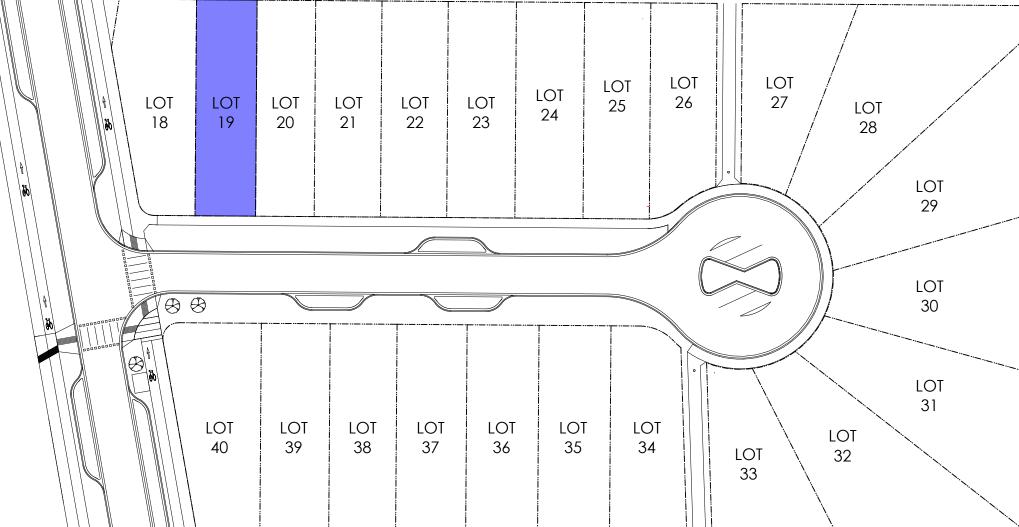


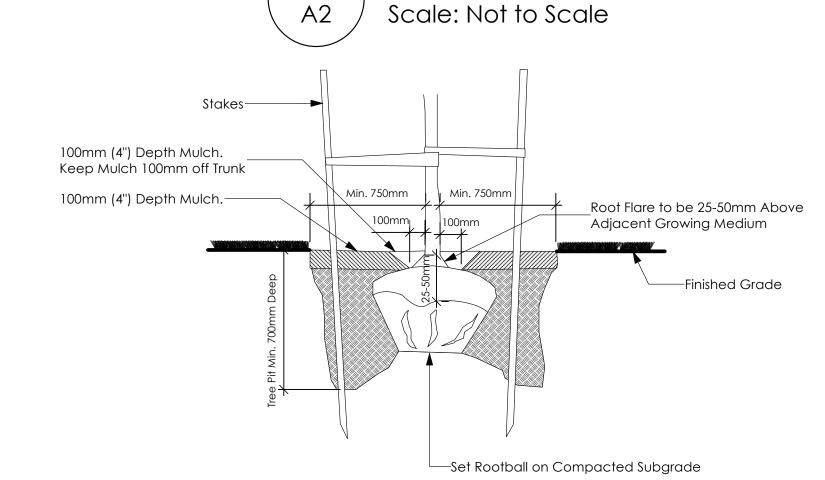

Key Plan

Tree Planting Detail Scale: Not to Scale

All trees and plants by the home owner to be planted in minimum 10m³ of fertile topsoil, 700mm Deep

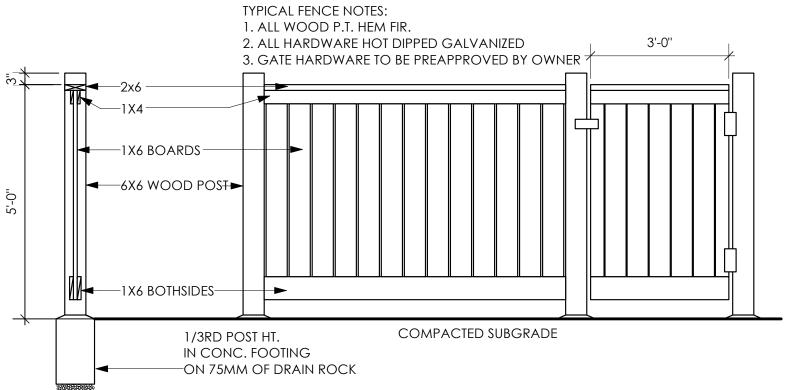



Typical Fence Detail

#103 - 891ATTREE AVENUE VICTORIA, B.C. V9B 0A6 P. 250.382.7374 F. 250.382.7364

Date

Nov 4, 2024

**Project Address** 3583 Temperate Place Lot 19 - Royal Bay Colwood, B.C.

Verity Construction

Prepared for

Project #

8298-19


Scale


As Noted

Drawn By

MRB

BASEPLAN A TYPE A

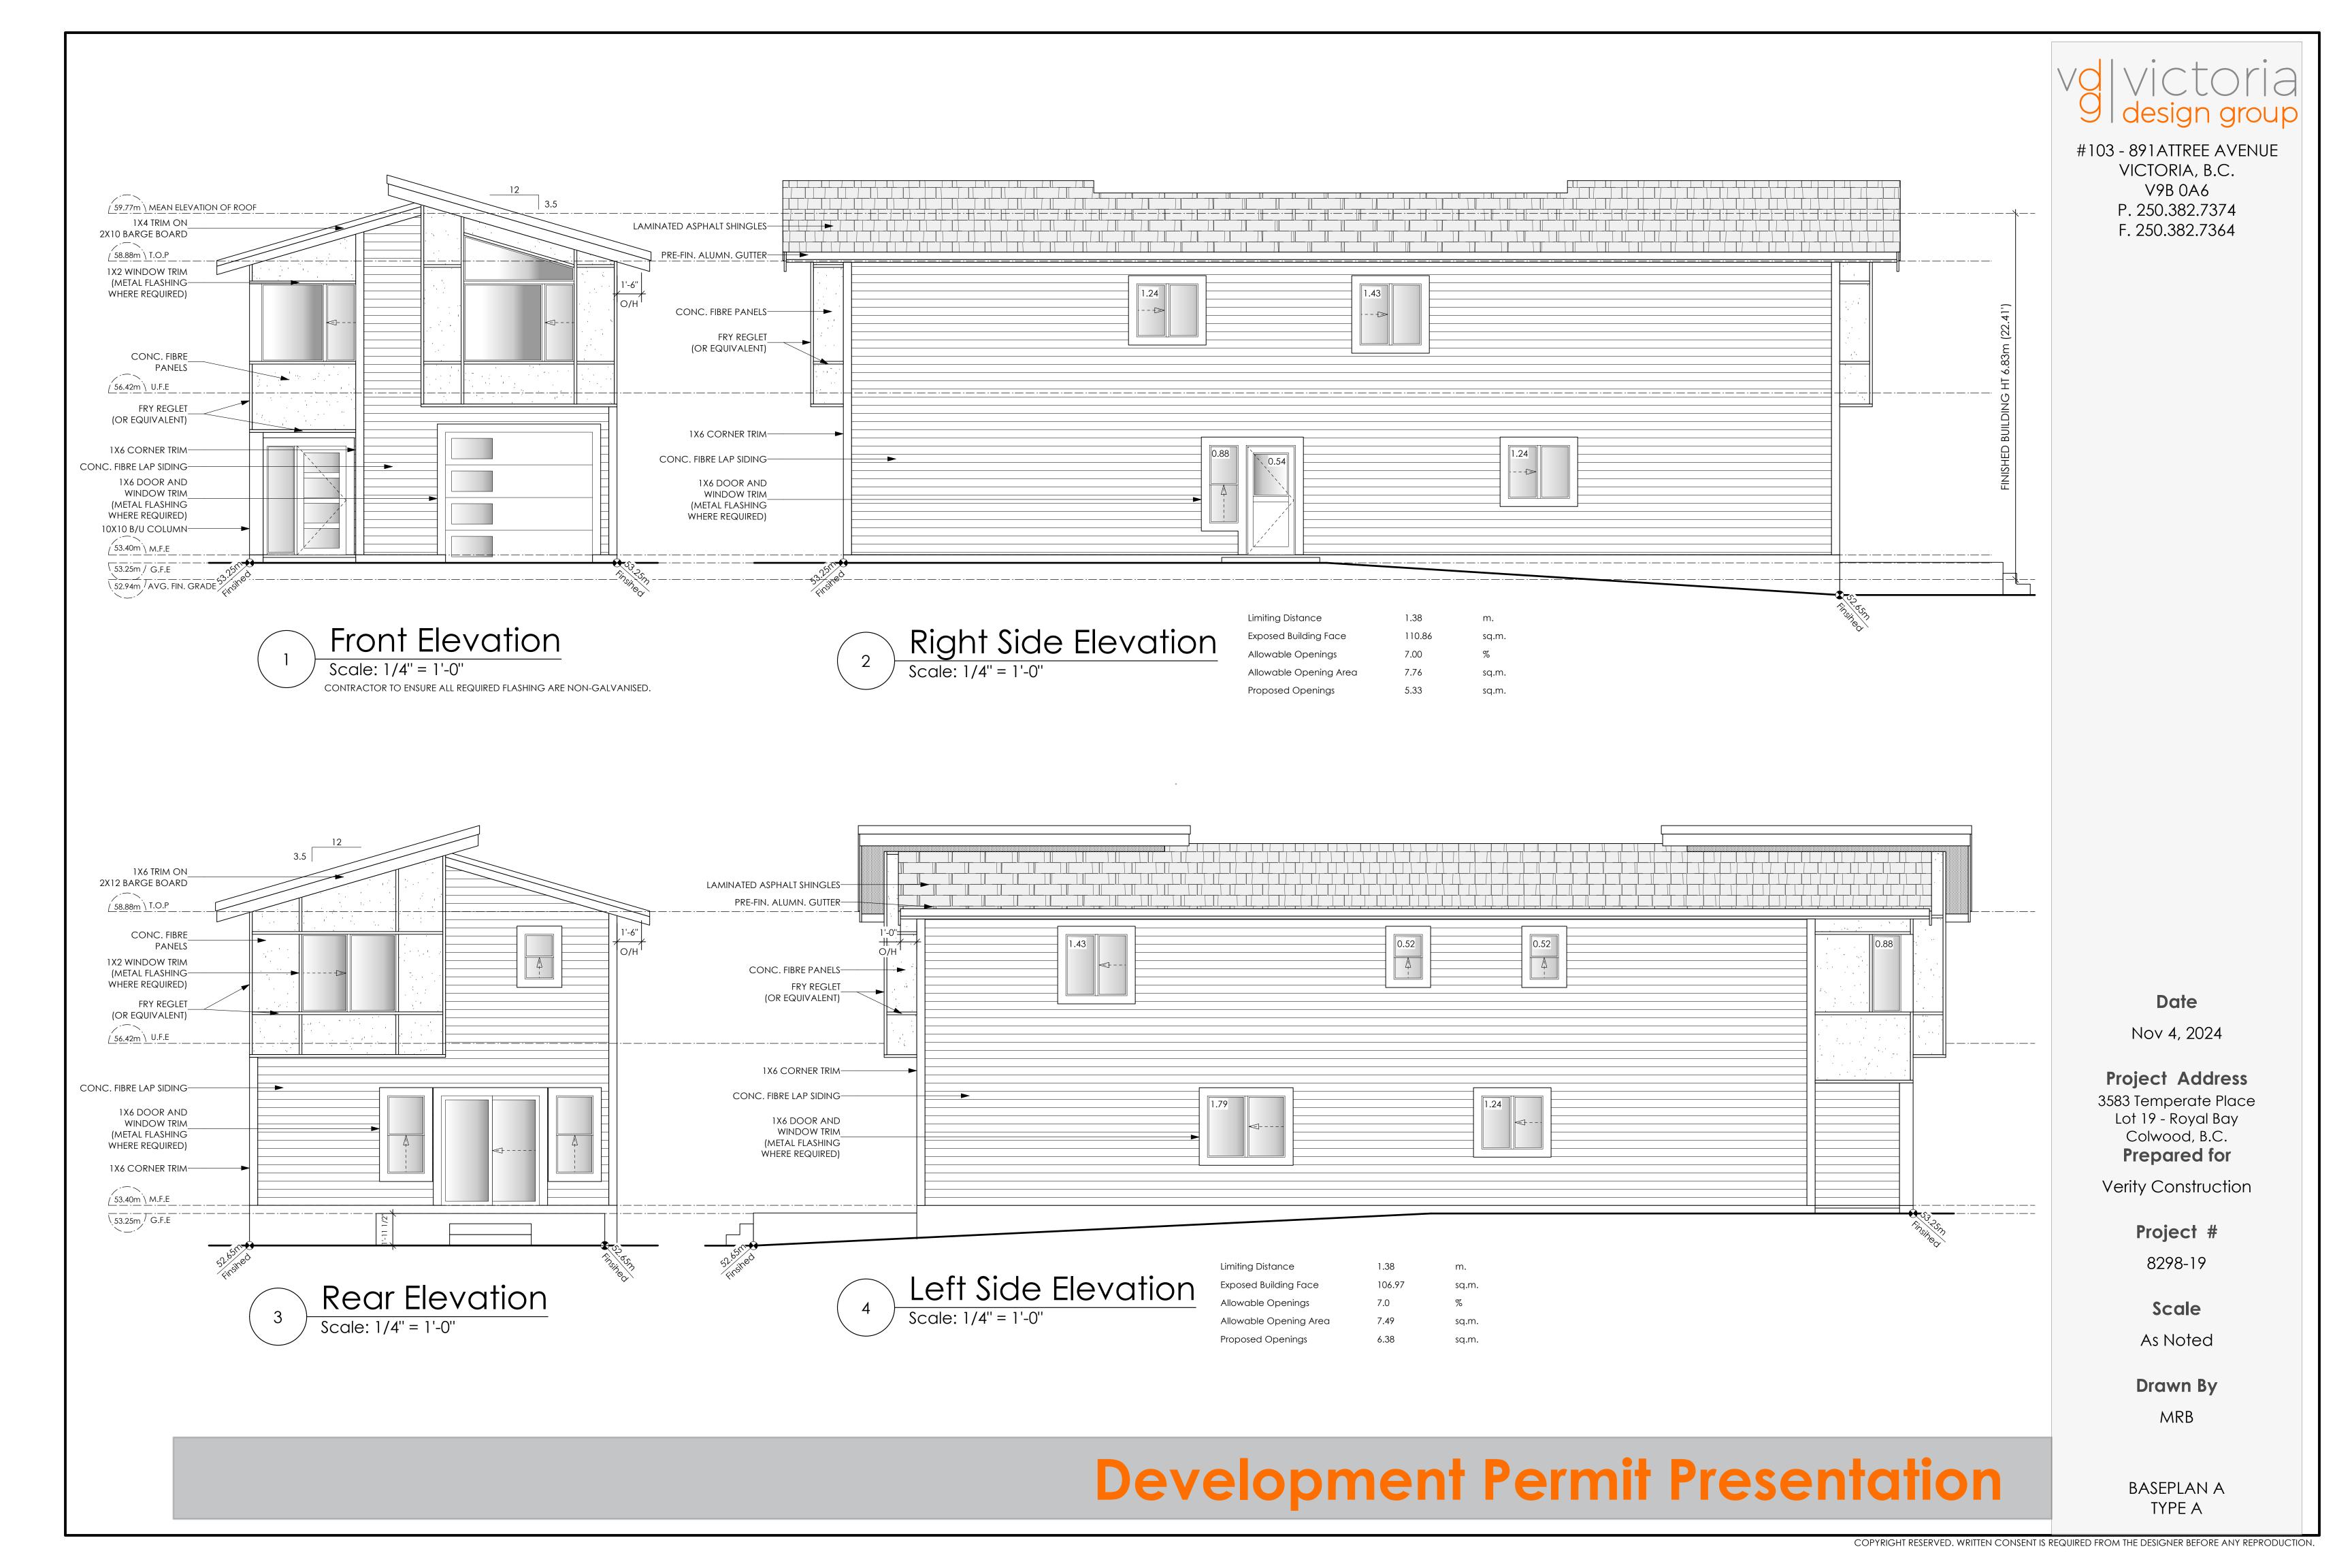

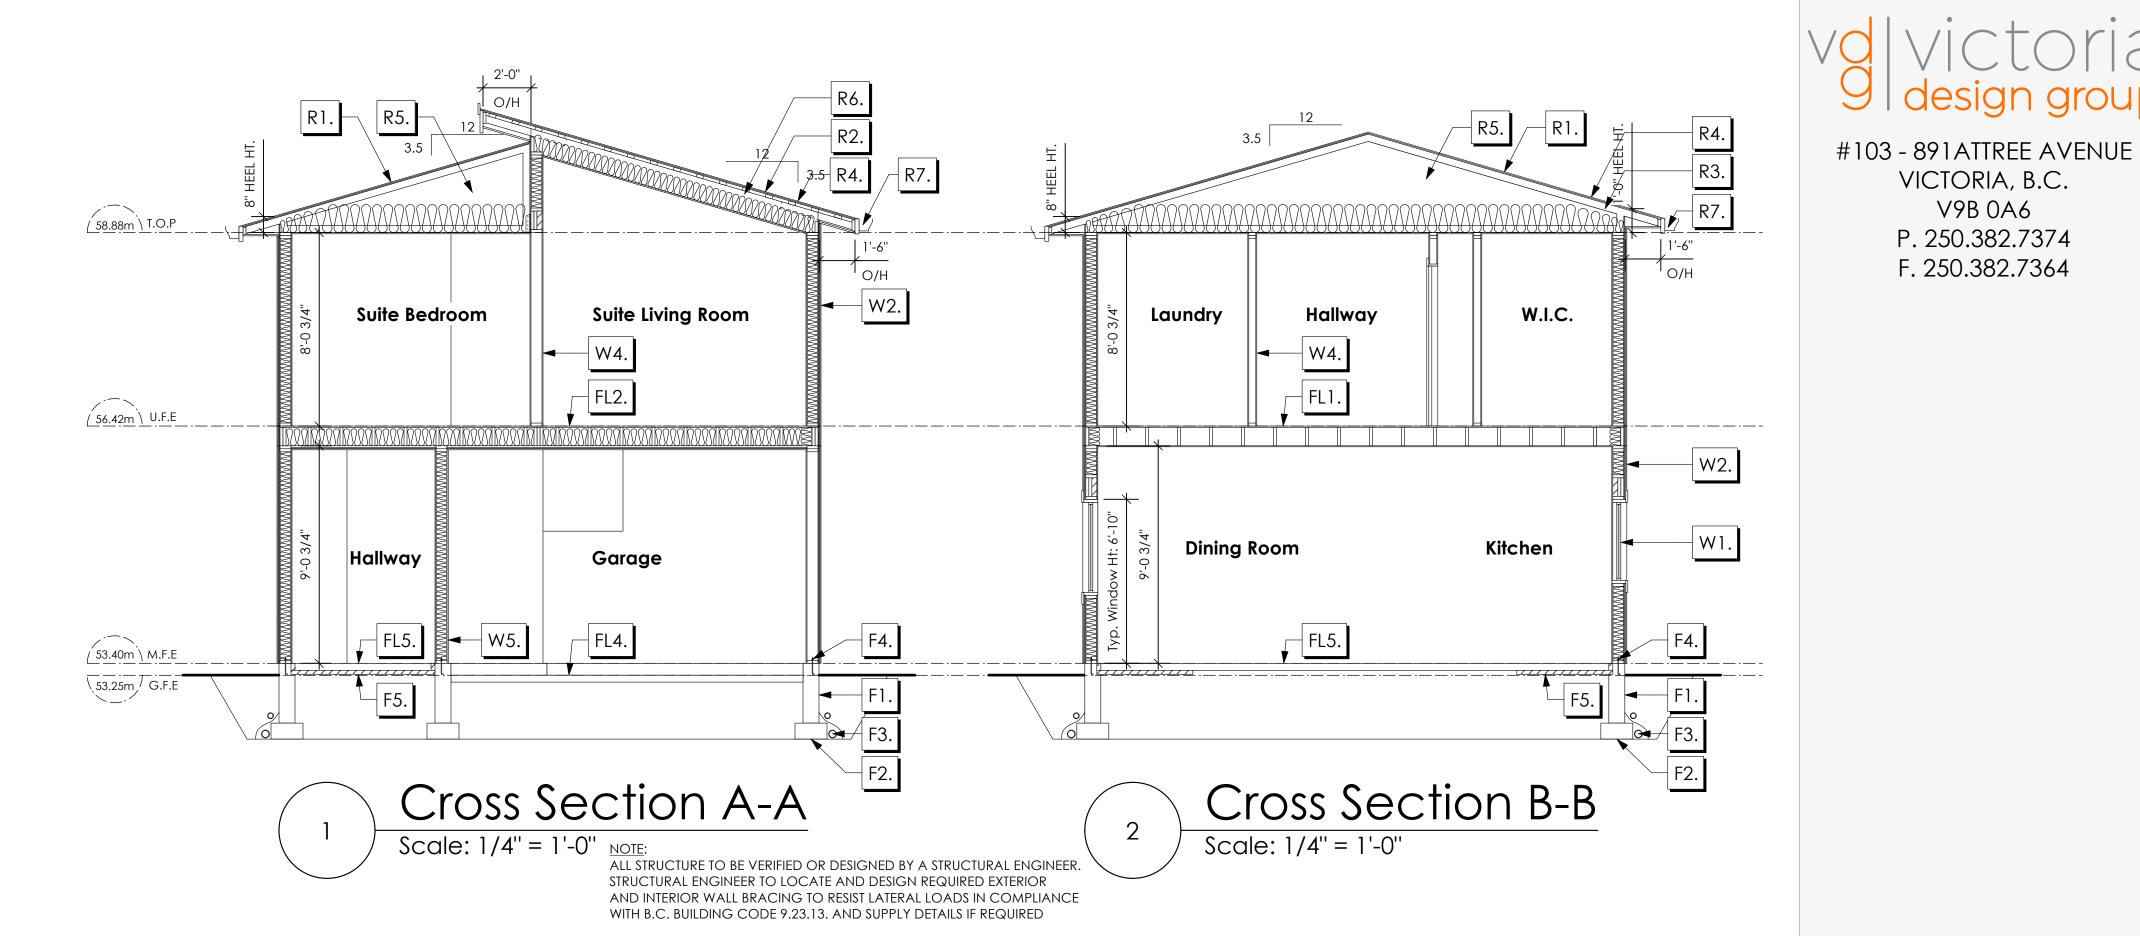

### ROOFS

- Laminated asphalt shingles on 7/16" ORIENTED STRAND BOARD C/W "H" CLIPS WD TRUSSES (DESIGNED BY MANUF.) R-40 FIBRE GLAS BATT INSULATION OR 6 MIL POLY'N V.B. 5/8" GYPSUM BOARD OR 5/8" X-TYPE GYPSUM BOARD 45 MINUTE RATED F.R.R. (OVER SECONDARY SUITE)
- LAMINATED ASPHALT SHINGLES ON 7/16" ORIENTED STRAND BOARD C/W "H" CLIPS 2×4 STRAPPING @ 16" O/C ON 2×12 ROOF JOISTS @ 16" O/C R-31 BATT INSULATION 6 MIL POLY'N V.B. 1/2" GYPSUM BOARD OR 5/8" X-TYPE GYPSUM BOARD 45 MINUTE RATED F.R.R. (OVER SECONDARY SUITE)
- R3. PROVIDE 2 1/2" (63MM) CLEAR BETWEEN R-20 INSULATION AND SHEATHING. (MIN. R-20 @ ROOF-WALL CONNECTION FOR 4'-0" (1.2M) AROUND PERIMETER OF BUILDING. AIR VENTILATION BAFFLES TO BE INSTALLED WHERE REQUIRED IN AS PER BCBC 9.19.)
- R4. EAVE PROTECTION CONT. UP ROOF SLOPE FOR 12" PAST EXTERIOR WALL.
- PROVIDE 1 SQ.FT. ATTIC VENT PER 300 SQ.FT. OF INSULATED AREA MIN. 25% OF REQUIRED TO BE @ TOP AND BOTTOM (TO COMPLY WI. B.C. BLDG. CODE 9.19.1)
- R6. PROVIDE 1 SQ.FT. ATTIC VENT PER 150 SQ.FT. OF INSULATED AREA MIN. 25% OF REQUIRED TO BE @ TOP AND BOTTOM FL6. 3 1/2" CONCRETE SLAB (TO COMPLY WI. B.C. BLDG. CODE 9.19.1)
- R7. PRE-FIN. FASCIA GUTTER 2×8 FASCIA BD. 2×4 SUB. FASCIA BD. **VENTED SOFFIT** (SEE CONTRACTOR)
- R8. PRE-FIN. FASCIA GUTTER 2×8 FASCIA BD. 2×4 SUB. FASCIA BD. 1/2" ORIENTED STRAND BOARD **VENTED SOFFIT** (SEE CONTRACTOR)

### **FLOORS**

FL1. FINISHED FLOORING ON 19/32" ORIENTED STRAND BOARD (NAILED & GLUED TO FLOOR STRUCT, BELOW) ON 2×10 FLOOR JOISTS @ 16" OR 12" O/C C/W 2×2 X-BRIDGING @ 7.0' O/C (MAX) 1/2" GYPSUM BOARD

STRUCTURAL WOOD ELEMENTS WITHIN 150MM (6") FROM FINISHED GROUND LEVEL SHALL BE PRESSURE TREATED WITH A PRESERVATIVE

FOR TERMITE AND DECAY PROTECTION B.C.B.C. 9.3.2.9.(3)

- FL2. B.C. BUILDING CODE (TABLE-9.10.3.1.B) RATED FLOOR ASSEMBLY F8D FINISHED FLOORING ON 11/16" ORIENTED STRAND BOARD (FASTENED & GLUED TO FLOOR STRUCT. BELOW) ON 2×10 FLOOR JOISTS @ 16" OR 12" O/C C/W 2×2 X-BRIDGING @ 7.0' O/C (MAX) R-31 INSULATION RESILIENT METAL CHANNELS @ 24" O/C 1 LAYERS 5/8" X-TYPE GYPSUM BOARD
- FL3. FINISHED FLOORING ON 11/16" ORIENTED STRAND BOARD (FASTENED & GLUED TO FLOOR STRUCT. BELOW) ON 2×10 FLOOR JOISTS @ 16" OR 12" O/C C/W 2×2 X-BRIDGING @ 7.0' O/C (MAX) PROVIDE R-31 F/G BATT INSULATION IN JOIST CAVITY C/W BUILDING WRAP VENTED SOFFIT (TO OWNERS SPEC'S)
- FL4. 3 1/2" CONCRETE SLAB 6 MIL. POLY'N V.B. 6" COMPACTED GRAVEL OR SAND SLOPE TO DOORS 1"

(NOT SHOWN IN SECTION)

TO ALL SUSPENDED FLOOR AREAS

30 MINUTE F.R.R., 50 S.T.C.

- FL5. 3 1/2" CONCRETE SLAB 6 MIL. POLY'N V.B. 6" COMPACTED GRAVEL OR SAND
- 6" COMPACTED GRAVEL OR SAND SLOPE MIN. 2% AWAY FROM BUILDING

### WALLS

- W1. DOUBLE GLAZING ENERGY STAR LOW "E" RATING IN THERMAL BREAK FRAMES 2/2"X10" LINTEL OVER (@ bearing walls only) (TYPICAL, wi. 2 1/2" XPS insulation) FLASHING OVER @ EXTERIOR (glazing in all exterior doors & within 3 ft. of exterior doors to be shatterproof (SP))
- W2. CONC. FIBRE BOARD ON 9.5MM (3/8") AIR SPACE / STRAPPING 3/8"×2" BORATE TREATED PLYWOOD STRAPPING HOUSE WRAP (A.B.) (TYVEK OR EQ.) 7/16" ORIENTED STRAND BOARD SHEATHING 2×6 STUDS @ 16" O/C R-20 INSULATION 6 MIL. POLYETHYLENE VAPOUR BARRIER 1/2" GYPSUM BOARD
- W3. B.C. BUILDING CODE (TABLE 9.10.3.1.A) RATED WALL ASSEMBLY W3c 1 LAYER 1/2" X-TYPE GYPSUM BOARD RESILIENT METAL CHANNELS @ 24" O/C 2×4 STUDS @ 16" O/C OR 2×6 STUDS @ 16" O/C (IF NOTED) C/W 3 1/2" FIBRE GLASS SOUND BATTS 1 LAYER 1/2" X-TYPE GYPSUM BOARD 45 MIN. F.R.R 43 S.T.C (BETWEEN PRIMARY LIVING & SECONDARY SUITE) (NOT SHOWN IN SECTION)
- W4. INTERIOR PARTITION 1/2" GYPSUM BOARD ON EACH SIDE OF 2×4 STUDS @ 16" O/C OR 2×6 STUDS @ 16" O/C (IF NOTED)
- W5. 5/8" X-TYPE GYPSUM BOARD ON 2×6 STUDS @ 16" O/C C/W R-20 INSULATION 6 MIL. POLY'N V.B 1/2" GYPSUM BOARD (BETWEEN GARAGE & LIVING)

## **FOUNDATION**

- F1. DAMP PROOFING (WHERE REQUIRED) ON 8" THK. CONC. FOUNDATION WALL C/W 15 M BARS @ 24" O/C B/W
- F2. 16"X 8" CONC. FOOTINGS C/W 2 (TWO) 15M BARS CONT. 3 IN. FROM BOTT. ON UNDISTURBED SOIL (SOLID BEARING)
- F3. 4" PERIMETER DRAIN 3" TIGHT PIPE FOR RWL DRAIN ROCK
- ANCHOR BOLTS @ 4.0 FT. O/C MAX C/W SILL GASKETS
- F5. UNDER SLAB INSULATION 2 1/2" (RSI 2.15) EXTRUDED POLYSTYRENE RIGID INSULATION 4'-0" (1.2M) CONT. AROUND PERIMETER UNDER SLAB INSTALLED HORIZONTALLY (VERIFY WITH MUNICIPALITY DEPTH OF FROST LINE)

## Date

VICTORIA, B.C.

V9B 0A6

P. 250.382.7374

F. 250.382.7364

Nov 4, 2024

**Project Address** 3583 Temperate Place Lot 19 - Royal Bay Colwood, B.C. Prepared for

Verity Construction

Project #


8298-19


Scale

As Noted

Drawn By MRB

BASEPLAN A TYPE A

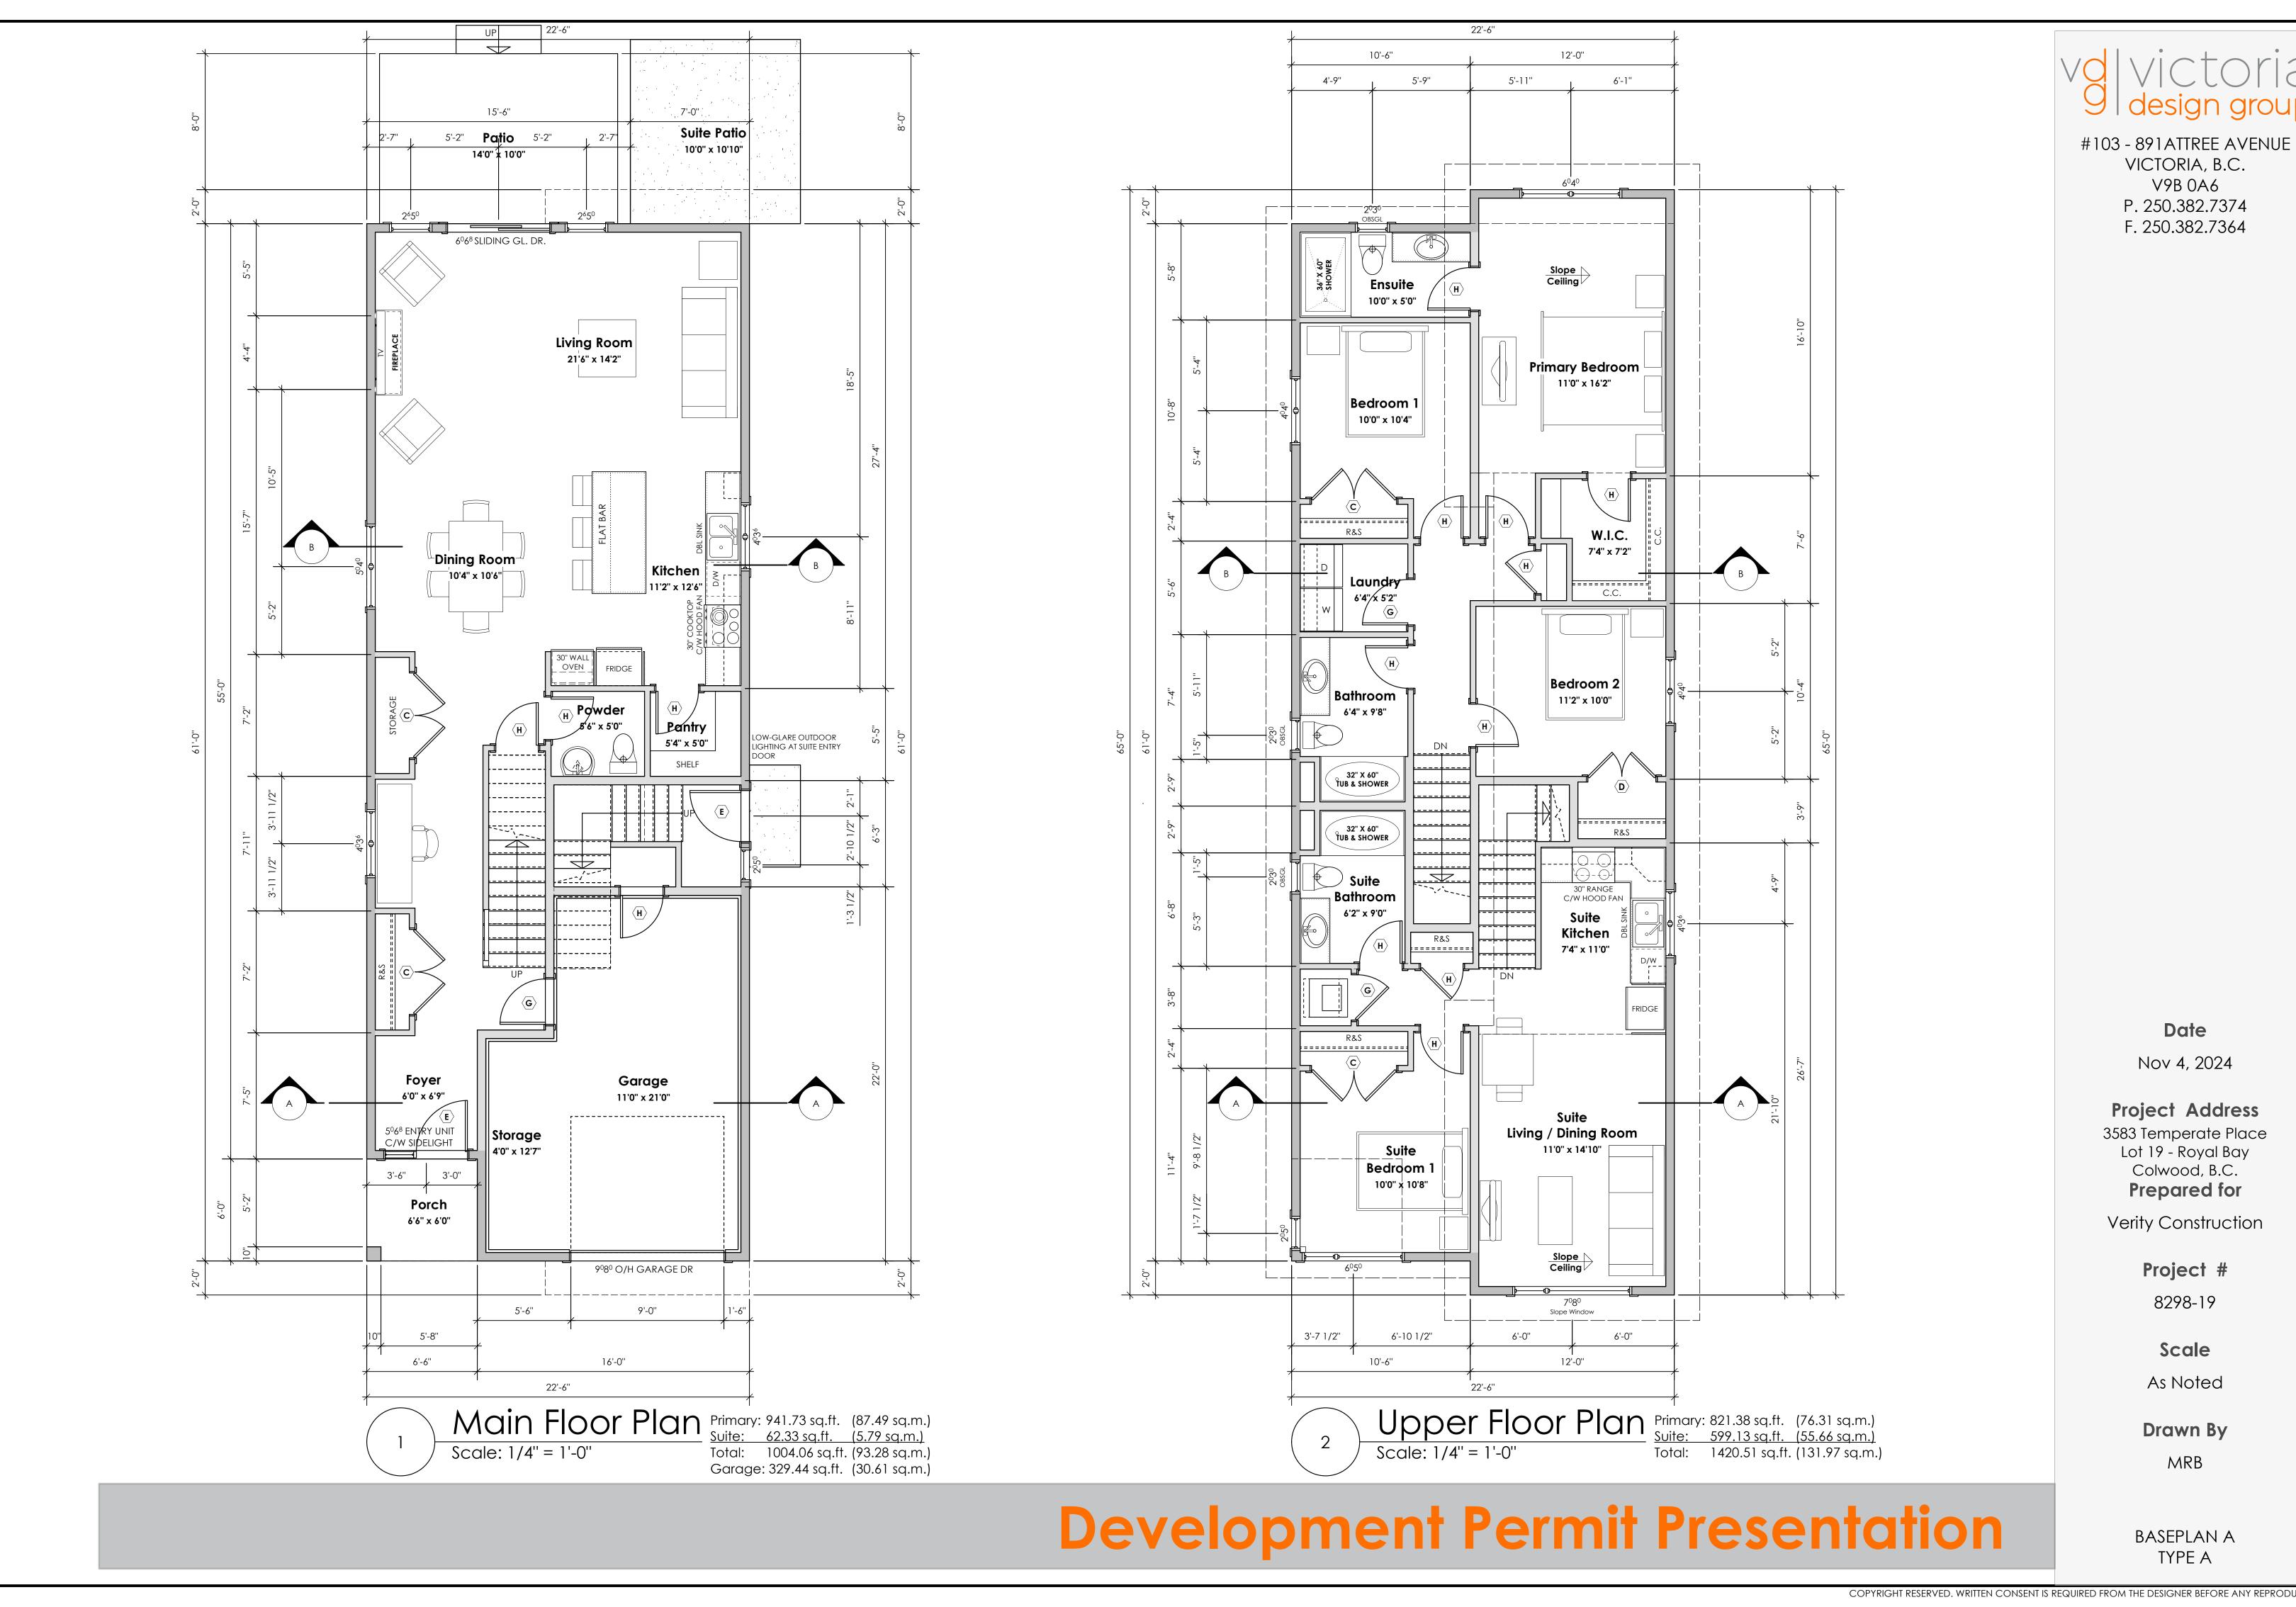

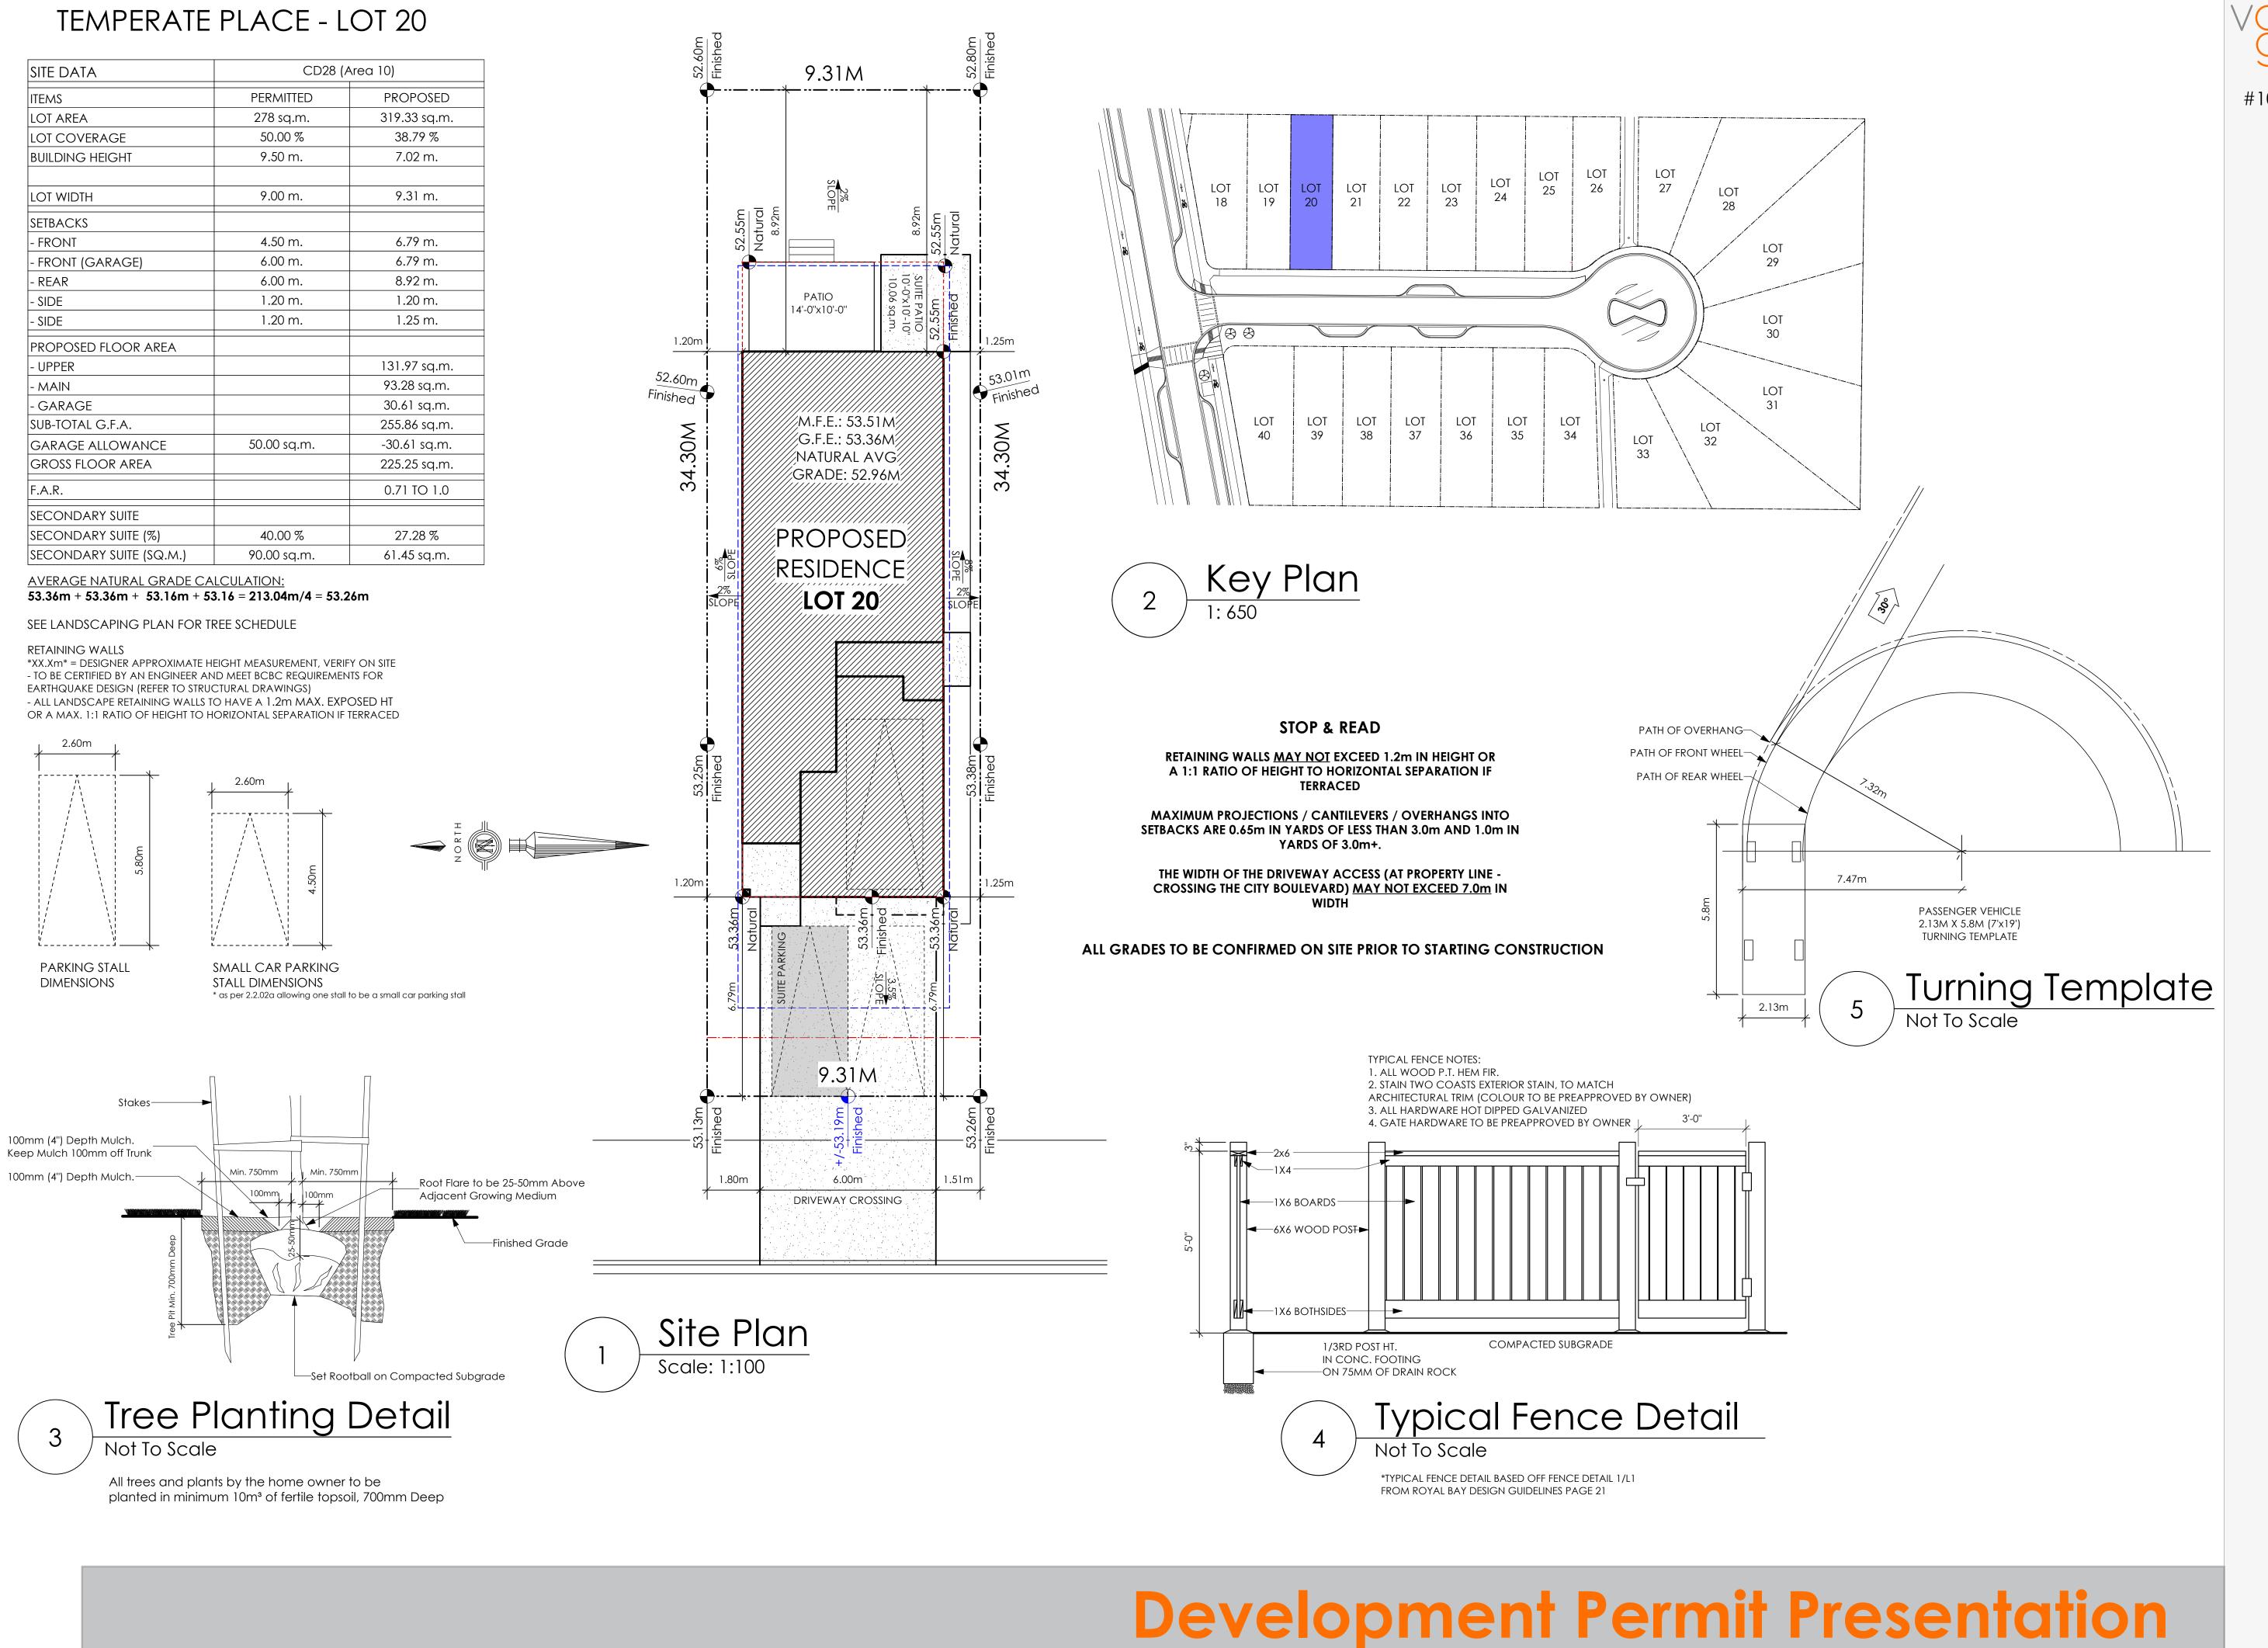

9 design group

#105 - 859 ORONO AVENUE VICTORIA, B.C. V9B 2T9 P. 250.382.7374 F. 250.382.7364

Date

Nov 4, 2024

**Project Address** 

3585 Temperate Place Lot 20 - Royal Bay Colwood, B.C. **Prepared for** 

Verity Construction

Project #

8298-20


Scale

As Noted


Drawn By

MIS

BASEPLAN A TYPE B

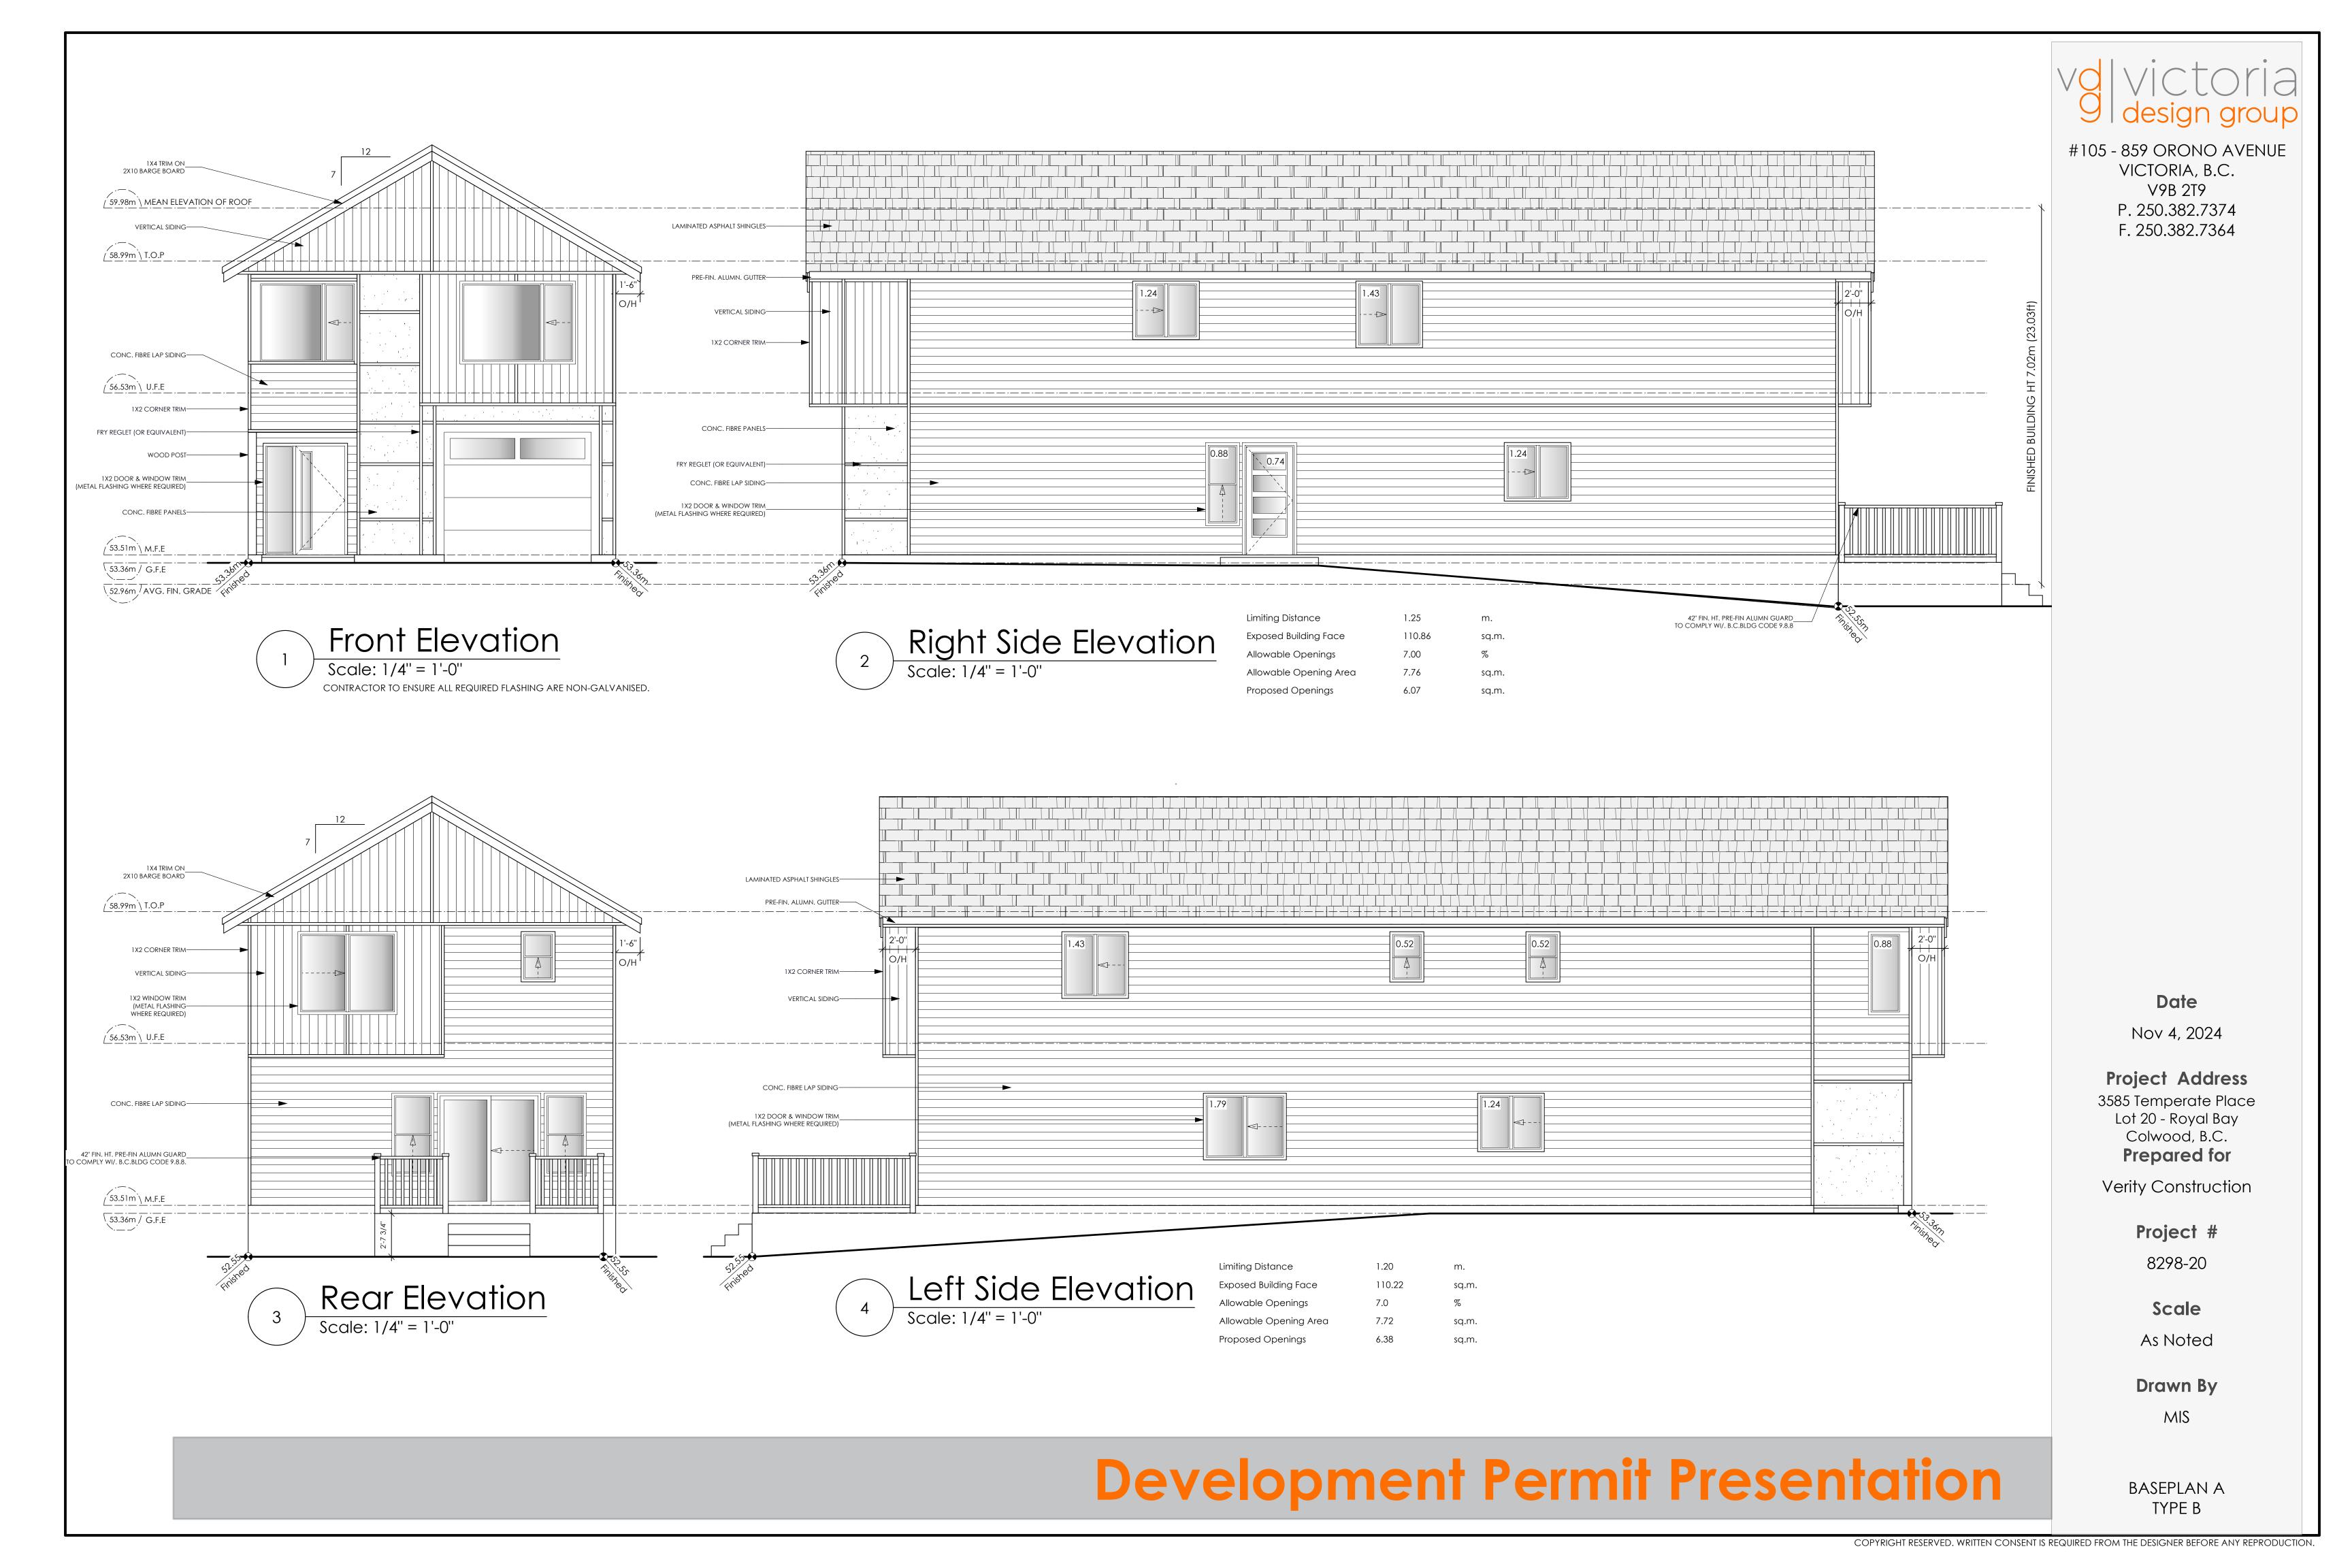



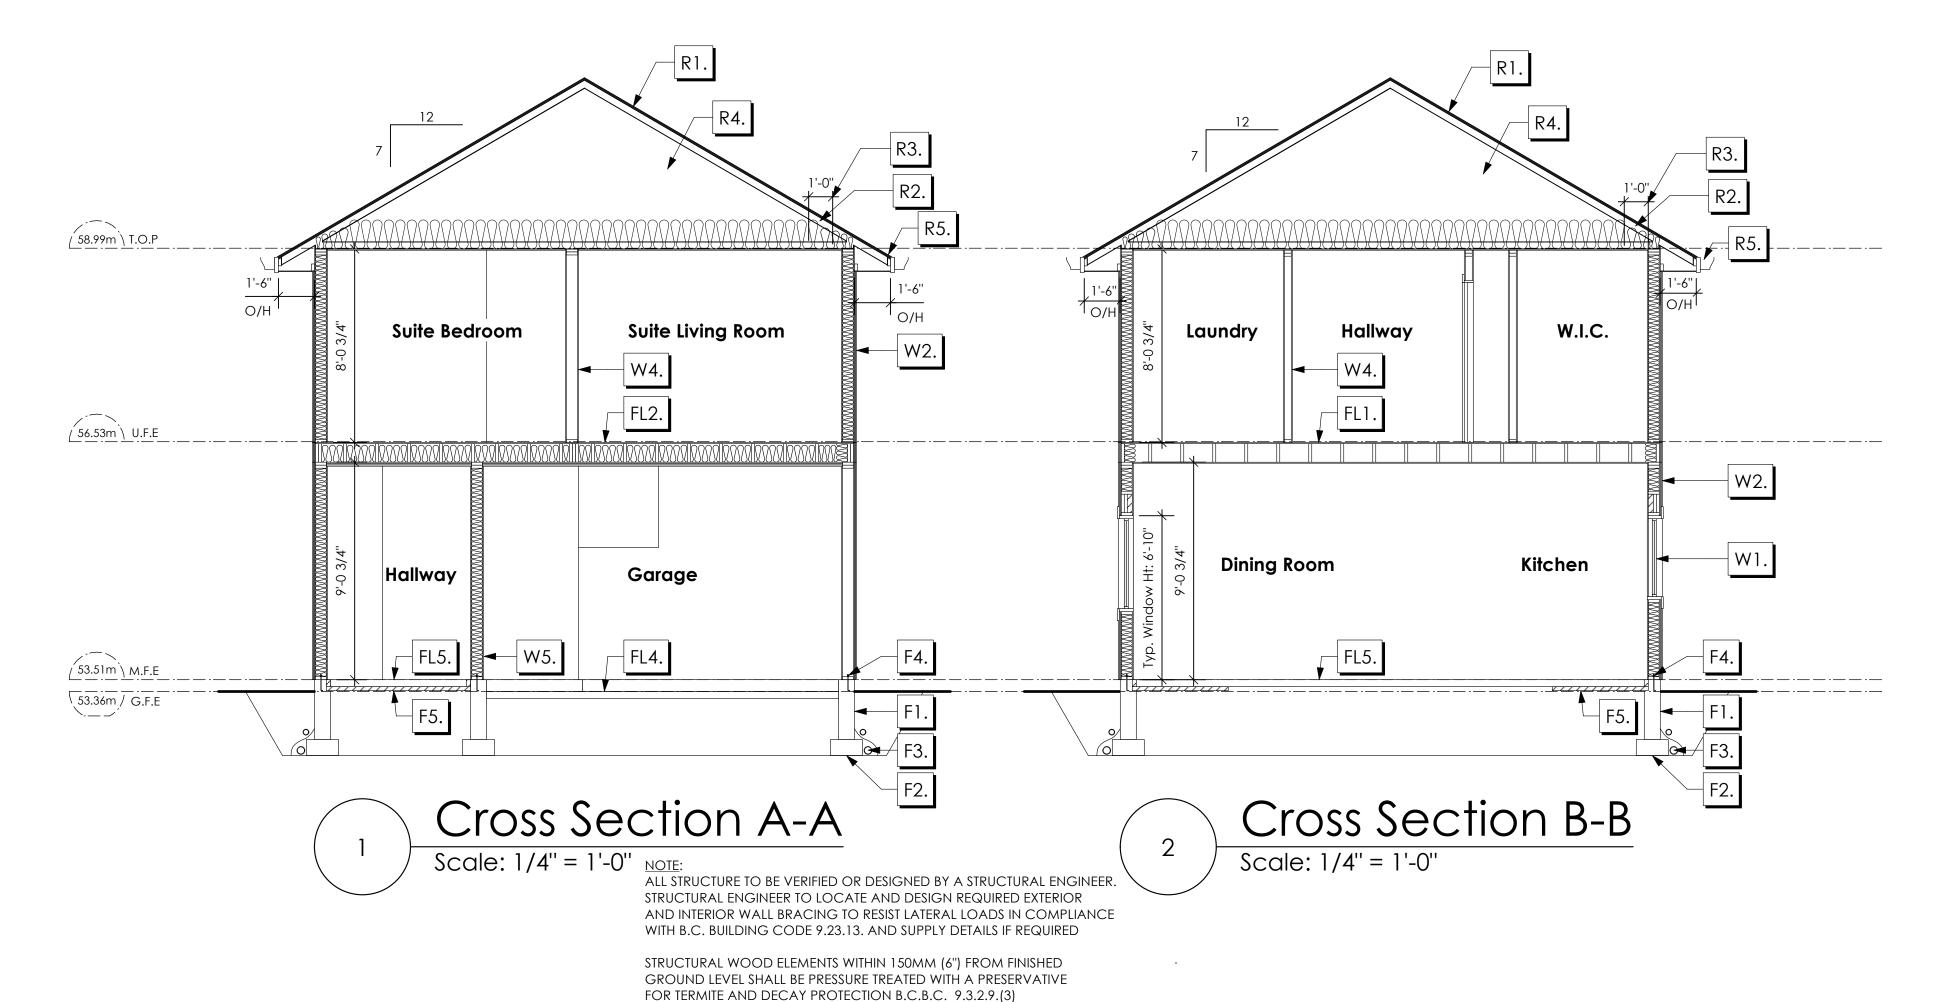

### ROOFS

R1. LAMINATED ASPHALT SHINGLES ON
7/16" ORIENTED STRAND BOARD C/W "H" CLIPS
WD TRUSSES (DESIGNED BY MANUF.)
R-40 FIBRE GLAS BATT INSULATION OR
14 1/2" FIBRE GLASS LOOSE FILL INSULATION
6 MIL POLY'N V.B.
5/8" GYPSUM BOARD OR
5/8" X-TYPE GYPSUM BOARD
45 MINUTE RATED F.R.R.
(OVER SECONDARY SUITE)

R2. PROVIDE 2 1/2" (63MM) CLEAR BETWEEN
R-20 INSULATION AND SHEATHING.
(MIN. R-20 @ ROOF-WALL CONNECTION FOR
4'-0" (1.2M) AROUND PERIMETER OF BUILDING.
AIR VENTILATION BAFFLES TO BE INSTALLED
WHERE REQUIRED IN AS PER BCBC 9.19.)

R3. EAVE PROTECTION

CONT. UP ROOF SLOPE FOR 12"

PAST EXTERIOR WALL.

R4. PROVIDE 1 SQ.FT. ATTIC VENT PER
300 SQ.FT. OF INSULATED AREA MIN.
25% OF REQUIRED TO BE @ TOP AND BOTTOM
(TO COMPLY WI. B.C. BLDG. CODE 9.19.1))

R5. PRE-FIN. FASCIA GUTTER
2×8 FASCIA BD.
2×4 SUB. FASCIA BD.
1/2" ORIENTED STRAND BOARD
VENTED SOFFIT
(SEE CONTRACTOR)

### **FLOORS**

FL1. FINISHED FLOORING ON
19/32" ORIENTED STRAND BOARD
(NAILED & GLUED TO FLOOR STRUCT. BELOW) ON
2×10 FLOOR JOISTS @ 16" OR 12" O/C
C/W 2×2 X-BRIDGING @ 7.0' O/C (MAX)
1/2" GYPSUM BOARD

FL2. B.C. BUILDING CODE (TABLE-9.10.3.1.B)
RATED FLOOR ASSEMBLY F8D
FINISHED FLOORING ON
11/16" ORIENTED STRAND BOARD
(FASTENED & GLUED TO FLOOR STRUCT. BELOW) ON
2×10 FLOOR JOISTS @ 16" OR 12" O/C
C/W 2×2 X-BRIDGING @ 7.0' O/C (MAX)
R-31 INSULATION
RESILIENT METAL CHANNELS @ 24" O/C
1 LAYERS 5/8" X-TYPE GYPSUM BOARD
30 MINUTE F.R.R., 50 S.T.C.

FL3. FINISHED FLOORING ON
11/16" ORIENTED STRAND BOARD
(FASTENED & GLUED TO FLOOR STRUCT. BELOW) ON
2×10 FLOOR JOISTS @ 16" OR 12" O/C
C/W 2×2 X-BRIDGING @ 7.0' O/C (MAX)
PROVIDE R-31 F/G BATT INSULATION IN
JOIST CAVITY C/W
BUILDING WRAP
VENTED SOFFIT (TO OWNERS SPEC'S)
TO ALL SUSPENDED FLOOR AREAS
(NOT SHOWN IN SECTION)

FL4. 3 1/2" CONCRETE SLAB
6 MIL. POLY'N V.B.
6" COMPACTED GRAVEL OR SAND
SLOPE TO DOORS 1"

FL5. 3 1/2" CONCRETE SLAB
6 MIL. POLY'N V.B.
6" COMPACTED GRAVEL OR SAND

FL6. 3 1/2" CONCRETE SLAB 6" COMPACTED GRAVEL OR SAND SLOPE MIN. 2% AWAY FROM BUILDING

### WALLS

W1. DOUBLE GLAZING
ENERGY STAR LOW "E" RATING IN
THERMAL BREAK FRAMES
2/2"X10" LINTEL OVER (@ bearing walls only)
(TYPICAL, wi. 2 1/2" XPS insulation)
FLASHING OVER @ EXTERIOR
(glazing in all exterior doors & within 3 ft.
of exterior doors to be shatterproof (SP))

W2. CONC. FIBRE BOARD ON
9.5MM (3/8") AIR SPACE / STRAPPING
3/8"×2" BORATE TREATED PLYWOOD STRAPPING
HOUSE WRAP (A.B.) (TYVEK OR EQ.)
7/16" ORIENTED STRAND BOARD SHEATHING
2×6 STUDS @ 16" O/C
R-20 INSULATION
6 MIL. POLYETHYLENE VAPOUR BARRIER
1/2" GYPSUM BOARD

W3. B.C. BUILDING CODE (TABLE 9.10.3.1.A)
RATED WALL ASSEMBLY W3C
1 LAYER 1/2" X-TYPE GYPSUM BOARD
RESILIENT METAL CHANNELS @ 24" O/C
2×4 STUDS @ 16" O/C OR
2×6 STUDS @ 16" O/C (IF NOTED) C/W
3 1/2" FIBRE GLASS SOUND BATTS
1 LAYER 1/2" X-TYPE GYPSUM BOARD
45 MIN. F.R.R 43 S.T.C
(BETWEEN PRIMARY LIVING & SECONDARY SUITE)
(NOT SHOWN IN SECTION)

W4. INTERIOR PARTITION

1/2" GYPSUM BOARD ON EACH SIDE

OF 2×4 STUDS @ 16" O/C OR

2×6 STUDS @ 16" O/C (IF NOTED)

W5. 5/8" X-TYPE GYPSUM BOARD ON 2×6 STUDS @ 16" O/C C/W R-20 INSULATION 6 MIL. POLY'N V.B 1/2" GYPSUM BOARD (BETWEEN GARAGE & LIVING)

## FOUNDATION

F1. DAMP PROOFING (WHERE REQUIRED) ON 8" THK. CONC. FOUNDATION WALL C/W 15 M BARS @ 24" O/C B/W

F2. 16"X 8" CONC. FOOTINGS

C/W 2 (TWO) 15M BARS CONT. 3 IN. FROM BOTT.

ON UNDISTURBED SOIL (SOLID BEARING)

F3. 4" PERIMETER DRAIN
3" TIGHT PIPE FOR RWL
DRAIN ROCK

F4. ANCHOR BOLTS @ 4.0 FT. O/C MAX C/W SILL GASKETS

F5. UNDER SLAB INSULATION
2 1/2" (RSI 2.15) EXTRUDED POLYSTYRENE
RIGID INSULATION 4'-0" (1.2M)
CONT. AROUND PERIMETER UNDER
SLAB INSTALLED HORIZONTALLY
(VERIFY WITH MUNICIPALITY DEPTH OF FROST LINE)

## Date

Nov 4, 2024

Project Address
3585 Temperate Place
Lot 20 - Royal Bay
Colwood, B.C.
Prepared for

Verity Construction

Project #

8298-20


Scale

As Noted

Drawn By

MIS

BASEPLAN A TYPE B

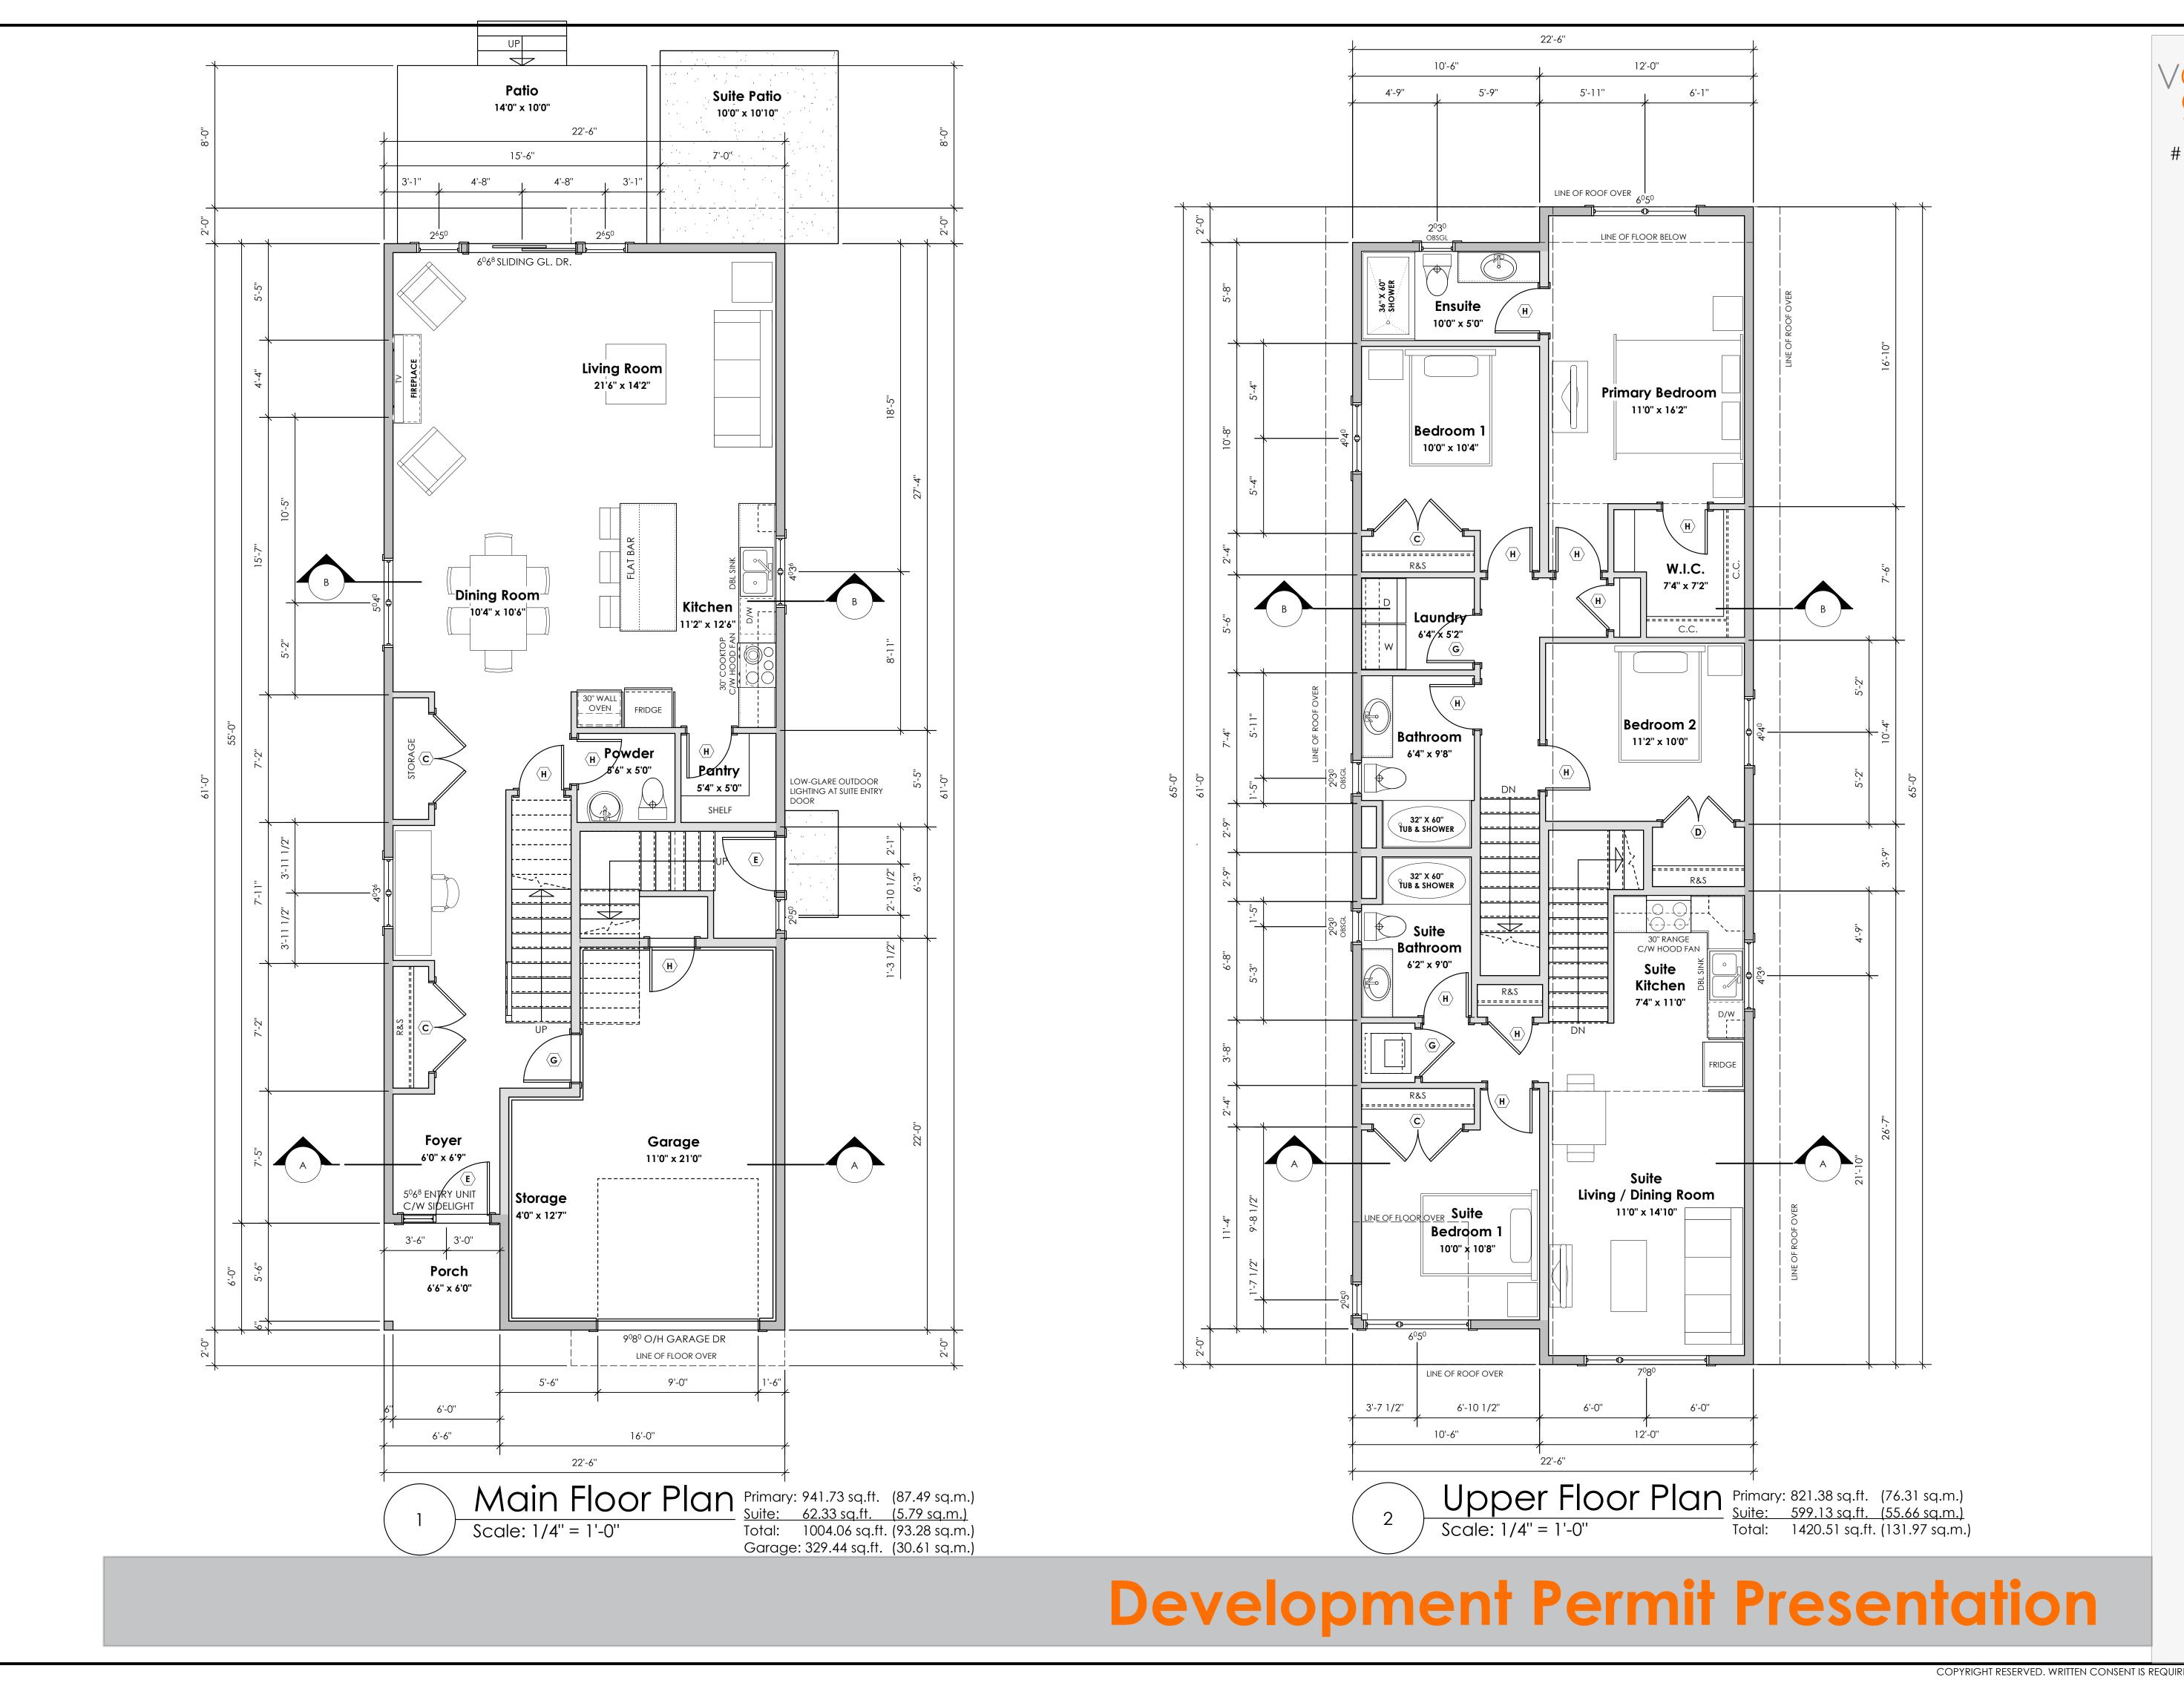

volvictoria 9 design group

#105 - 859 ORONO AVENUE VICTORIA, B.C. V9B 2T9 P. 250.382.7374 F. 250.382.7364

Date

Nov 4, 2024

Project Address

3585 Temperate Place Lot 20 - Royal Bay Colwood, B.C. **Prepared for** 

Verity Construction

Project #

8298-20

Scale

As Noted

Drawn By

MIS

BASEPLAN A TYPE B

## TEMPERATE PLACE - LOT 21

SITE DATA	CD28 - AREA 10	
ITEMS	PERMITTED	PROPOSED
LOT AREA	278 sq.m.	360.84 sq.m.
LOT COVERAGE	50.00 %	39.94 %
BUILDING HEIGHT	9.50 m.	7.15 m.
LOT WIDTH	9.00 m.	10.52 m.
SETBACKS		
- FRONT	4.50 m.	7.72 m.
- FRONT (GARAGE)	6.00 m.	7.72 m.
- REAR	6.00 m.	9.05 m.
- SIDE	1.20 m.	1.20 m.
- SIDE	1.20 m.	1.24 m.
PROPOSED FLOOR AREA		
- UPPER		144.08 sq.m.
- MAIN		94.79 sq.m.
- GARAGE		38.83 sq.m.
SUB-TOTAL G.F.A.		277.70 sq.m.
GARAGE ALLOWANCE	50.00 sq.m.	-38.83 sq.m.
GROSS FLOOR AREA		238.87 sq.m.
F.A.R.		0.66 TO 1.0
SECONDARY SUITE		
SECONDARY SUITE (%)	40.00 %	28.30 %
SECONDARY SUITE (SQ.M.)	90.00 sq.m.	67.61 sq.m.


AVERAGE NATURAL GRADE CALCULATION: 53.50m + 53.50m + 53.00m + 53.00 = 213.00/4 = 53.25m

### SEE LANDSCAPING PLAN FOR TREE SCHEDULE

### RETAINING WALLS


DIMENSIONS

\*XX.Xm\* = DESIGNER APPROXIMATE HEIGHT MEASUREMENT, VERIFY ON SITE
- TO BE CERTIFIED BY AN ENGINEER AND MEET BCBC REQUIREMENTS FOR
EARTHQUAKE DESIGN (REFER TO STRUCTURAL DRAWINGS)
- ALL LANDSCAPE RETAINING WALLS TO HAVE A 1.2m MAX. EXPOSED HT
OR A MAX. 1:1 RATIO OF HEIGHT TO HORIZONTAL SEPARATION IF TERRACED

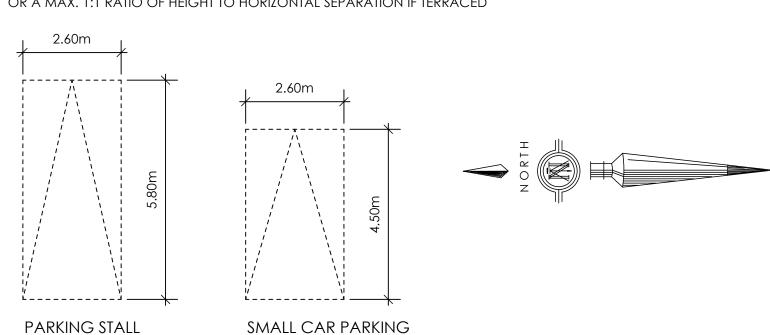

 $^{st}$  as per 2.2.02a allowing one stall to be a small car parking stall


STALL DIMENSIONS

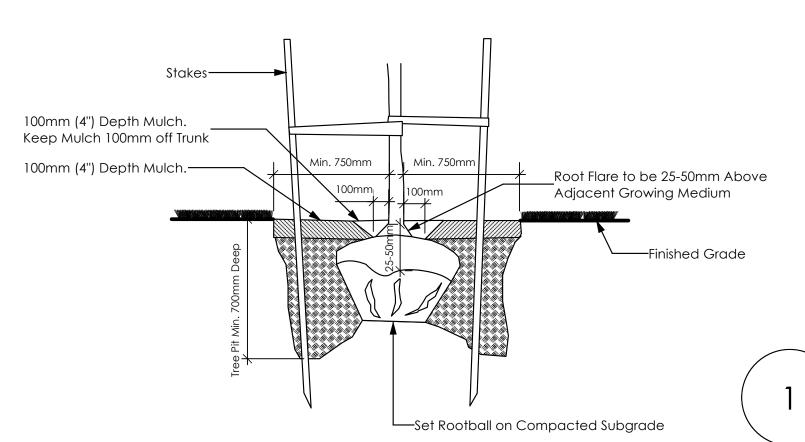

Tree Planting Detail

Not To Scale

All trees and plants by the home owner to be planted in minimum 10m³ of fertile topsoil, 700mm Deep

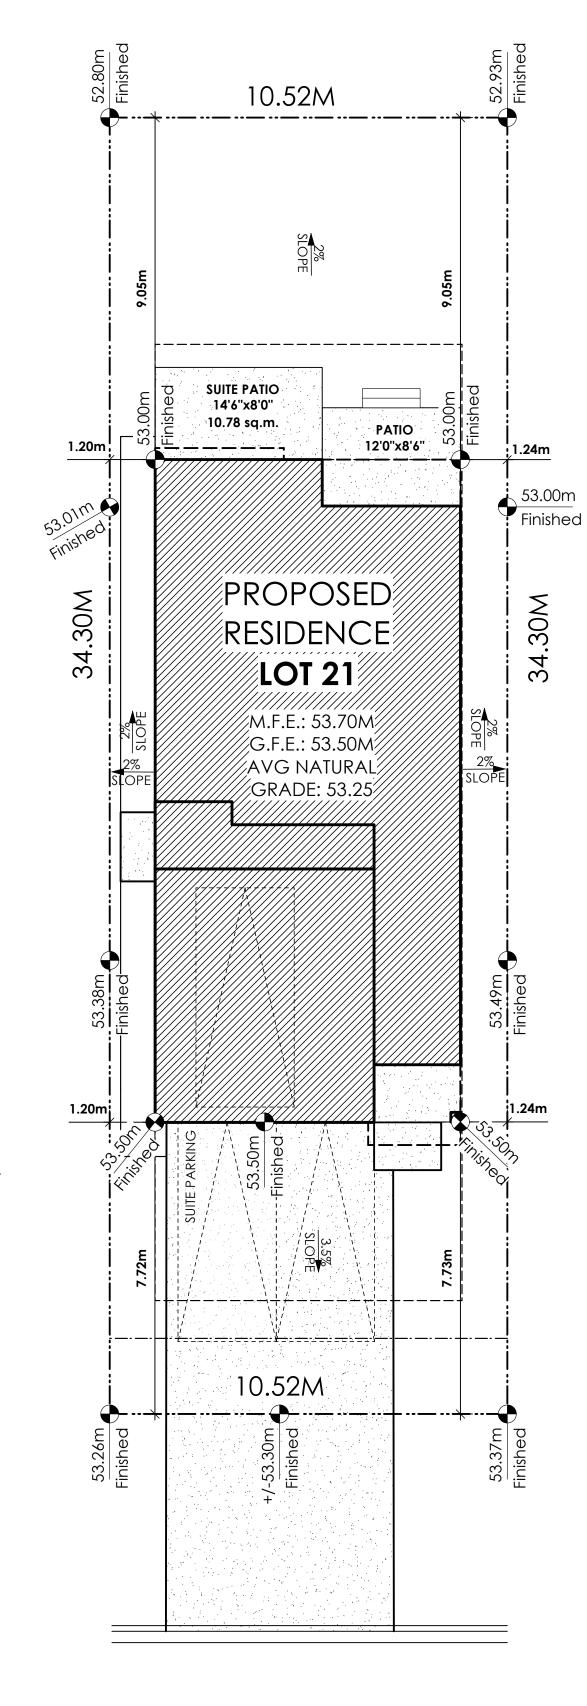

Site Plan

Scale: 1:100

LOT LOT LOT 26 LOT LOT LOT 25 LOT 19 LOT LOT LOT LOT LOT 38 37 36 LOT

2 Key Plan
1: 600


### STOP & READ

RETAINING WALLS <u>MAY NOT</u> EXCEED 1.2m IN HEIGHT OR A 1:1 RATIO OF HEIGHT TO HORIZONTAL SEPARATION IF

MAXIMUM PROJECTIONS / CANTILEVERS / OVERHANGS INTO SETBACKS ARE 0.65m IN YARDS OF LESS THAN 3.0m AND 1.0m IN YARDS OF 3.0m+.

THE WIDTH OF THE DRIVEWAY ACCESS (AT PROPERTY LINE - CROSSING THE CITY BOULEVARD) MAY NOT EXCEED 7.0m IN WIDTH


ALL GRADES TO BE CONFIRMED ON SITE PRIOR TO STARTING CONSTRUCTION

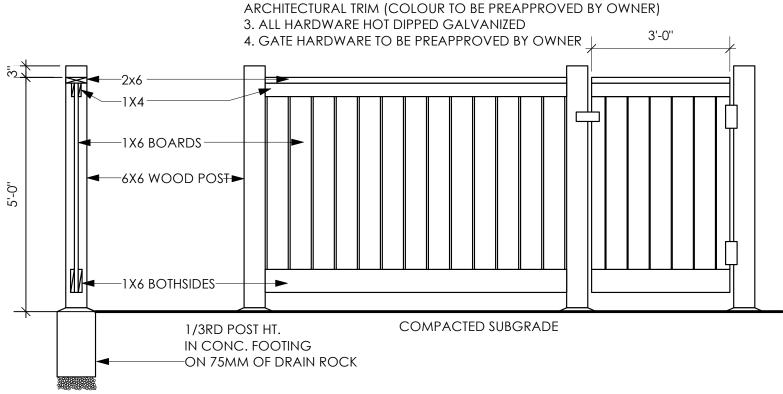

2. STAIN TWO COASTS EXTERIOR STAIN, TO MATCH

TYPICAL FENCE NOTES:

1. ALL WOOD P.T. HEM FIR.

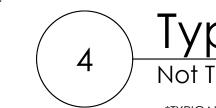

Typical Fence Detail
Not To Scale

\*TYPICAL FENCE DETAIL BASED OFF FENCE DETAIL 1/L1 FROM ROYAL BAY DESIGN GUIDELINES PAGE 21

# Development Permit Presentation

PATH OF OVERHANG-

PATH OF FRONT WHEEL-

PATH OF REAR WHEEL-

7.47m

2.13m

PASSENGER VEHICLE 2.13M X 5.8M (7'x19')

TURNING TEMPLATE

Not To Scale

Turning Template

volvictoria design group

#105 - 859 ORONO AVENUE VICTORIA, B.C. V9B 2T9 P. 250.382.7374 F. 250.382.7364

Date

Nov 4, 2024

Project Address
3587 Temperate Place
Lot 21 - Royal Bay
Colwood, B.C.
Prepared for

Verity Construction

Project #

8298-21


Scale


As Noted

Drawn By

MIS

BASEPLAN D TYPE B

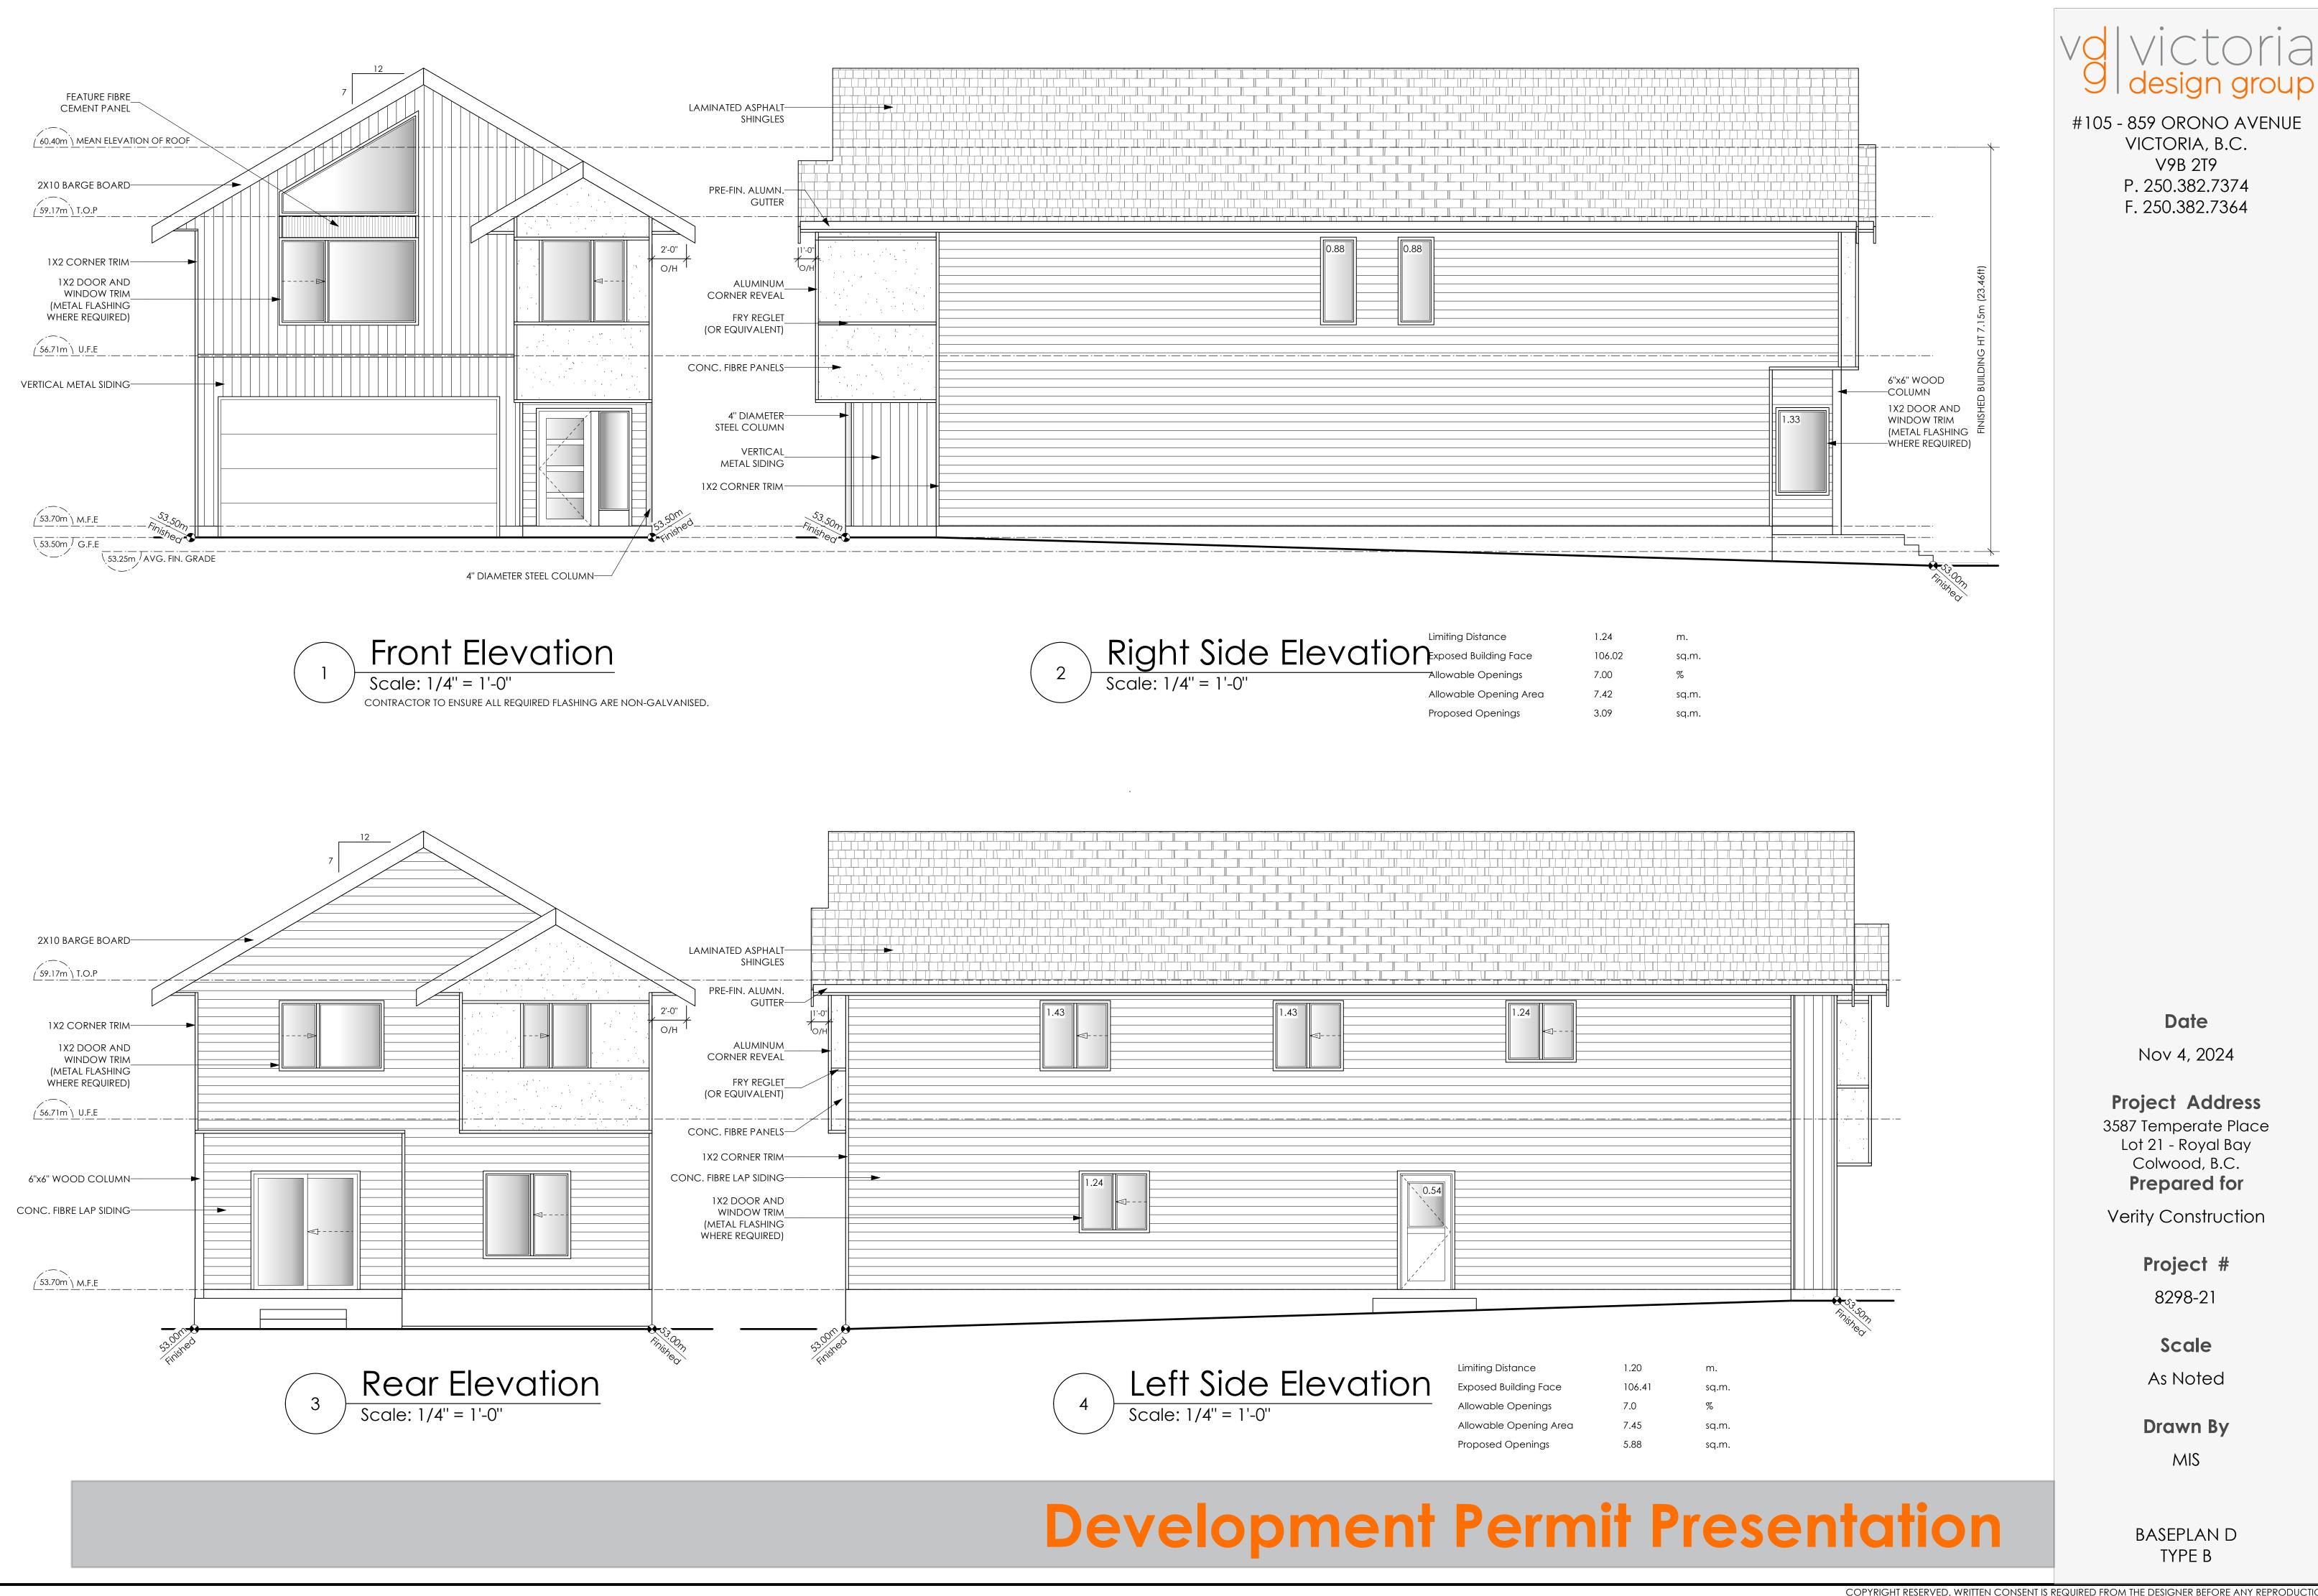

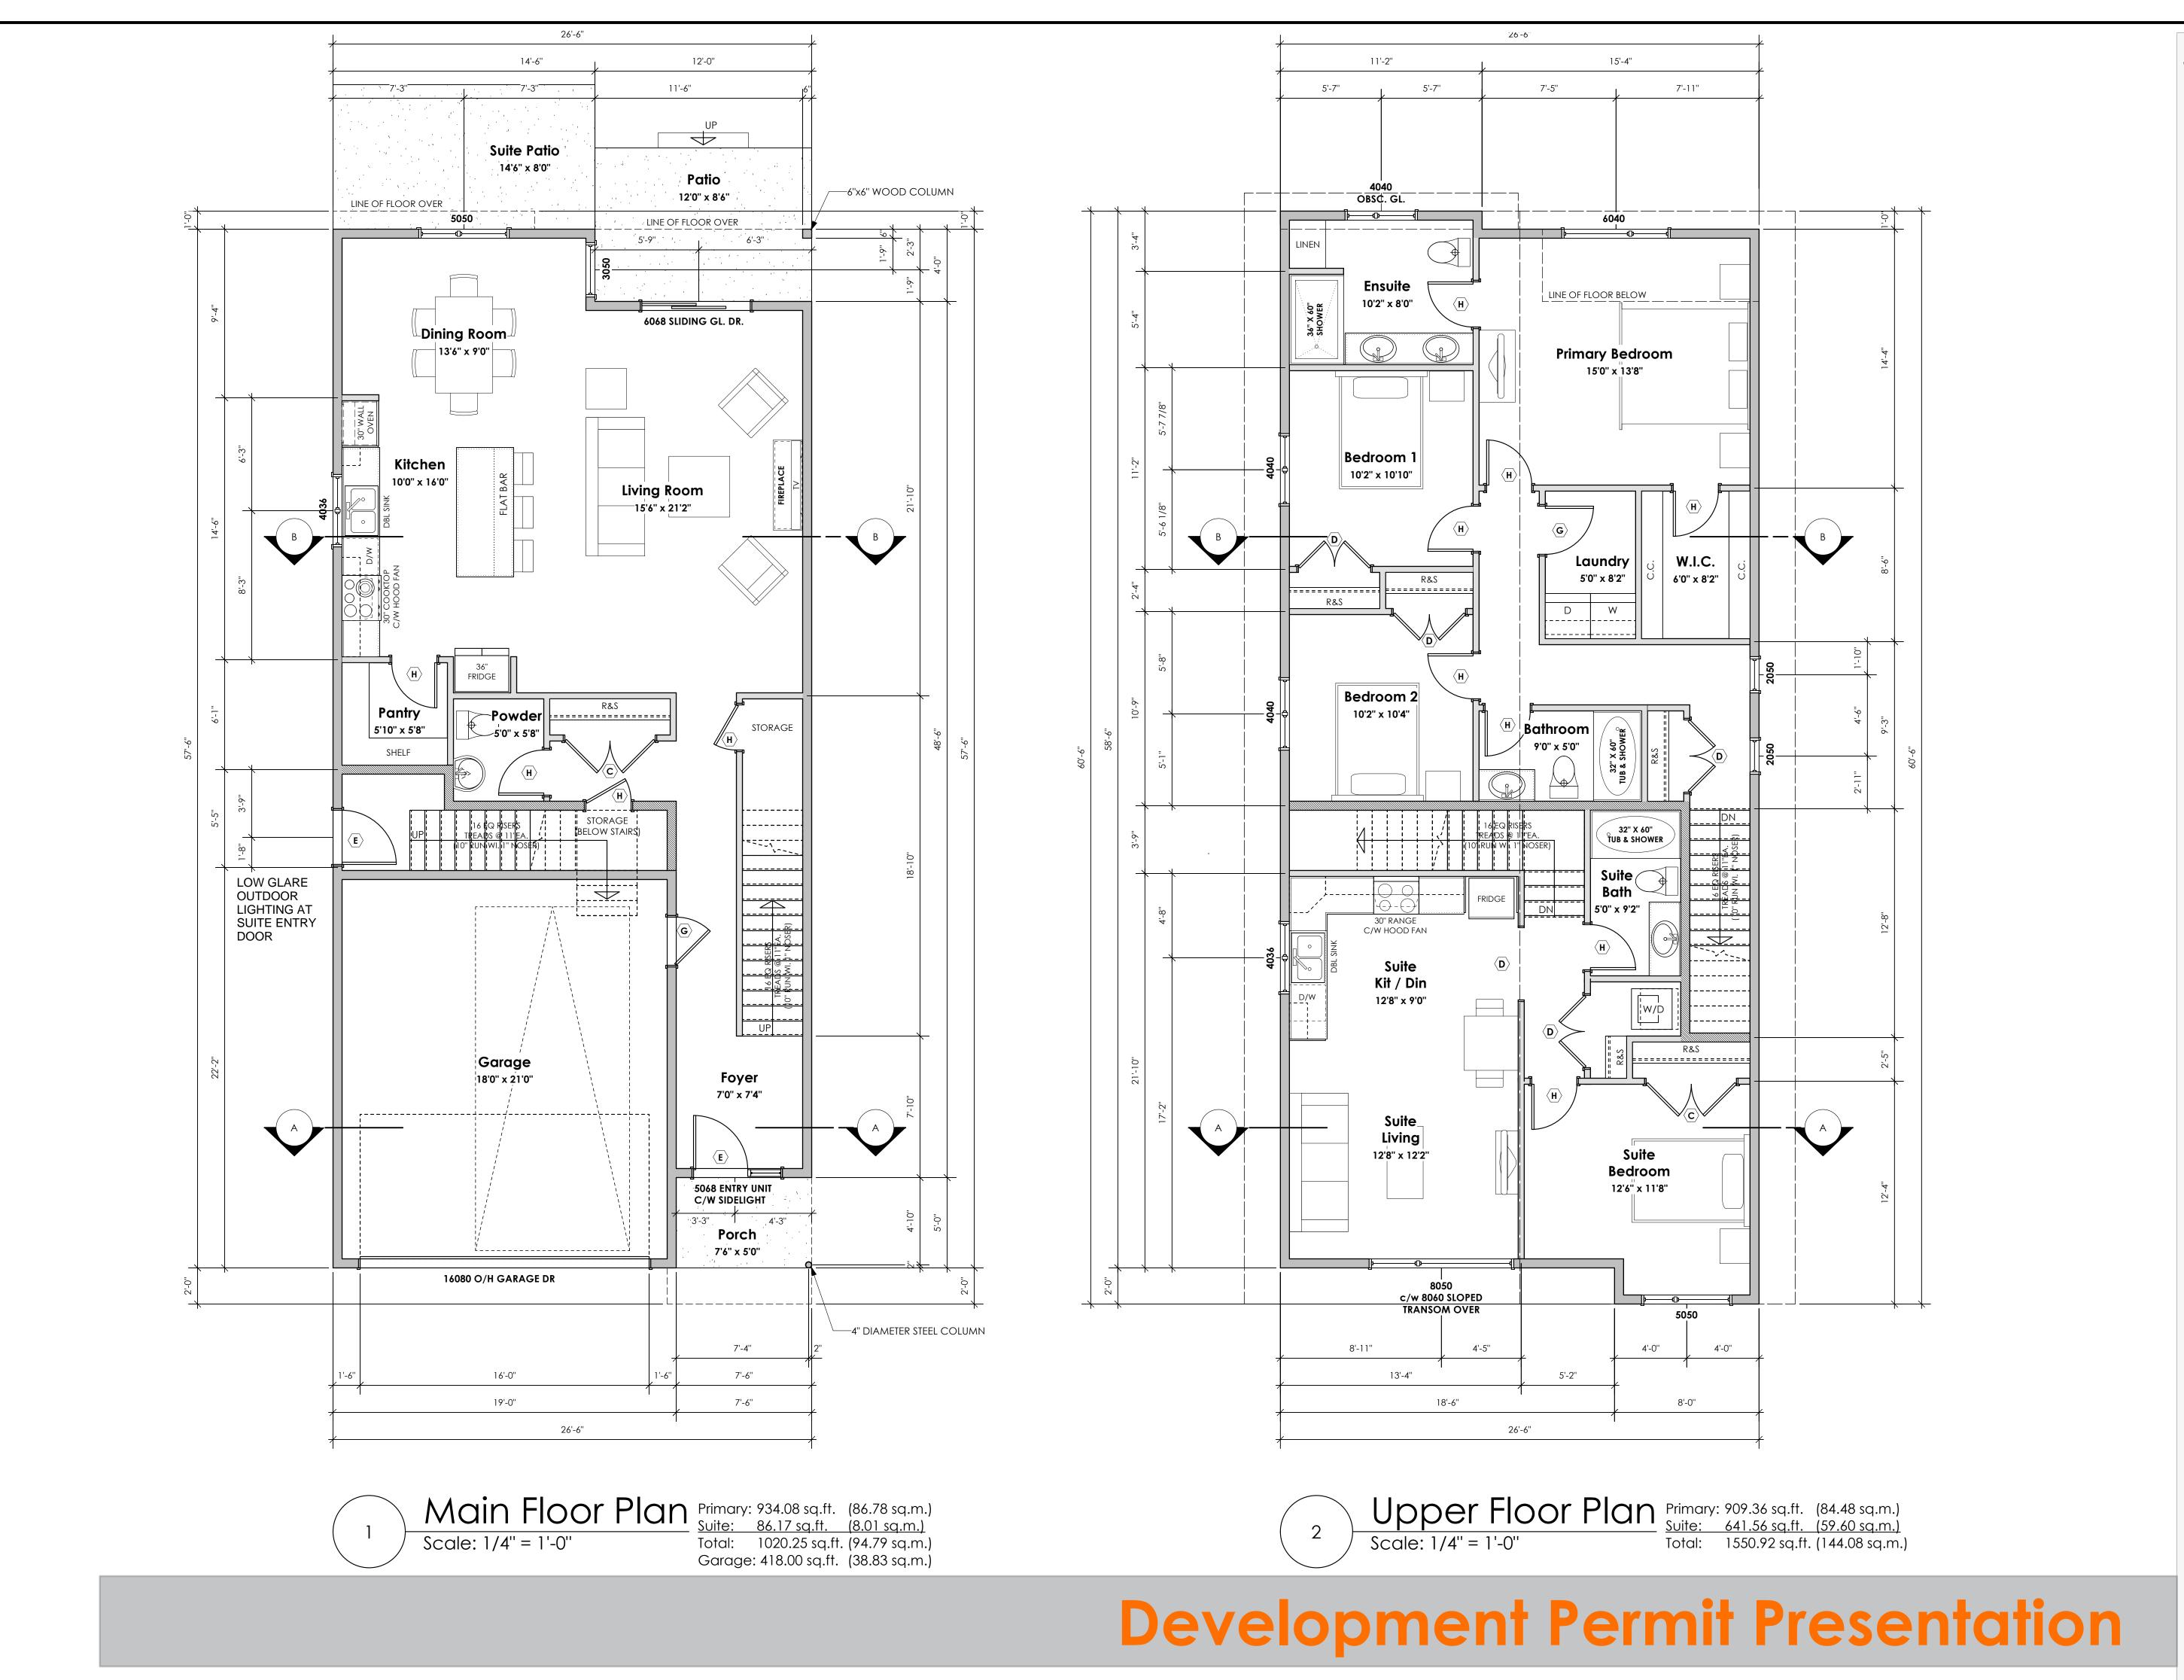

COPYRIGHT RESERVED. WRITTEN CONSENT IS REQUIRED FROM THE DESIGNER BEFORE ANY REPRODUCTION.

#105 - 859 ORONO AVENUE

VICTORIA, B.C.

V9B 2T9

P. 250.382.7374

F. 250.382.7364

Date

Nov 4, 2024

**Project Address** 

3587 Temperate Place Lot 21 - Royal Bay

Colwood, B.C.

Prepared for

Verity Construction

Project #

8298-21

Scale


As Noted

Drawn By

MIS

BASEPLAN D

TYPE B

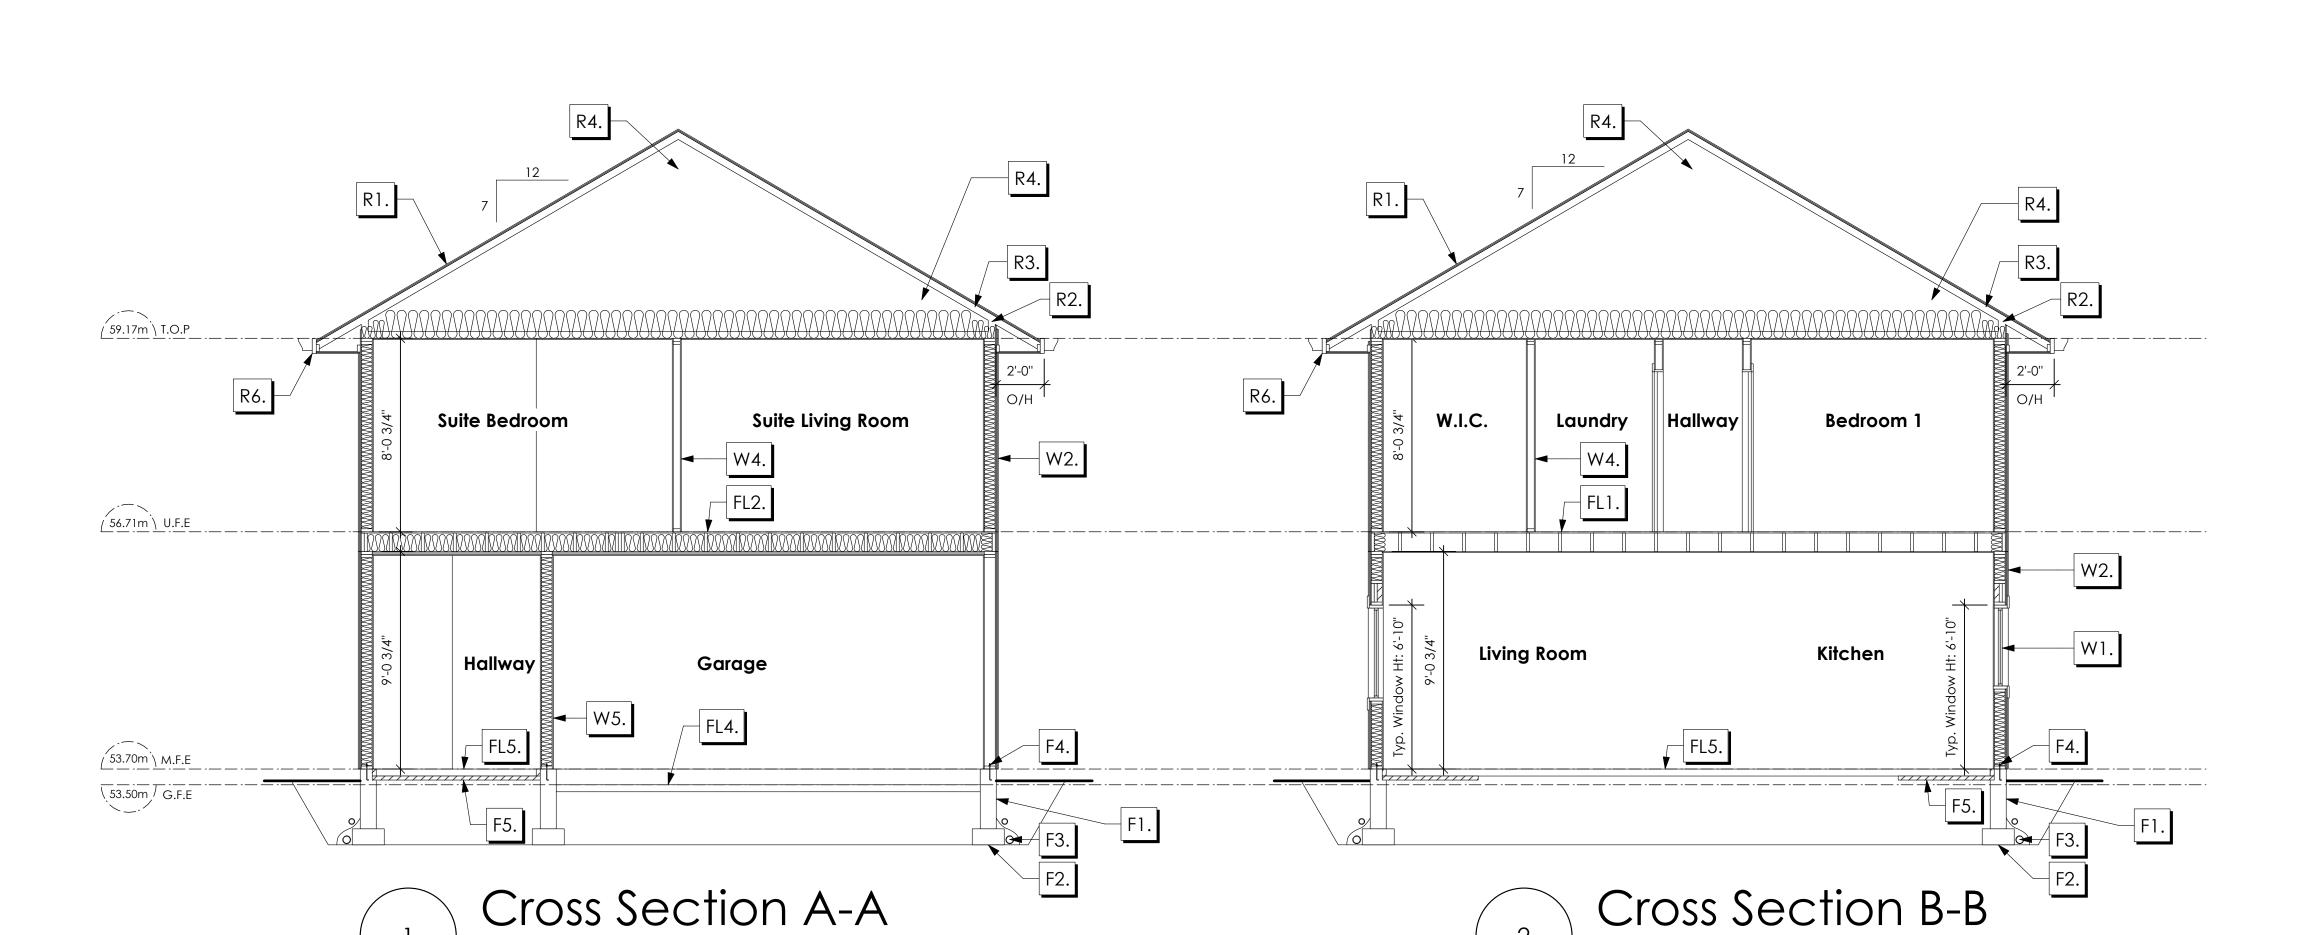

### ROOFS

R1. LAMINATED ASPHALT SHINGLES ON
7/16" ORIENTED STRAND BOARD C/W "H" CLIPS
WD TRUSSES (DESIGNED BY MANUF.)
R-40 FIBRE GLAS BATT INSULATION OR
14 1/2" FIBRE GLASS LOOSE FILL INSULATION
6 MIL POLY'N V.B.
5/8" GYPSUM BOARD OR
5/8" X-TYPE GYPSUM BOARD
45 MINUTE RATED F.R.R.
(OVER SECONDARY SUITE)

Scale: 1/4" = 1'-0"

- R2. PROVIDE 2 1/2" (63MM) CLEAR BETWEEN R-20 INSULATION AND SHEATHING.
  (MIN. R-20 @ ROOF-WALL CONNECTION FOR 4'-0" (1.2M) AROUND PERIMETER OF BUILDING. AIR VENTILATION BAFFLES TO BE INSTALLED WHERE REQUIRED IN AS PER BCBC 9.19.)
- R3. EAVE PROTECTION

  CONT. UP ROOF SLOPE FOR 12"

  PAST EXTERIOR WALL.
- R4. PROVIDE 1 SQ.FT. ATTIC VENT PER
  300 SQ.FT. OF INSULATED AREA MIN.
  25% OF REQUIRED TO BE @ TOP AND BOTTOM
  (TO COMPLY WI. B.C. BLDG. CODE 9.19.1)
- R5. PRE-FIN. FASCIA GUTTER
  2×8 FASCIA BD.
  2×4 SUB. FASCIA BD.
  VENTED SOFFIT
  (SEE CONTRACTOR)
  (NOT SHOWN IN SECTION)
- R6. PRE-FIN. FASCIA GUTTER
  2×8 FASCIA BD.
  2×4 SUB. FASCIA BD.
  1/2" ORIENTED STRAND BOARD
  VENTED SOFFIT
  (SEE CONTRACTOR)

### **FLOORS**

FL1. FINISHED FLOORING ON
19/32" ORIENTED STRAND BOARD
(NAILED & GLUED TO FLOOR STRUCT. BELOW) ON
2×10 FLOOR JOISTS @ 16" OR 12" O/C
C/W 2×2 X-BRIDGING @ 7.0' O/C (MAX)
1/2" GYPSUM BOARD

FL2. B.C. BUILDING CODE (TABLE-9.10.3.1.B)

- RATED FLOOR ASSEMBLY F8D
  FINISHED FLOORING ON
  11/16" ORIENTED STRAND BOARD
  (FASTENED & GLUED TO FLOOR STRUCT. BELOW) ON
  2×10 FLOOR JOISTS @ 16" OR 12" O/C
  C/W 2×2 X-BRIDGING @ 7.0' O/C (MAX)
  R-31 INSULATION
  RESILIENT METAL CHANNELS @ 24" O/C
  1 LAYERS 5/8" X-TYPE GYPSUM BOARD
  30 MINUTE F.R.R., 50 S.T.C.
- FL3. FINISHED FLOORING ON
  11/16" ORIENTED STRAND BOARD
  (FASTENED & GLUED TO FLOOR STRUCT. BELOW) ON
  2×10 FLOOR JOISTS @ 16" OR 12" O/C
  C/W 2×2 X-BRIDGING @ 7.0' O/C (MAX)
  PROVIDE R-31 F/G BATT INSULATION IN
  JOIST CAVITY C/W
  BUILDING WRAP
  VENTED SOFFIT (TO OWNERS SPEC'S)
  TO ALL SUSPENDED FLOOR AREAS
- FL4. 3 1/2" CONCRETE SLAB
  6 MIL. POLY'N V.B.
  6" COMPACTED GRAVEL OR SAND
  SLOPE TO DOORS 1"

(NOT SHOWN IN SECTION)

- FL5. 3 1/2" CONCRETE SLAB 6 MIL. POLY'N V.B. 6" COMPACTED GRAVEL OR SAND
- FL6. 3 1/2" CONCRETE SLAB
  6" COMPACTED GRAVEL OR SAND
  SLOPE MIN. 2% AWAY FROM BUILDING

### WALLS

STRUCTURAL WOOD ELEMENTS WITHIN 150MM (6") FROM FINISHED

FOR TERMITE AND DECAY PROTECTION B.C.B.C. 9.3.2.9.(3)

- W1. DOUBLE GLAZING
  ENERGY STAR LOW "E" RATING IN
  THERMAL BREAK FRAMES
  2/2"X10" LINTEL OVER (@ bearing walls only)
  (TYPICAL, wi. 2 1/2" XPS insulation)
  FLASHING OVER @ EXTERIOR
  (glazing in all exterior doors & within 3 ft.
  of exterior doors to be shatterproof (SP))
- W2. CONC. FIBRE BOARD ON
  9.5MM (3/8") AIR SPACE / STRAPPING
  3/8"×2" BORATE TREATED PLYWOOD STRAPPING
  HOUSE WRAP (A.B.) (TYVEK OR EQ.)
  7/16" ORIENTED STRAND BOARD SHEATHING
  2×6 STUDS @ 16" O/C
  R-20 INSULATION
  6 MIL. POLYETHYLENE VAPOUR BARRIER
  1/2" GYPSUM BOARD
- W3. B.C. BUILDING CODE (TABLE 9.10.3.1.A)
  RATED WALL ASSEMBLY W3c
  1 LAYER 1/2" X-TYPE GYPSUM BOARD
  RESILIENT METAL CHANNELS @ 24" O/C
  2×4 STUDS @ 16" O/C OR
  2×6 STUDS @ 16" O/C (IF NOTED) C/W
  3 1/2" FIBRE GLASS SOUND BATTS
  1 LAYER 1/2" X-TYPE GYPSUM BOARD
  45 MIN. F.R.R 43 S.T.C
  (BETWEEN PRIMARY LIVING & SECONDARY SUITE)
  (NOT SHOWN IN SECTION)
- W4. INTERIOR PARTITION

  1/2" GYPSUM BOARD ON EACH SIDE

  OF 2×4 STUDS @ 16" O/C OR

  2×6 STUDS @ 16" O/C (IF NOTED)
- W5. 5/8" X-TYPE GYPSUM BOARD ON 2×6 STUDS @ 16" O/C C/W
  R-20 INSULATION
  6 MIL. POLY'N V.B
  1/2" GYPSUM BOARD
  (BETWEEN GARAGE & LIVING)

### FOUNDATION

- F1. DAMP PROOFING (WHERE REQUIRED) ON 8" THK. CONC. FOUNDATION WALL C/W 15 M BARS @ 24" O/C B/W
- F2. 16"X 8" CONC. FOOTINGS

  C/W 2 (TWO) 15M BARS CONT. 3 IN. FROM BOTT.

  ON UNDISTURBED SOIL (SOLID BEARING)

Scale: 1/4" = 1'-0"

- F3. 4" PERIMETER DRAIN
  3" TIGHT PIPE FOR RWL
  DRAIN ROCK
- F4. ANCHOR BOLTS @ 4.0 FT. O/C MAX C/W SILL GASKETS
- F5. UNDER SLAB INSULATION
  2 1/2" (RSI 2.15) EXTRUDED POLYSTYRENE
  RIGID INSULATION 4'-0" (1.2M)
  CONT. AROUND PERIMETER UNDER
  SLAB INSTALLED HORIZONTALLY
  (VERIFY WITH MUNICIPALITY DEPTH OF FROST LINE)

# volvictoria 9 design group

#105 - 859 ORONO AVENUE VICTORIA, B.C. V9B 2T9 P. 250.382.7374 F. 250.382.7364

Date

Nov 4, 2024

Project Address
3587 Temperate Place
Lot 21 - Royal Bay
Colwood, B.C.
Prepared for

Verity Construction

Project #

8298-21


Scale

As Noted

Drawn By

MIS


BASEPLAN D TYPE B

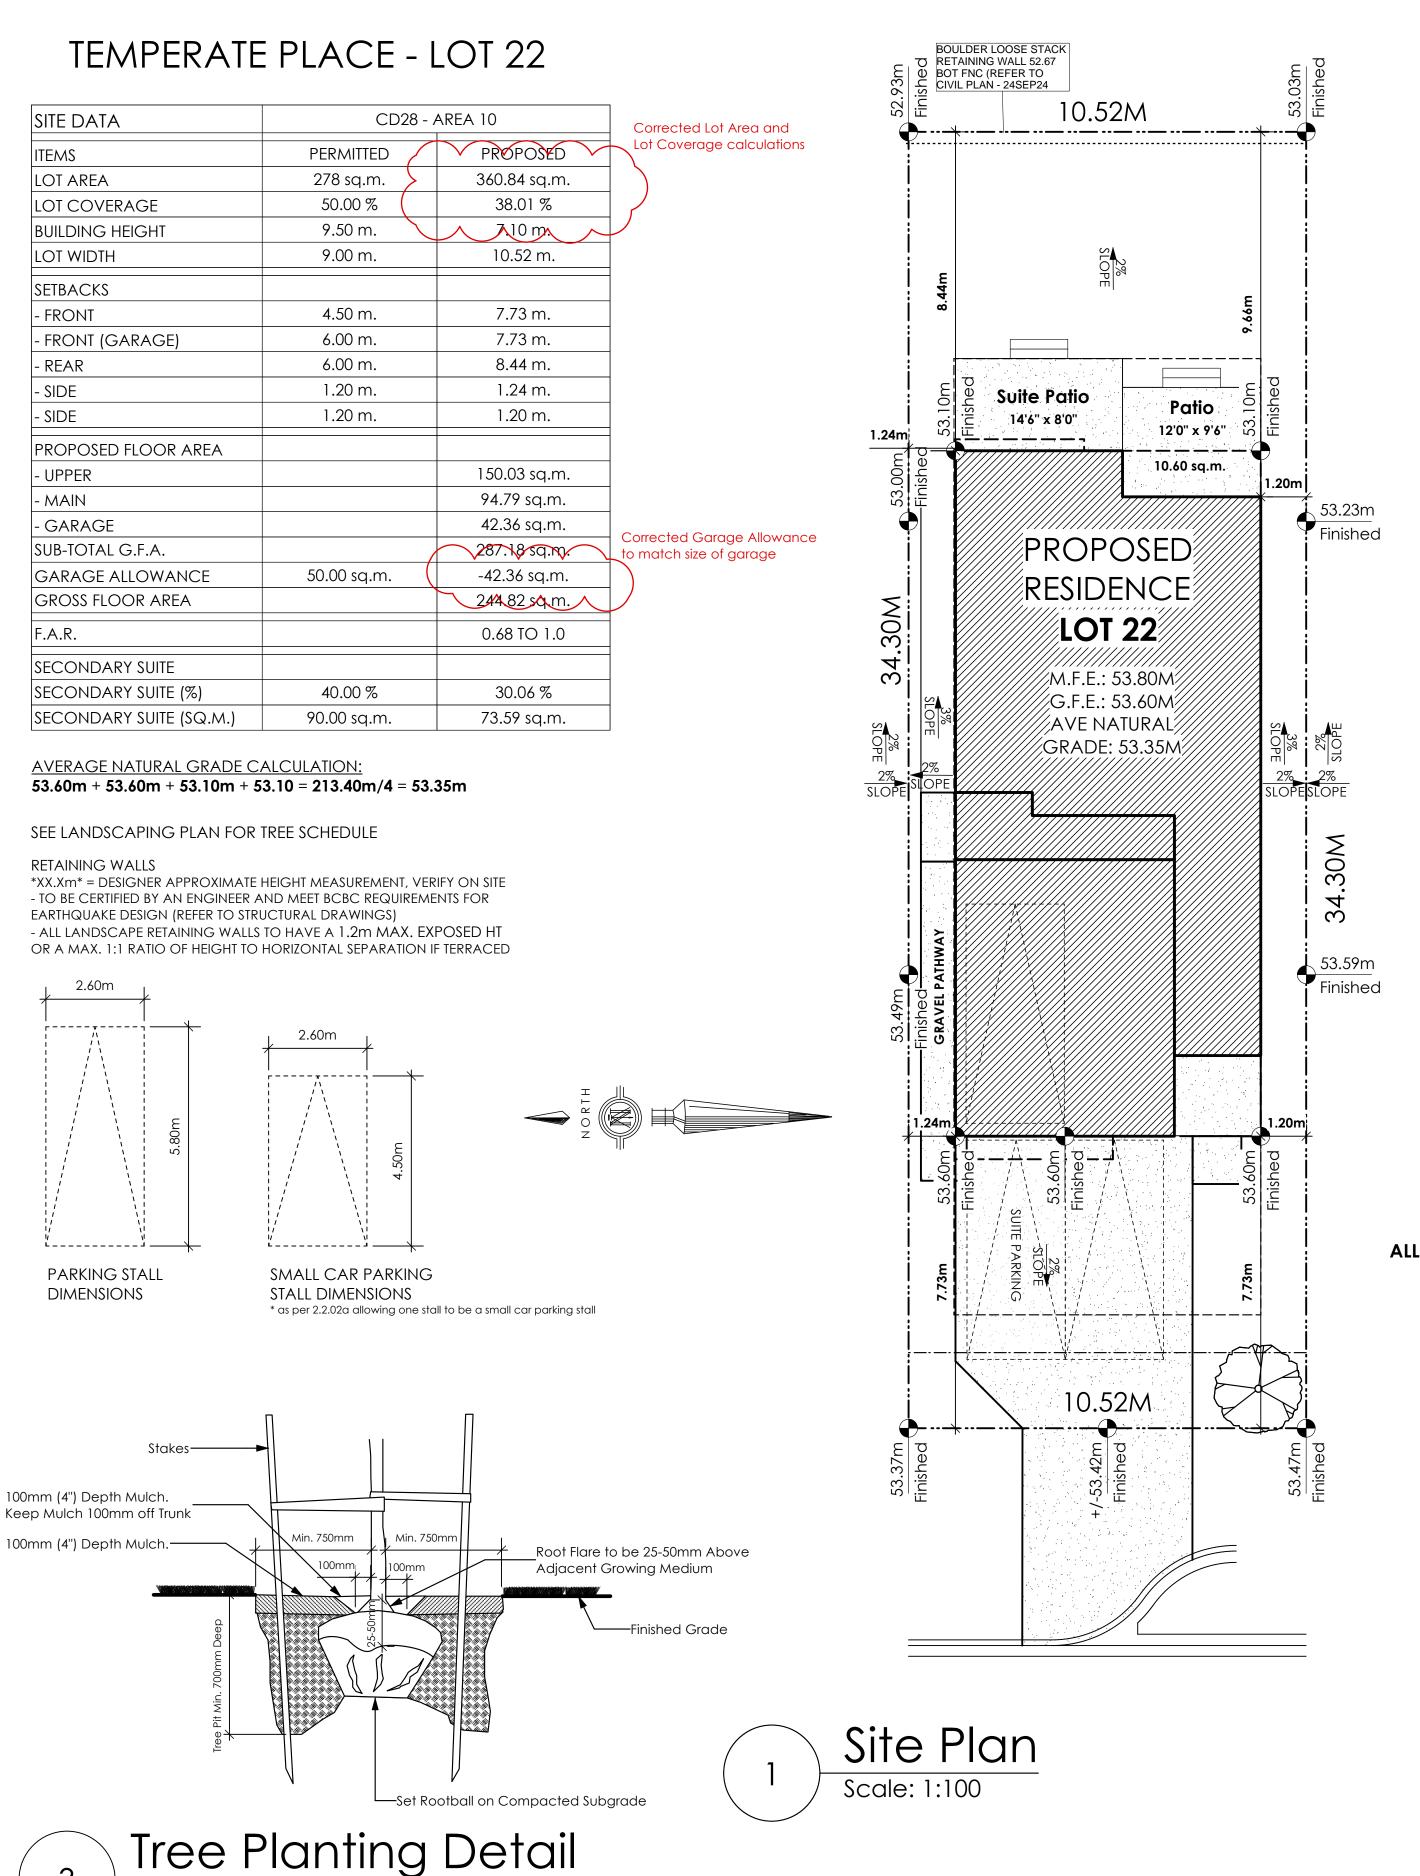

Not To Scale

All trees and plants by the home owner to be

planted in minimum 10m³ of fertile topsoil, 700mm Deep

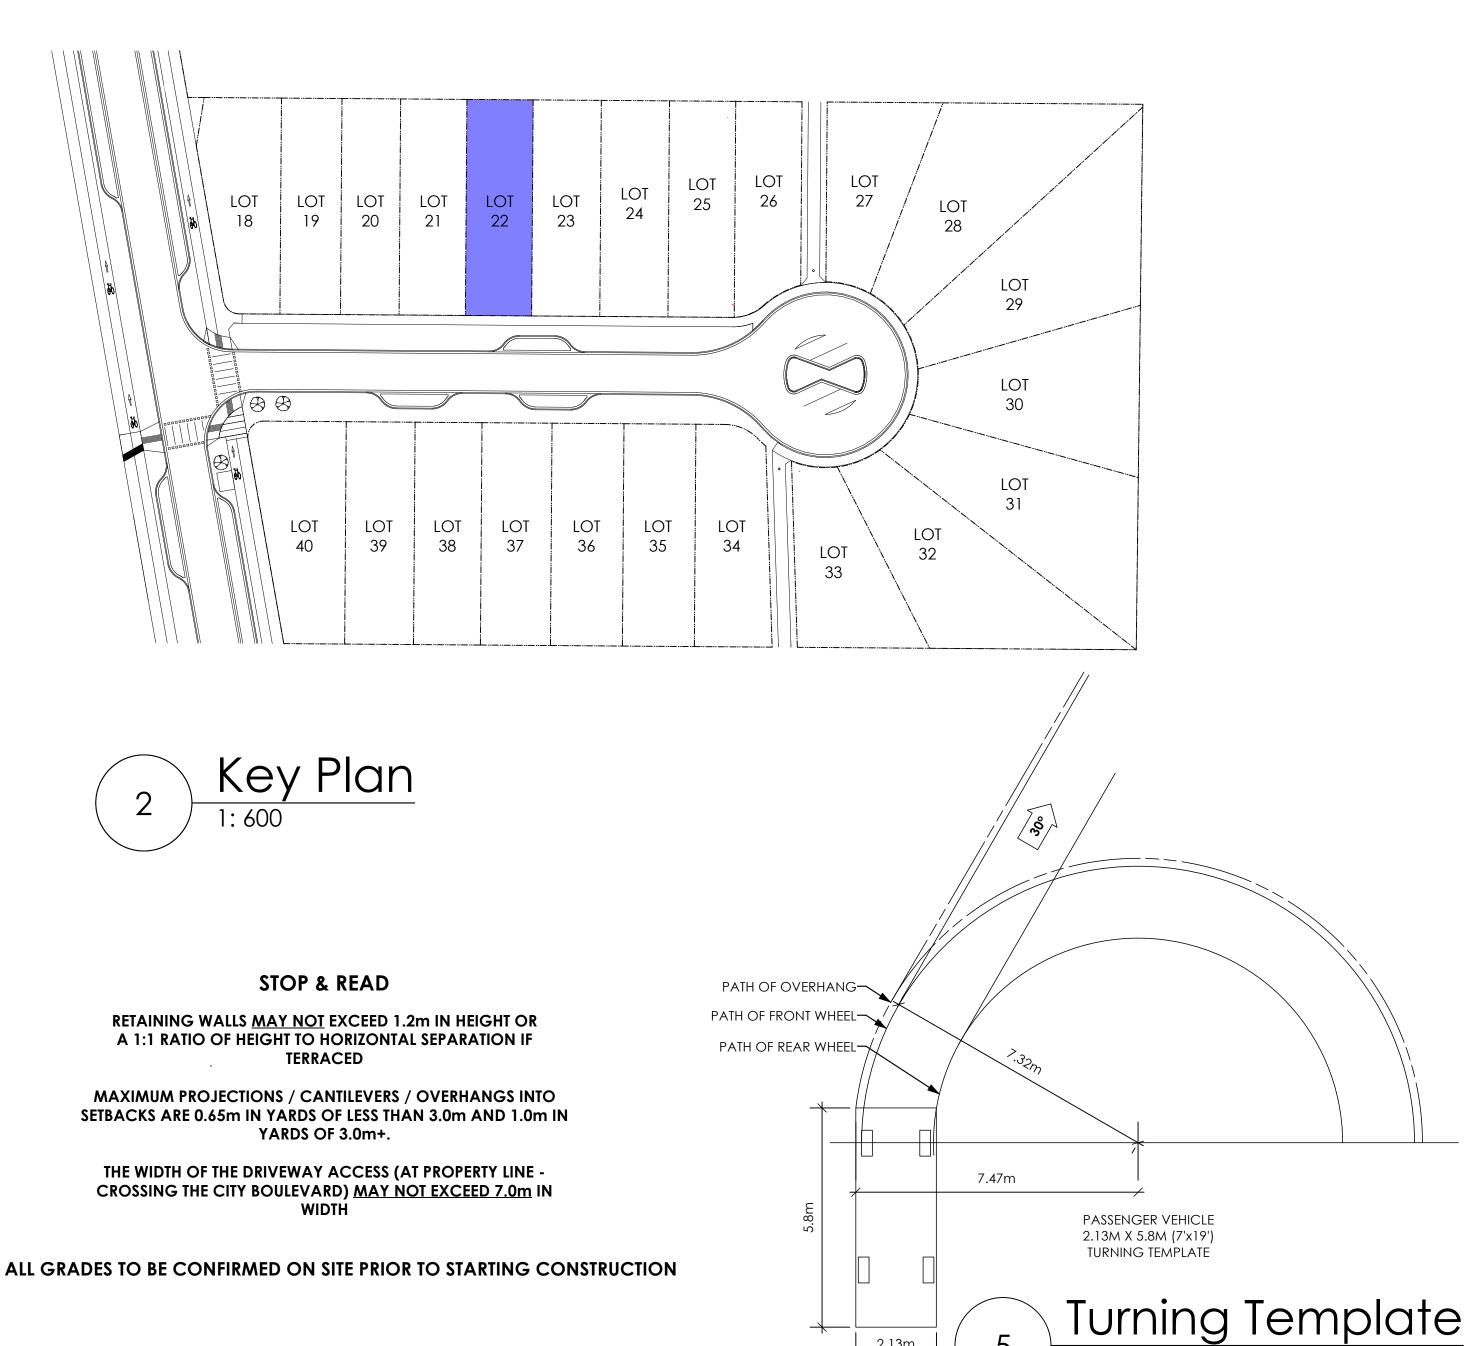

1. ALL WOOD P.T. HEM FIR. 2. STAIN TWO COASTS EXTERIOR STAIN, TO MATCH ARCHITECTURAL TRIM (COLOUR TO BE PREAPPROVED BY OWNER) 3. ALL HARDWARE HOT DIPPED GALVANIZED 4. GATE HARDWARE TO BE PREAPPROVED BY OWNER -1X6 BOARDS 6X6 WOOD POST► -1X6 BOTHSIDES-COMPACTED SUBGRADE 1/3RD POST HT. IN CONC. FOOTING ON 75MM OF DRAIN ROCK



Typical Fence Detail

Not To Scale

TYPICAL FENCE NOTES:

\*TYPICAL FENCE DETAIL BASED OFF FENCE DETAIL 1/L1 FROM ROYAL BAY DESIGN GUIDELINES PAGE 21

## Verity Construction

Date

Nov 14, 2024

**Project Address** 

3589 Temperate Place

Lot 22 - Royal Bay

Colwood, B.C.

Prepared for

#105 - 859 ORONO AVENUE

VICTORIA, B.C.

V9B 2T9

P. 250.382.7374

F. 250.382.7364

Project #

8298-22

Scale

As Noted


Drawn By MIS


BASEPLAN D TYPE D

# Development Permit Presentation

2.13m

Not To Scale

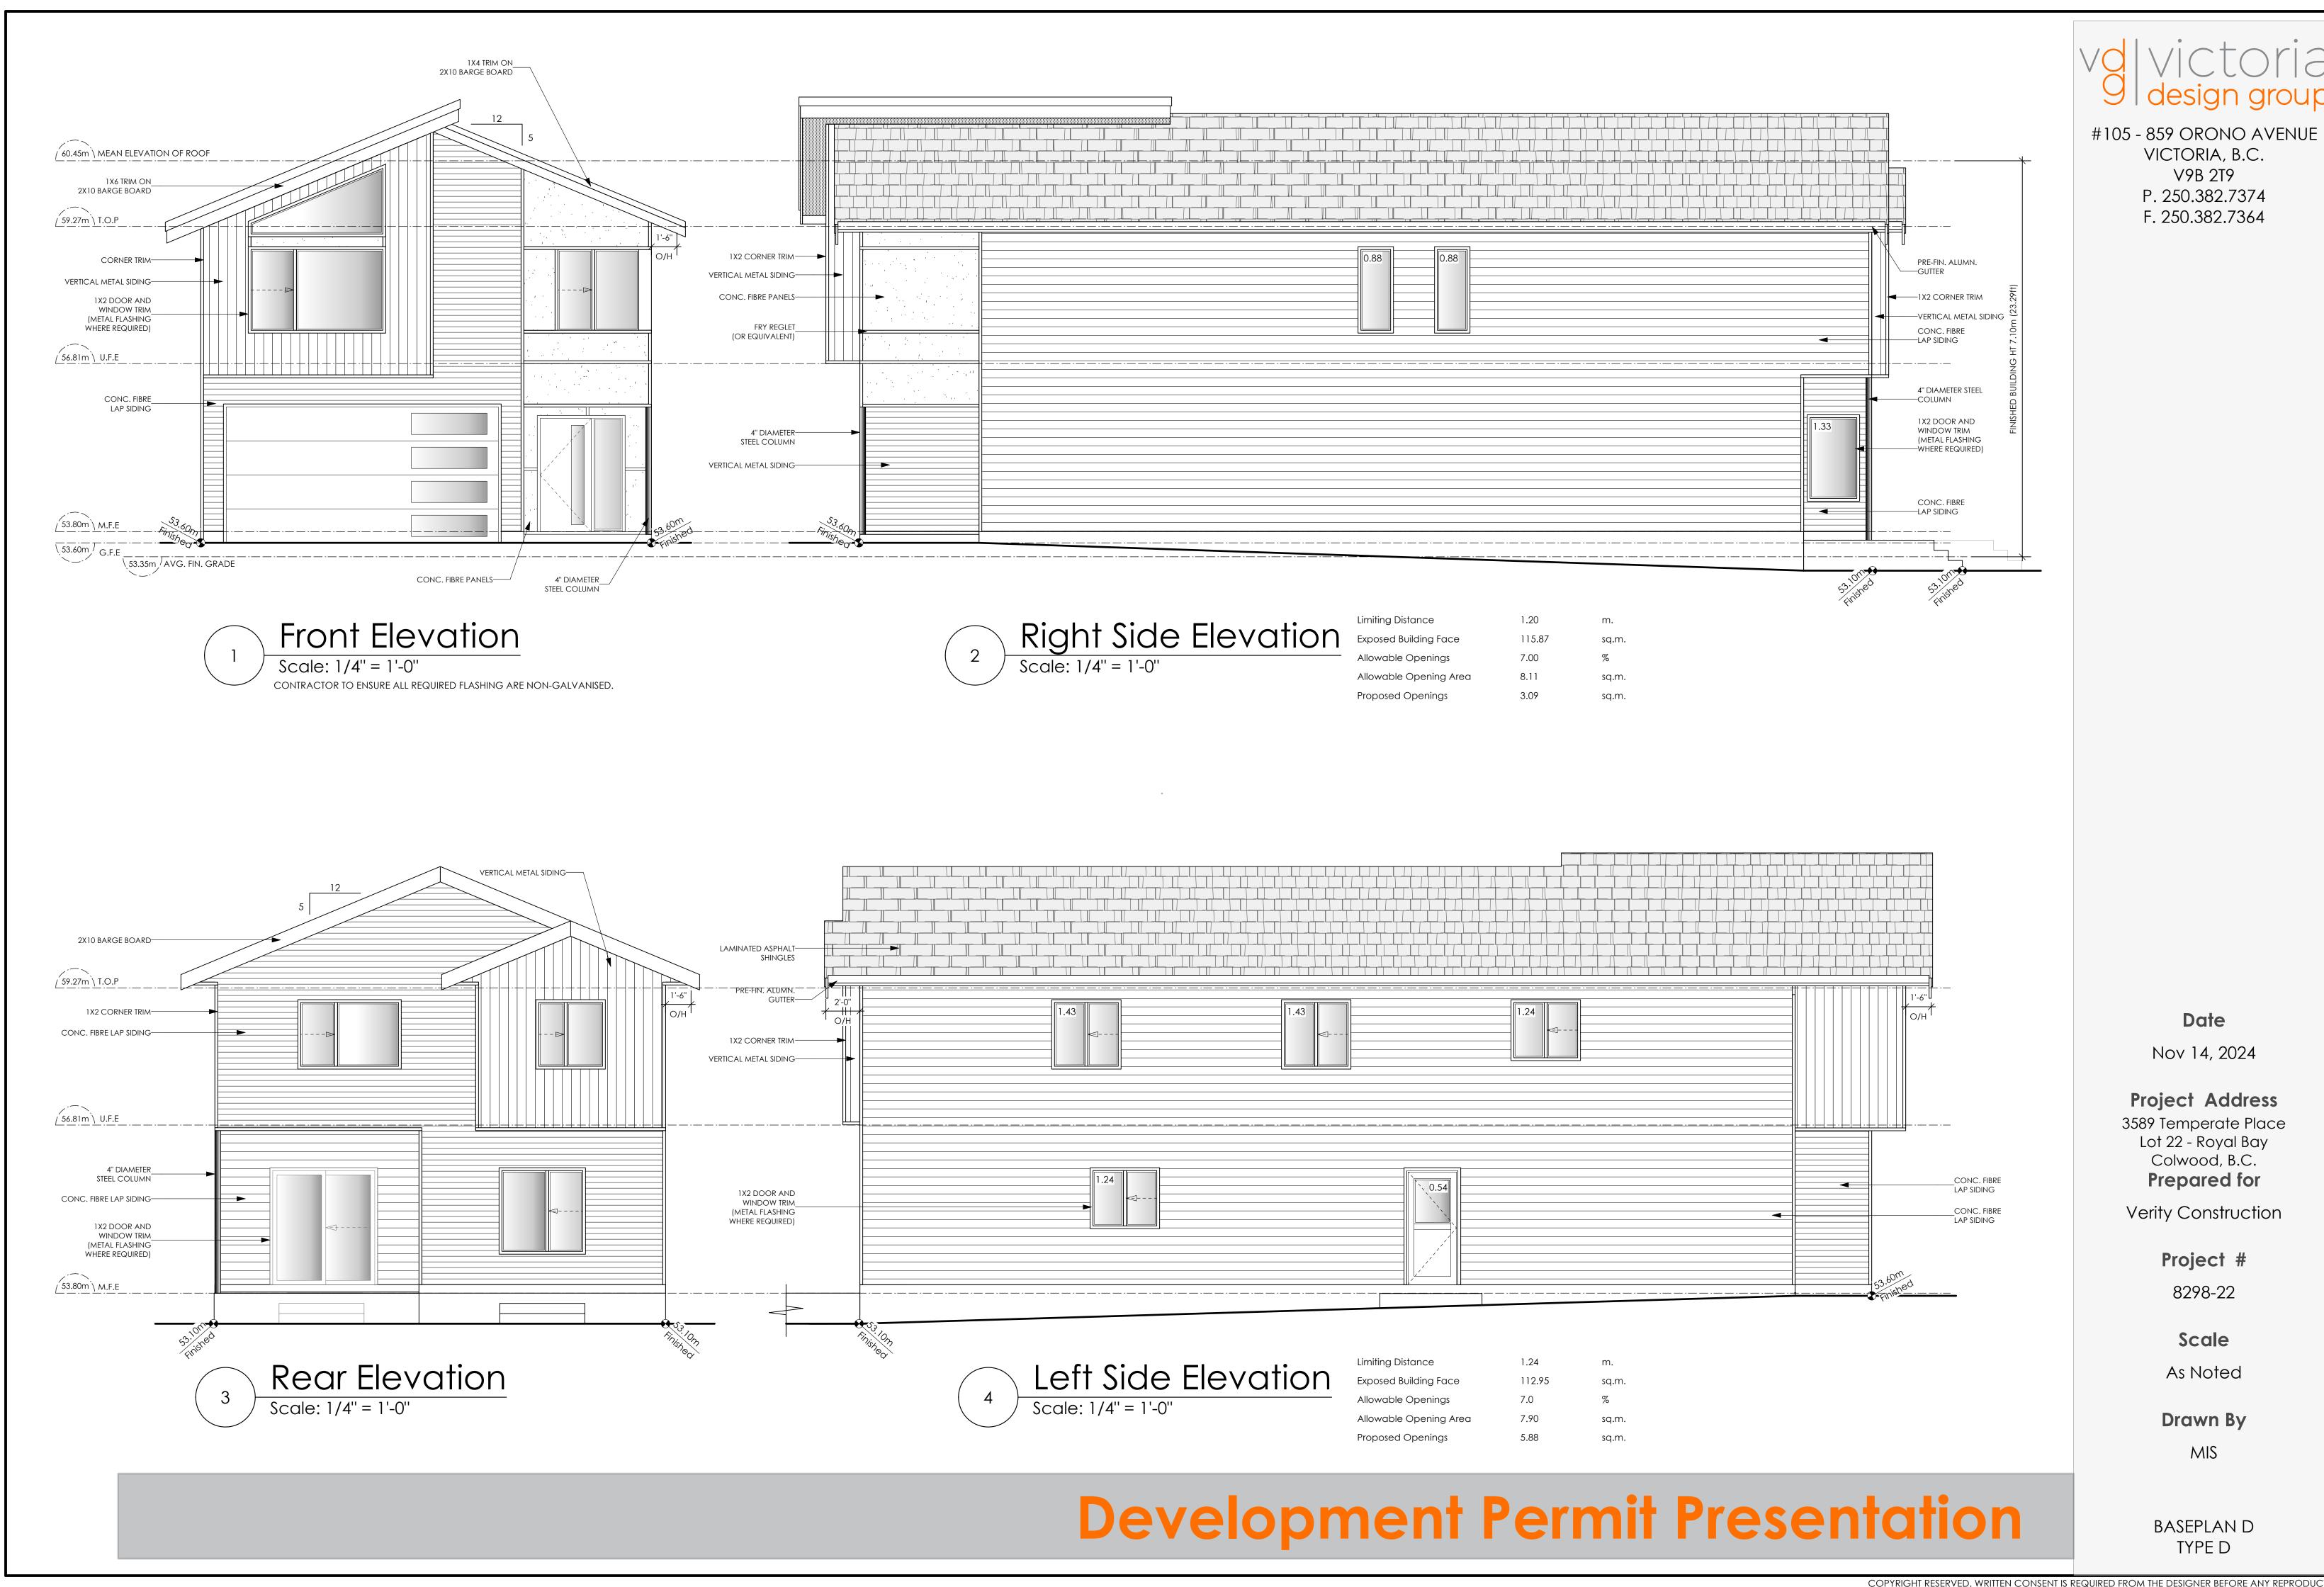

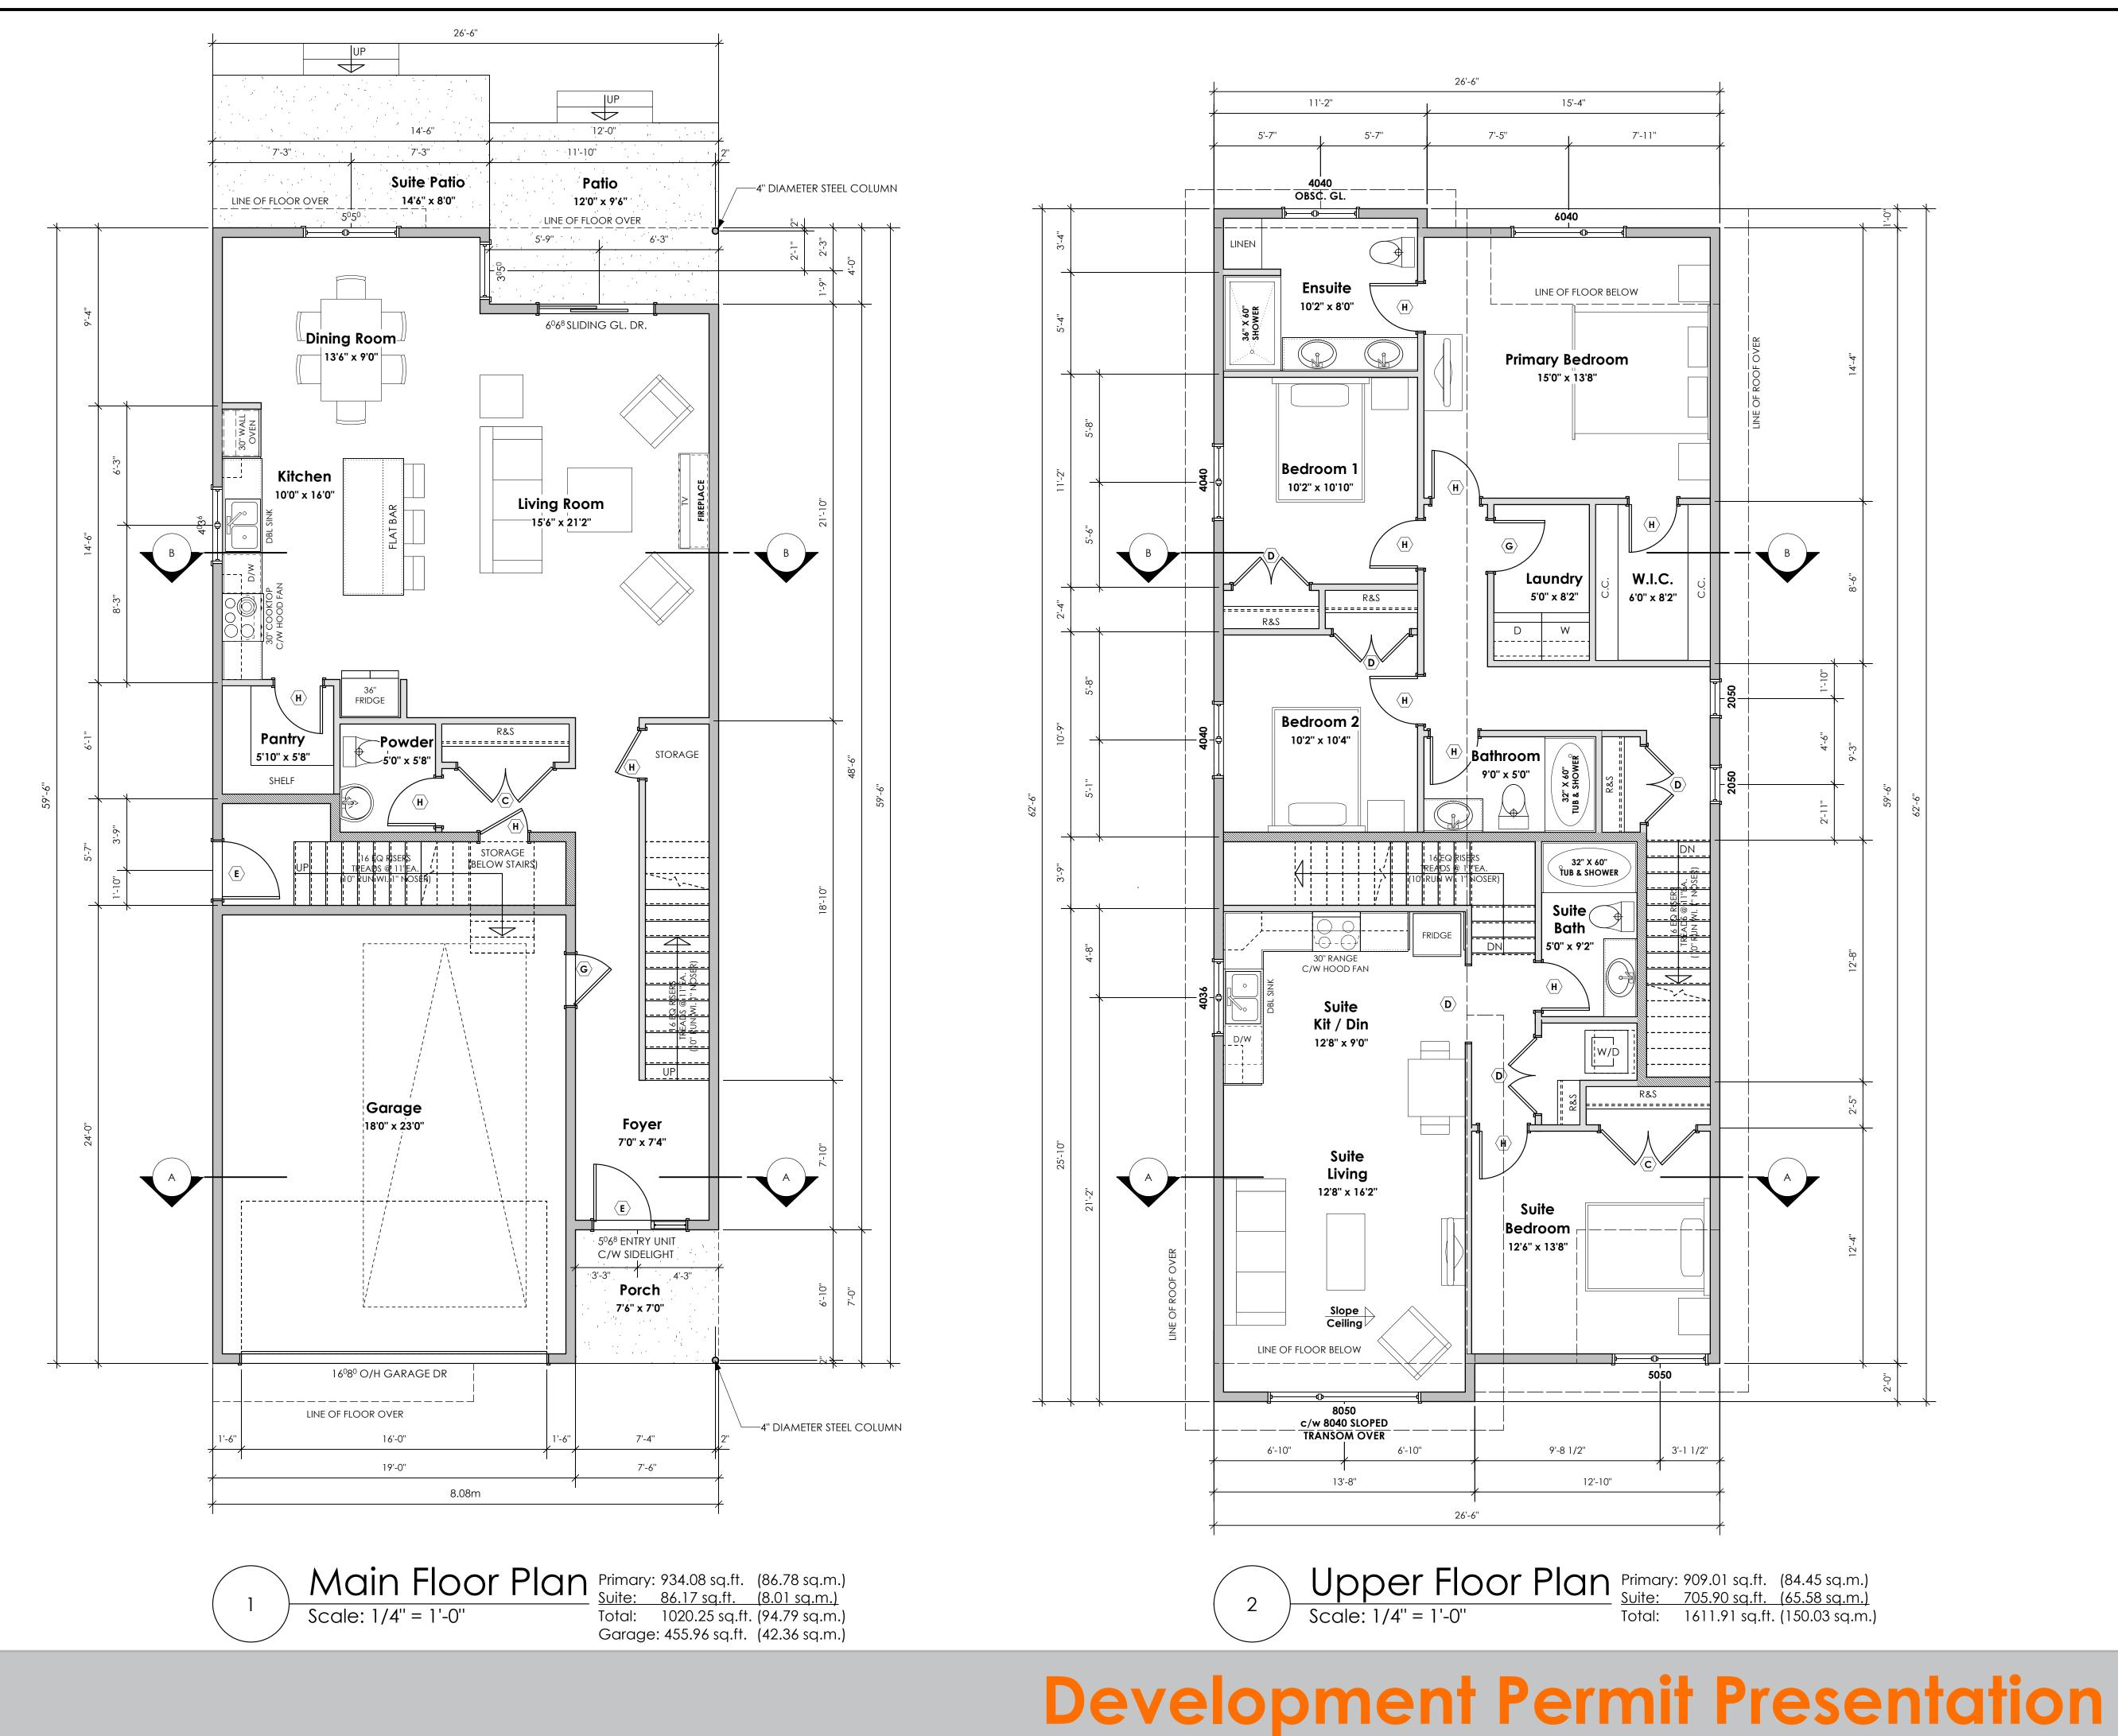

Date

Nov 14, 2024

**Project Address** 3589 Temperate Place Lot 22 - Royal Bay Colwood, B.C. Prepared for

Verity Construction

Project #


8298-22

Scale

As Noted

Drawn By MIS

BASEPLAN D TYPE D

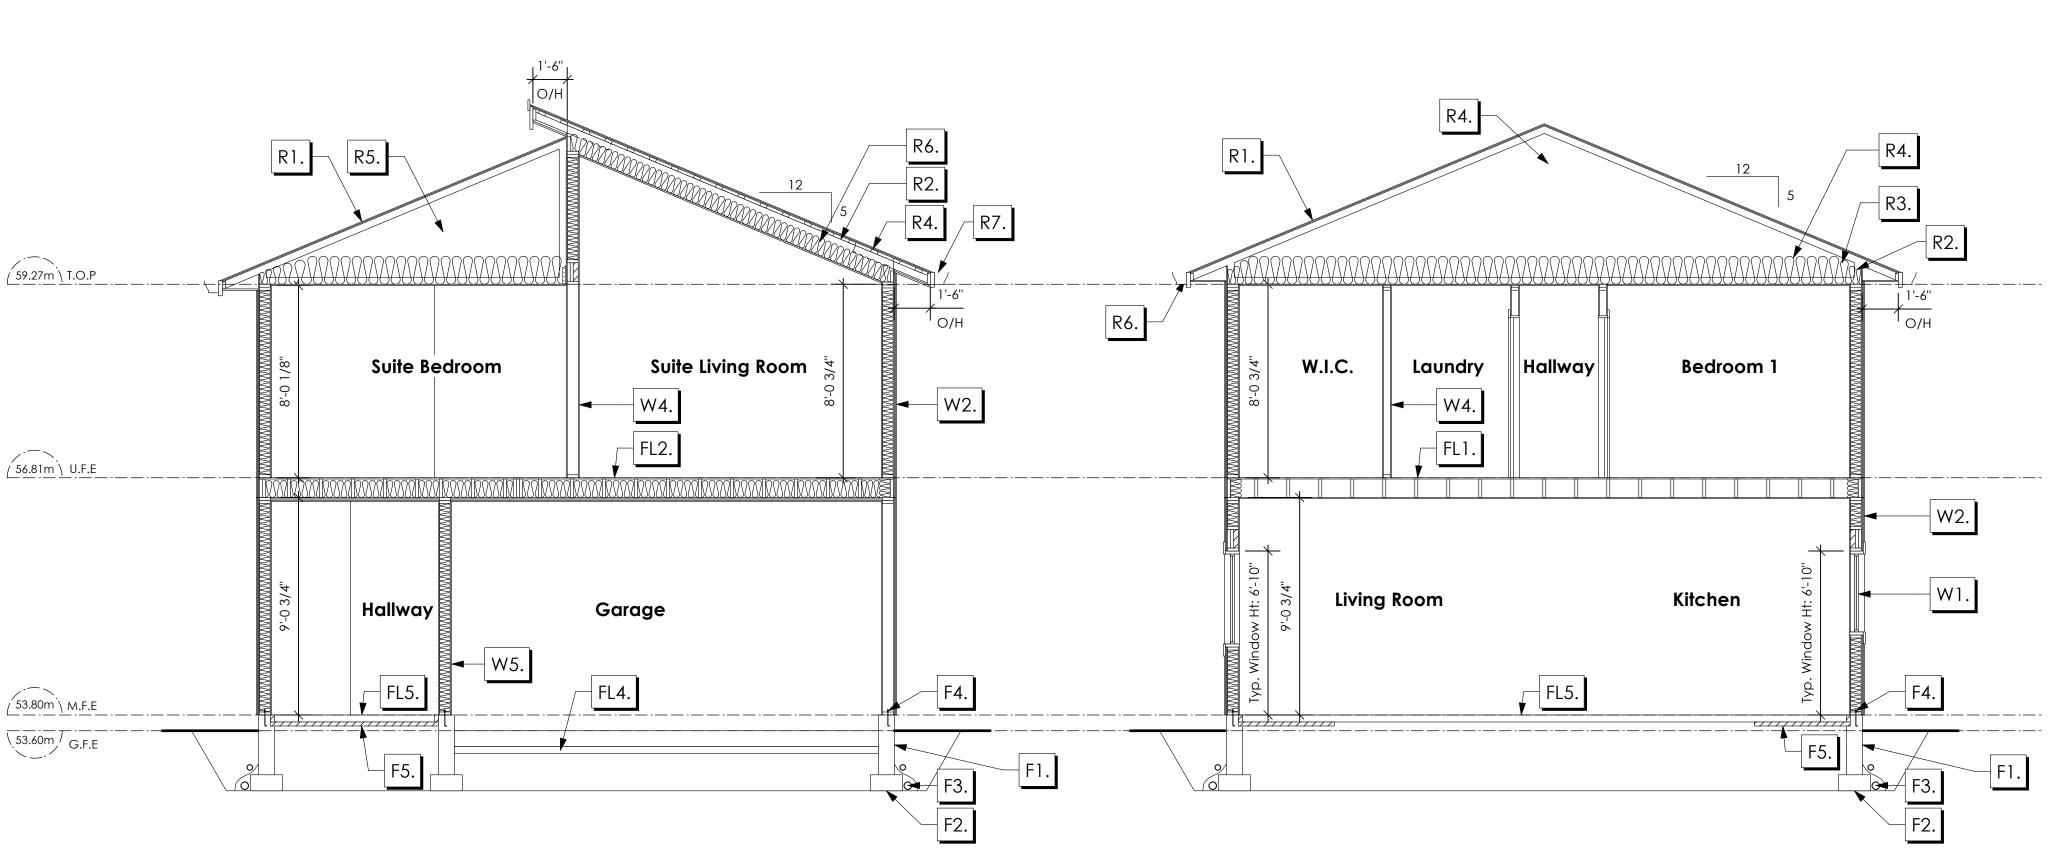

Cross Section A-A

Scale: 1/4" = 1'-0"

NOTE:
ALL STRUCTURE TO BE VERIFIED OR DESIGNED BY A STRUCTURAL ENGINEER.
STRUCTURAL ENGINEER TO LOCATE AND DESIGN REQUIRED EXTERIOR
AND INTERIOR WALL BRACING TO RESIST LATERAL LOADS IN COMPLIANCE
WITH B.C. BUILDING CODE 9 23 13. AND SUPPLY DETAILS IF REQUIRED.

STRUCTURAL WOOD ELEMENTS WITHIN 150MM (6") FROM FINISHED GROUND LEVEL SHALL BE PRESSURE TREATED WITH A PRESERVATIVE FOR TERMITE AND DECAY PROTECTION B.C.B.C. 9.3.2.9.(3)

# 2 Scale

Cross Section B-B
Scale: 1/4" = 1'-0"

### ROOFS

- R1. LAMINATED ASPHALT SHINGLES ON
  7/16" ORIENTED STRAND BOARD C/W "H" CLIPS
  WD TRUSSES (DESIGNED BY MANUF.)
  R-40 FIBRE GLAS BATT INSULATION OR
  14 1/2" FIBRE GLASS LOOSE FILL INSULATION
  6 MIL POLY'N V.B.
  5/8" GYPSUM BOARD OR
  5/8" X-TYPE GYPSUM BOARD
  45 MINUTE RATED F.R.R.
  (OVER SECONDARY SUITE)
- R2. PROVIDE 2 1/2" (63MM) CLEAR BETWEEN R-20 INSULATION AND SHEATHING.
  (MIN. R-20 @ ROOF-WALL CONNECTION FOR 4'-0" (1.2M) AROUND PERIMETER OF BUILDING. AIR VENTILATION BAFFLES TO BE INSTALLED WHERE REQUIRED IN AS PER BCBC 9.19.)
- R3. EAVE PROTECTION

  CONT. UP ROOF SLOPE FOR 12"

  PAST EXTERIOR WALL.
- R4. PROVIDE 1 SQ.FT. ATTIC VENT PER
  300 SQ.FT. OF INSULATED AREA MIN.
  25% OF REQUIRED TO BE @ TOP AND BOTTOM
  (TO COMPLY WI. B.C. BLDG. CODE 9.19.1)
- R5. PRE-FIN. FASCIA GUTTER
  2×8 FASCIA BD.
  2×4 SUB. FASCIA BD.
  VENTED SOFFIT
  (SEE CONTRACTOR)
  (NOT SHOWN IN SECTION)
- R6. PRE-FIN. FASCIA GUTTER
  2×8 FASCIA BD.
  2×4 SUB. FASCIA BD.
  1/2" ORIENTED STRAND BOARD
  VENTED SOFFIT
  (SEE CONTRACTOR)

### **FLOORS**

- FL1. FINISHED FLOORING ON

  19/32" ORIENTED STRAND BOARD
  (NAILED & GLUED TO FLOOR STRUCT. BELOW) ON
  2×10 FLOOR JOISTS @ 16" OR 12" O/C
  C/W 2×2 X-BRIDGING @ 7.0' O/C (MAX)
  1/2" GYPSUM BOARD
- FL2. B.C. BUILDING CODE (TABLE-9.10.3.1.B)
  RATED FLOOR ASSEMBLY F8D
  FINISHED FLOORING ON
  11/16" ORIENTED STRAND BOARD
  (FASTENED & GLUED TO FLOOR STRUCT. BELOW) ON
  2×10 FLOOR JOISTS @ 16" OR 12" O/C
  C/W 2×2 X-BRIDGING @ 7.0' O/C (MAX)
  R-31 INSULATION
  RESILIENT METAL CHANNELS @ 24" O/C
  1 LAYERS 5/8" X-TYPE GYPSUM BOARD
  30 MINUTE F.R.R., 50 S.T.C.
- FL3. FINISHED FLOORING ON

  11/16" ORIENTED STRAND BOARD

  (FASTENED & GLUED TO FLOOR STRUCT. BELOW) ON

  2×10 FLOOR JOISTS @ 16" OR 12" O/C

  C/W 2×2 X-BRIDGING @ 7.0' O/C (MAX)

  PROVIDE R-31 F/G BATT INSULATION IN

  JOIST CAVITY C/W

  BUILDING WRAP

  VENTED SOFFIT (TO OWNERS SPEC'S)

  TO ALL SUSPENDED FLOOR AREAS

  (NOT SHOWN IN SECTION)
- FL4. 3 1/2" CONCRETE SLAB
  6 MIL. POLY'N V.B.
  6" COMPACTED GRAVEL OR SAND
  SLOPE TO DOORS 1"
- FL5. 3 1/2" CONCRETE SLAB
  6 MIL. POLY'N V.B.
  6" COMPACTED GRAVEL OR SAND
- FL6. 3 1/2" CONCRETE SLAB 6" COMPACTED GRAVEL OR SAND SLOPE MIN. 2% AWAY FROM BUILDING

### WALLS

- W1. DOUBLE GLAZING
  ENERGY STAR LOW "E" RATING IN
  THERMAL BREAK FRAMES
  2/2"X10" LINTEL OVER (@ bearing walls only)
  (TYPICAL, wi. 2 1/2" XPS insulation)
  FLASHING OVER @ EXTERIOR
  (glazing in all exterior doors & within 3 ft.
  of exterior doors to be shatterproof (SP))
- W2. CONC. FIBRE BOARD ON
  9.5MM (3/8") AIR SPACE / STRAPPING
  3/8"×2" BORATE TREATED PLYWOOD STRAPPING
  HOUSE WRAP (A.B.) (TYVEK OR EQ.)
  7/16" ORIENTED STRAND BOARD SHEATHING
  2×6 STUDS @ 16" O/C
  R-20 INSULATION
  6 MIL. POLYETHYLENE VAPOUR BARRIER
  1/2" GYPSUM BOARD
- W3. B.C. BUILDING CODE (TABLE 9.10.3.1.A)
  RATED WALL ASSEMBLY W3C
  1 LAYER 1/2" X-TYPE GYPSUM BOARD
  RESILIENT METAL CHANNELS @ 24" O/C
  2×4 STUDS @ 16" O/C OR
  2×6 STUDS @ 16" O/C (IF NOTED) C/W
  3 1/2" FIBRE GLASS SOUND BATTS
  1 LAYER 1/2" X-TYPE GYPSUM BOARD
  45 MIN. F.R.R 43 S.T.C
  (BETWEEN PRIMARY LIVING & SECONDARY SUITE)
  (NOT SHOWN IN SECTION)
- W4. INTERIOR PARTITION
  1/2" GYPSUM BOARD ON EACH SIDE
  OF 2×4 STUDS @ 16" O/C OR
  2×6 STUDS @ 16" O/C (IF NOTED)
- W5. 5/8" X-TYPE GYPSUM BOARD ON 2×6 STUDS @ 16" O/C C/W R-20 INSULATION 6 MIL. POLY'N V.B 1/2" GYPSUM BOARD (BETWEEN GARAGE & LIVING)

### FOUNDATION

- F1. DAMP PROOFING (WHERE REQUIRED) ON 8" THK. CONC. FOUNDATION WALL C/W 15 M BARS @ 24" O/C B/W
- F2. 16"X 8" CONC. FOOTINGS

  C/W 2 (TWO) 15M BARS CONT. 3 IN. FROM BOTT.

  ON UNDISTURBED SOIL (SOLID BEARING)
- F3. 4" PERIMETER DRAIN
  3" TIGHT PIPE FOR RWL
  DRAIN ROCK
- F4. ANCHOR BOLTS @ 4.0 FT. O/C MAX C/W SILL GASKETS
- F5. UNDER SLAB INSULATION
  2 1/2" (RSI 2.15) EXTRUDED POLYSTYRENE
  RIGID INSULATION 4'-0" (1.2M)
  CONT. AROUND PERIMETER UNDER
  SLAB INSTALLED HORIZONTALLY
  (VERIFY WITH MUNICIPALITY DEPTH OF FROST LINE)



#105 - 859 ORONO AVENUE VICTORIA, B.C. V9B 2T9 P. 250.382.7374 F. 250.382.7364

Date

Nov 14, 2024

Project Address
3589 Temperate Place
Lot 22 - Royal Bay
Colwood, B.C.
Prepared for

Verity Construction

Project #

8298-22


Scale

As Noted

Drawn By

MIS

BASEPLAN D TYPE D

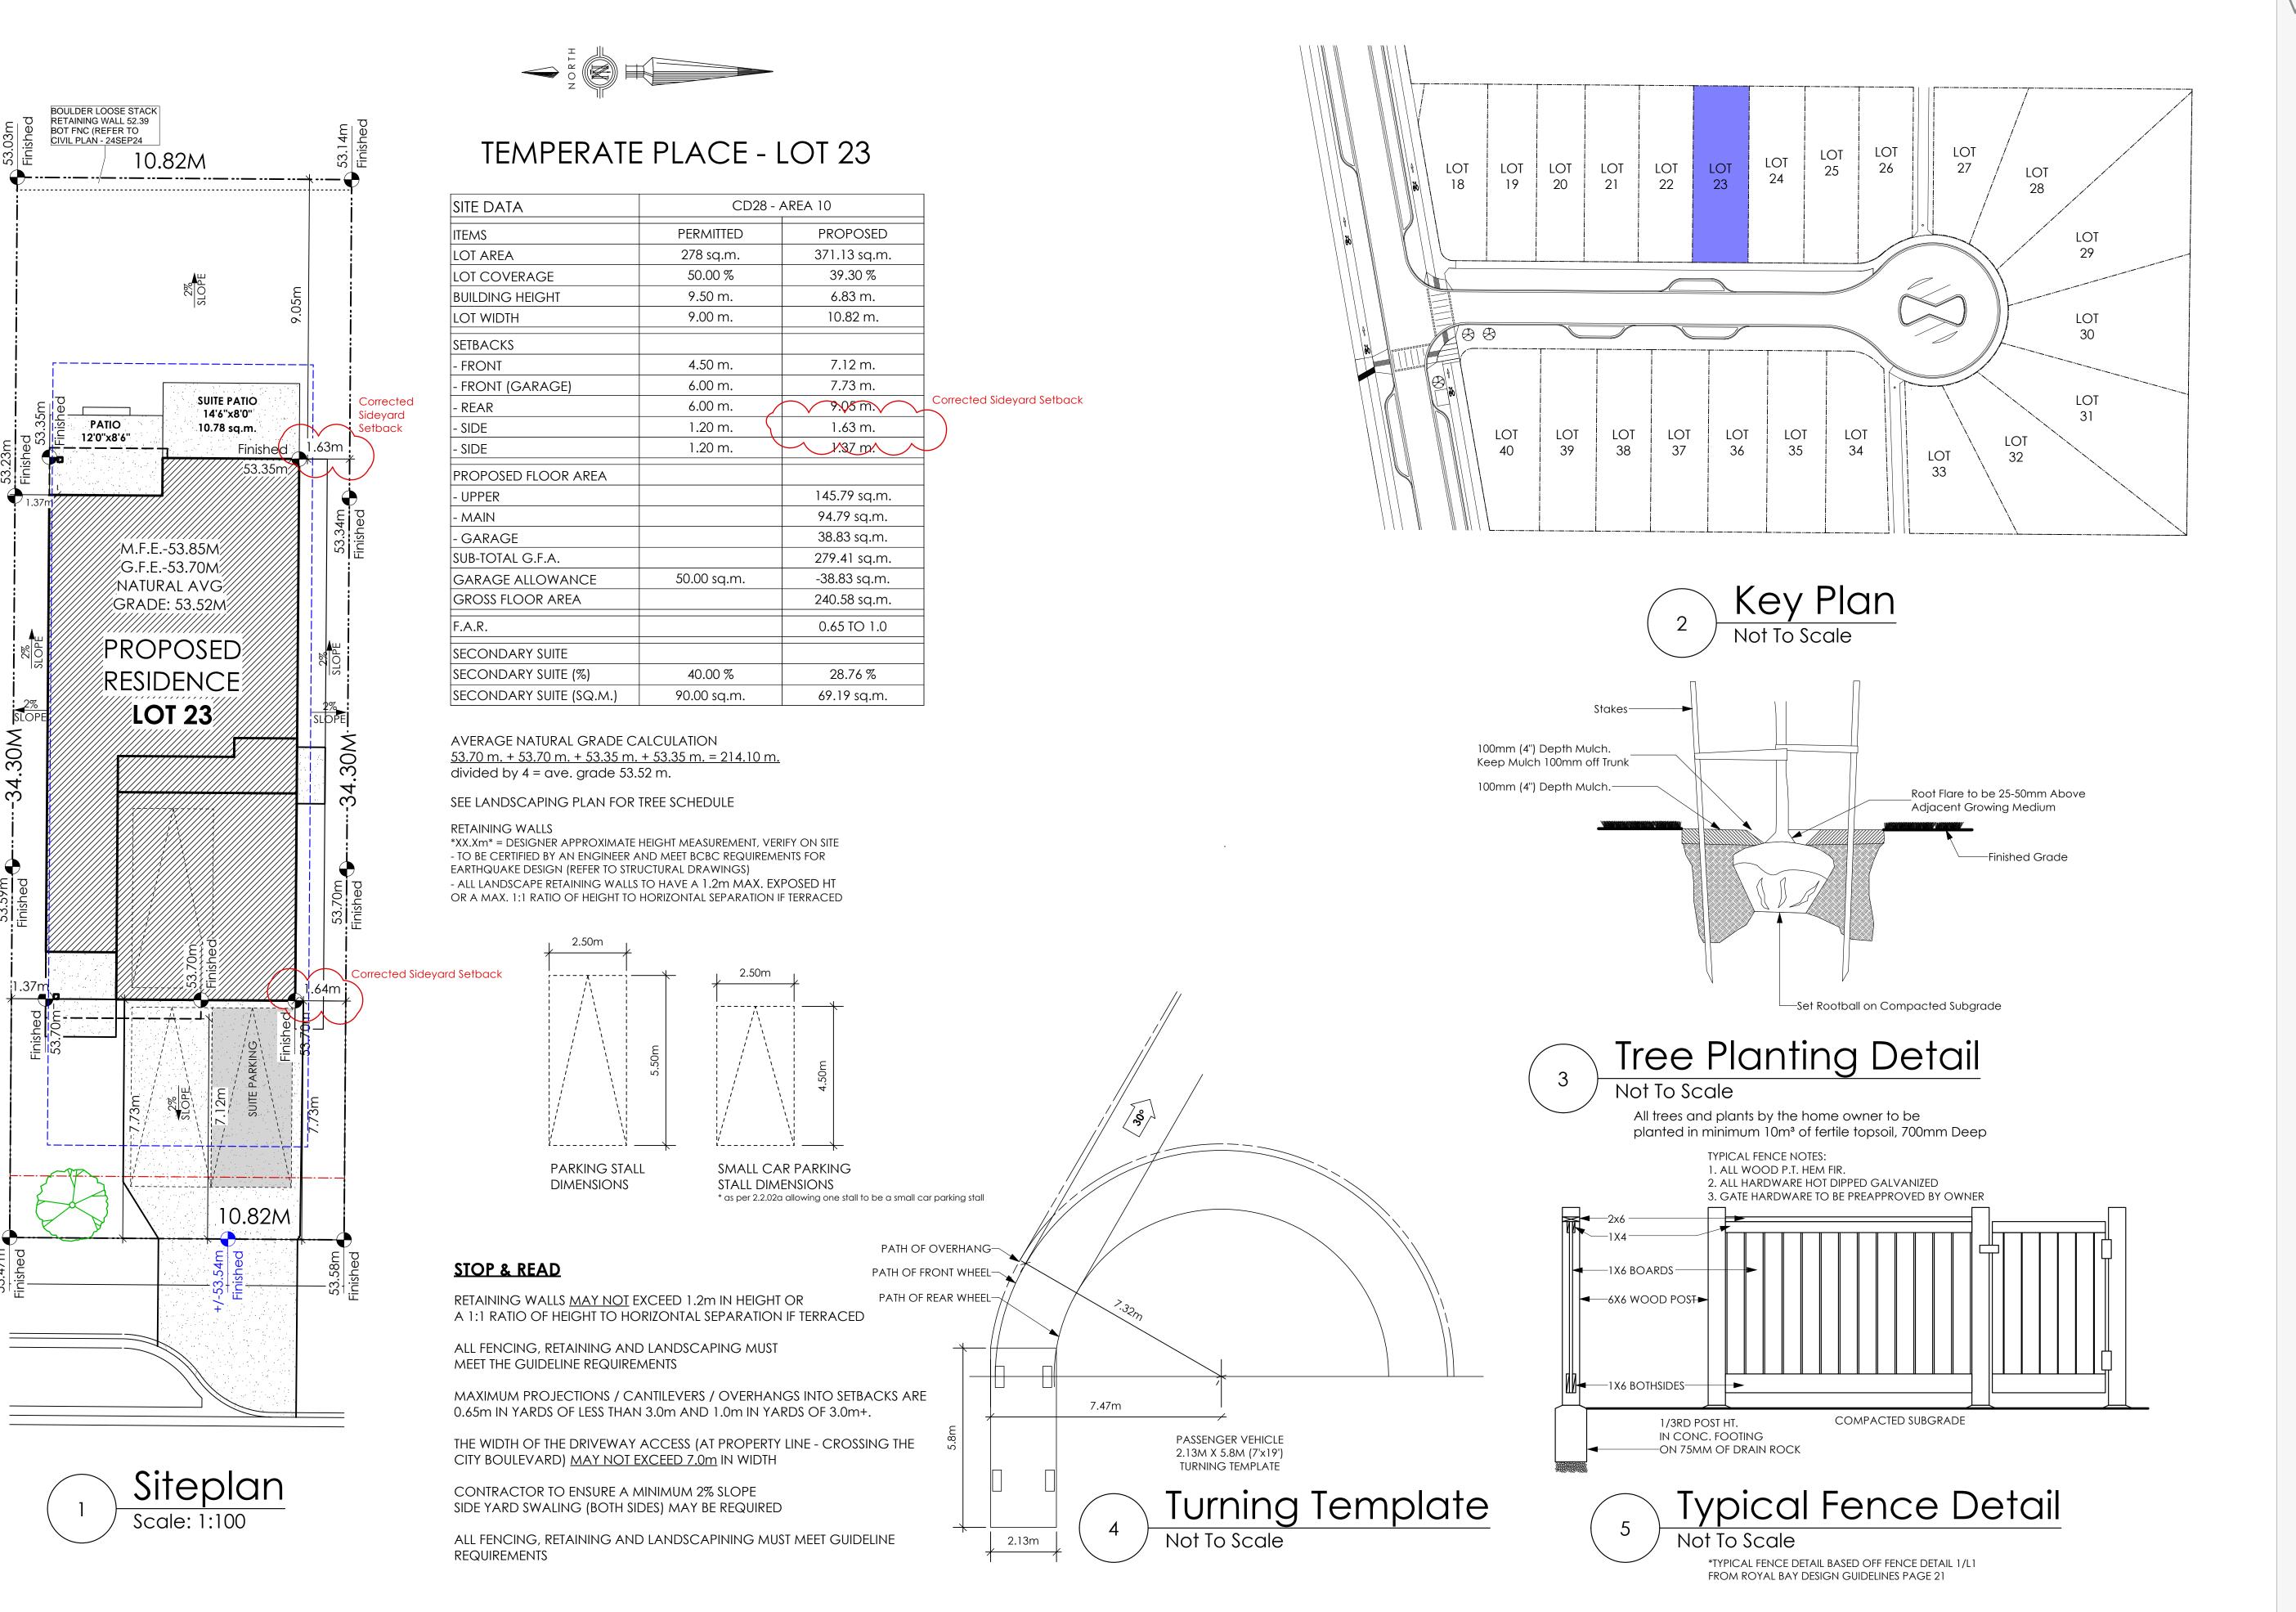

volvictoria 9 design group

#105 - 859 ORONO AVENUE VICTORIA, B.C. V9B 2T9 P. 250.382.7374 F. 250.382.7364

Date

Nov 14, 2024

Project Address
3591 Temperate Place
Lot 23 - Royal Bay
Colwood, B.C.
Prepared for

Verity Construction

Project #

8298-23


Scale


As Noted

Drawn By

NS


BASEPLAN D TYPE C

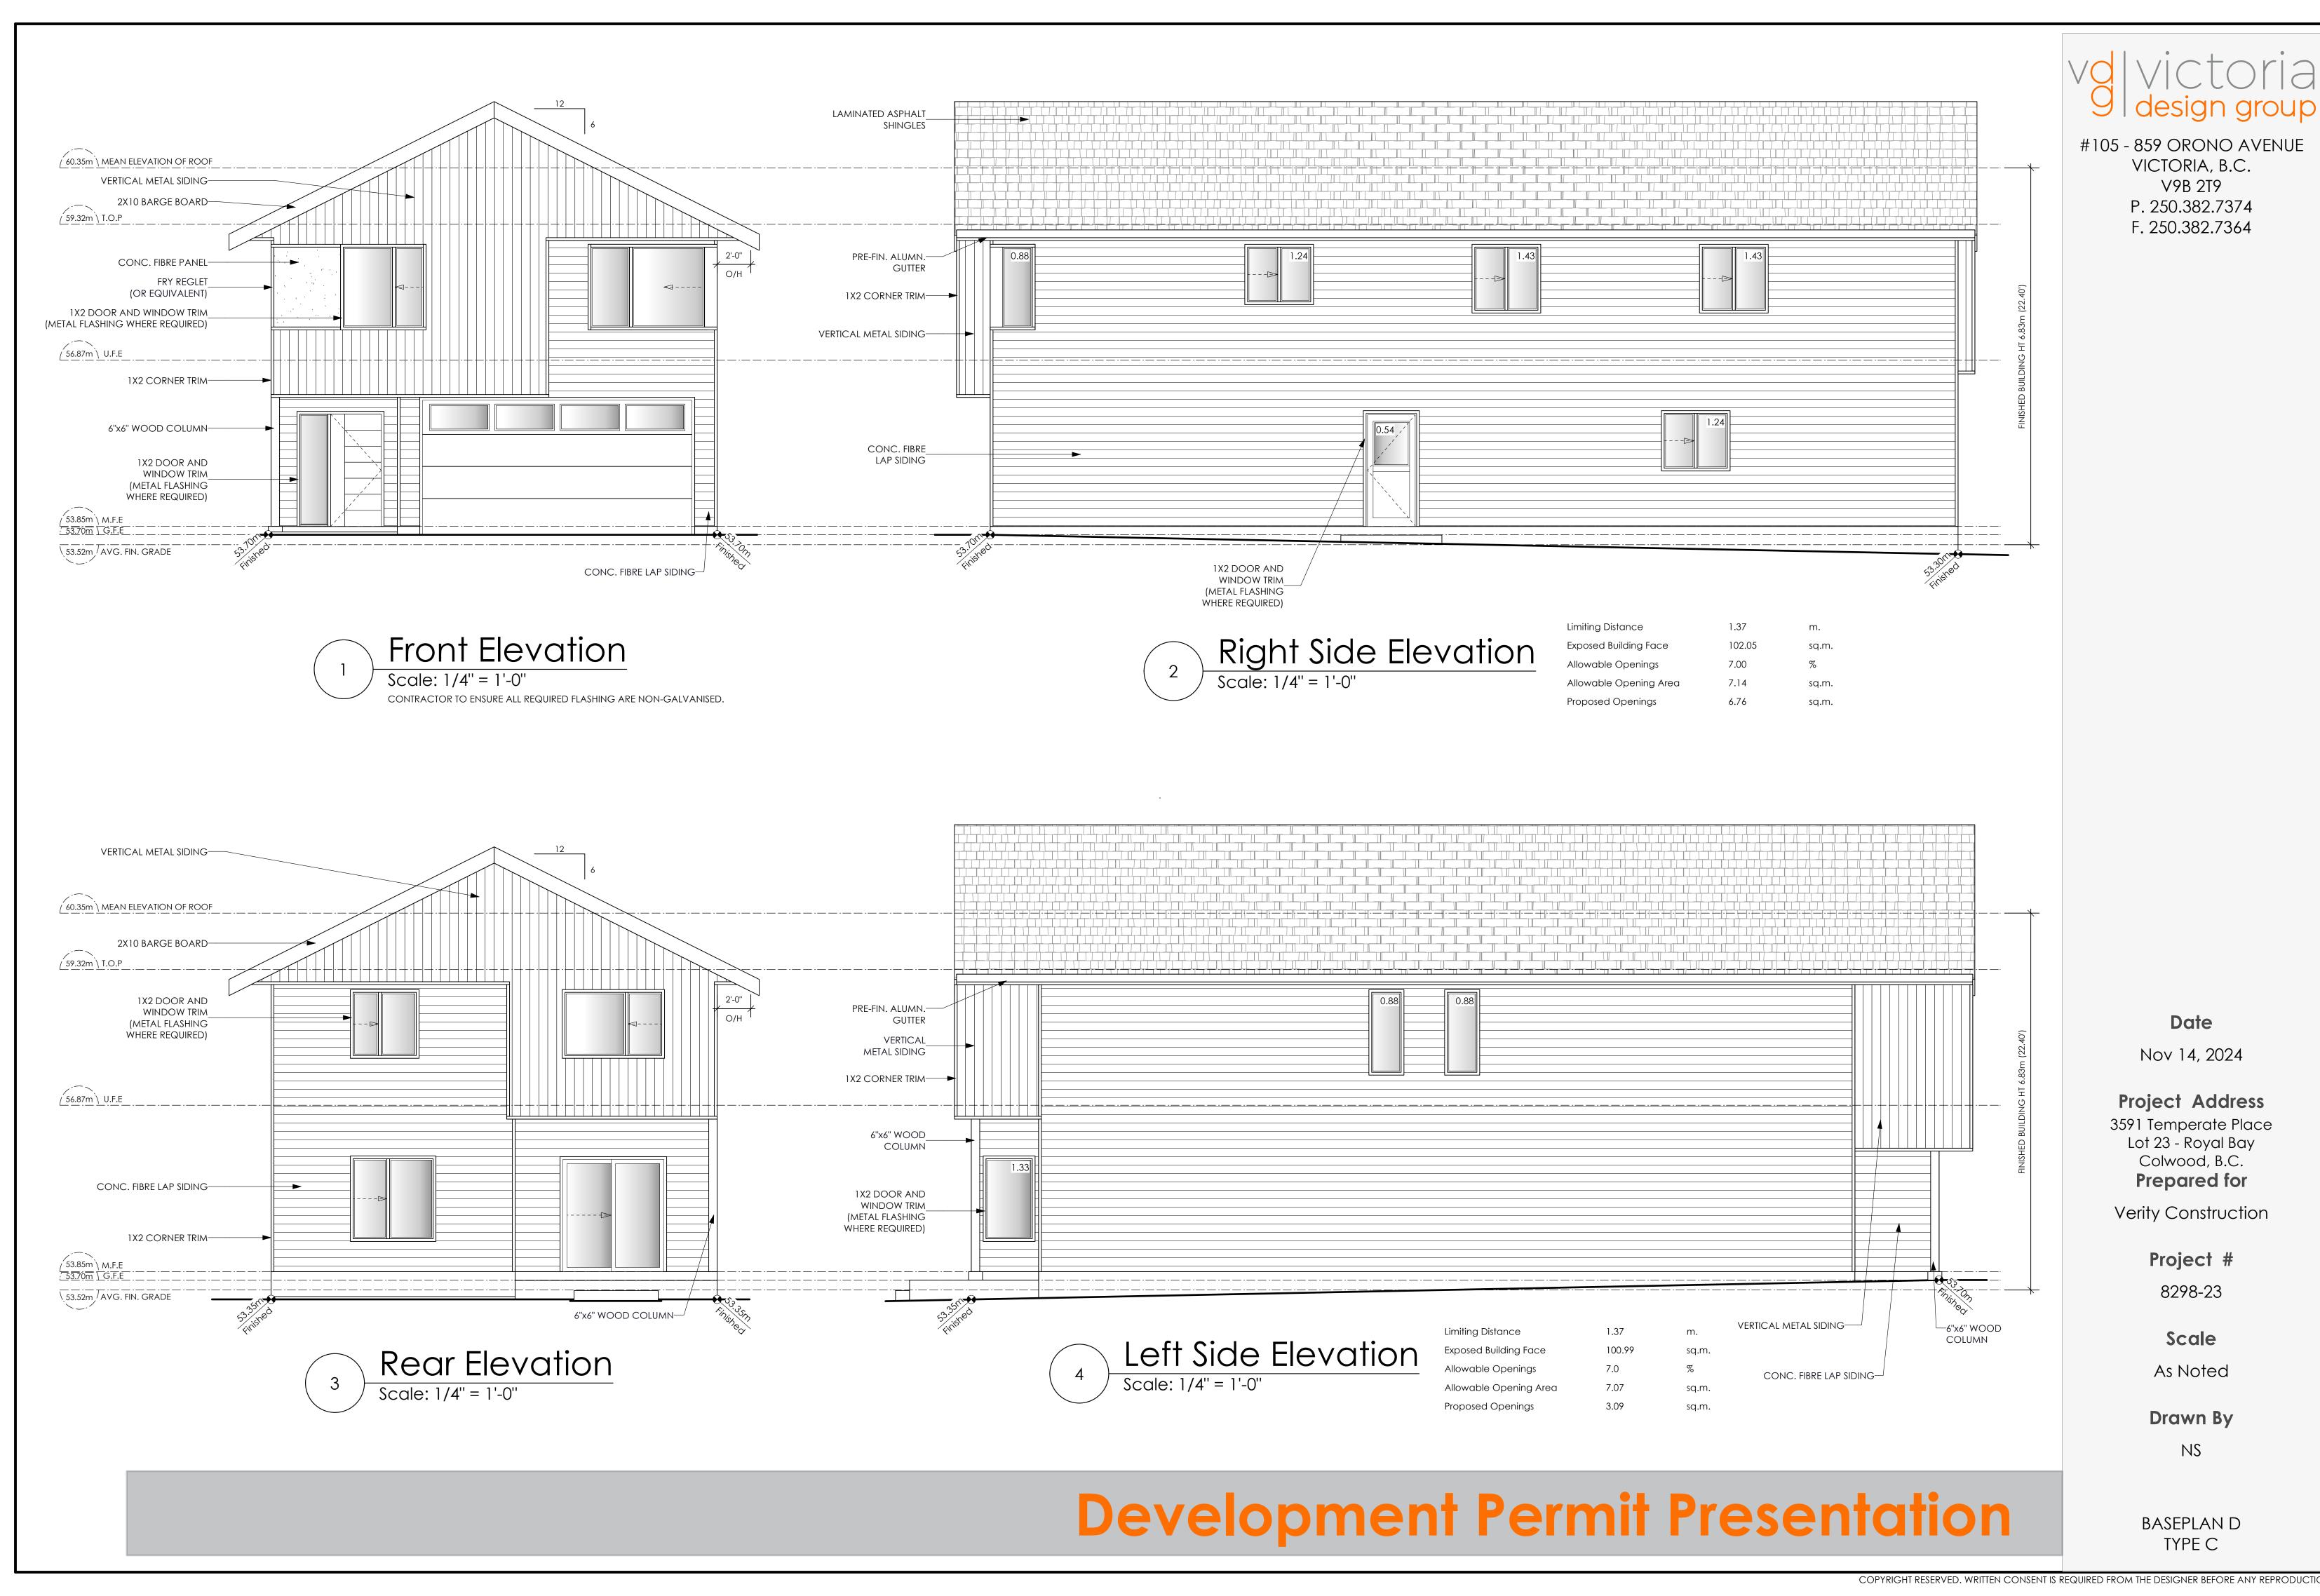

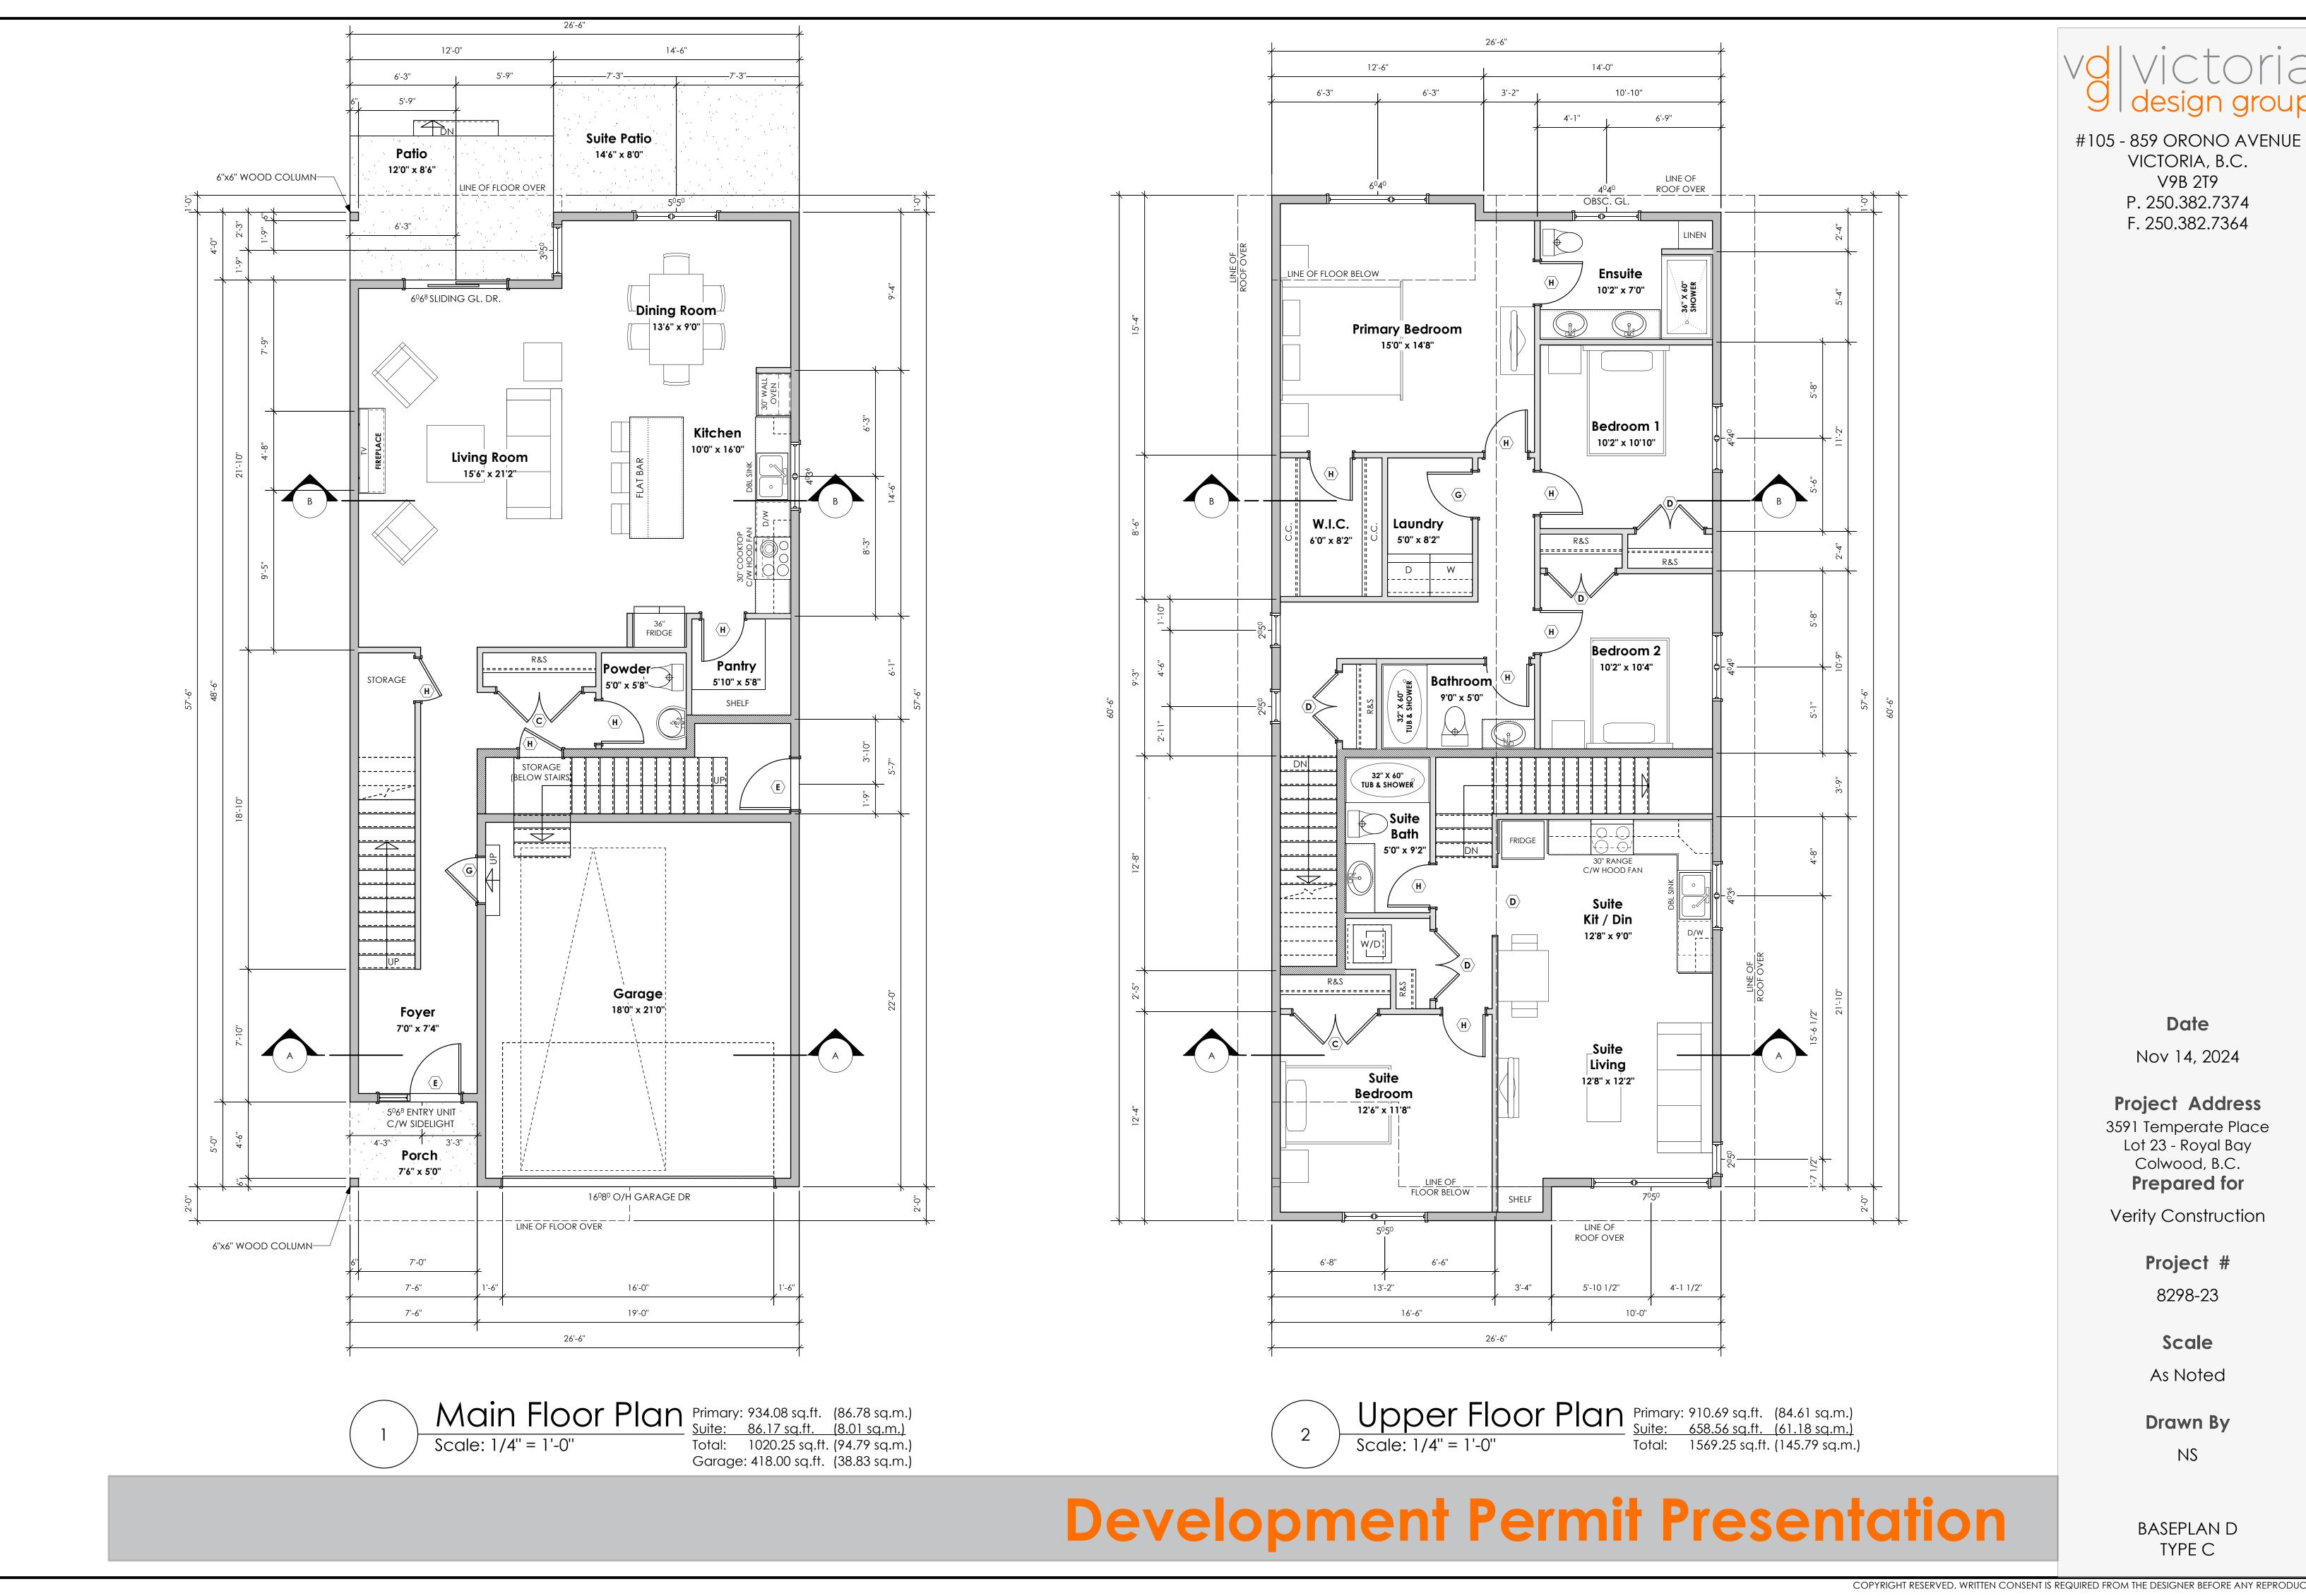





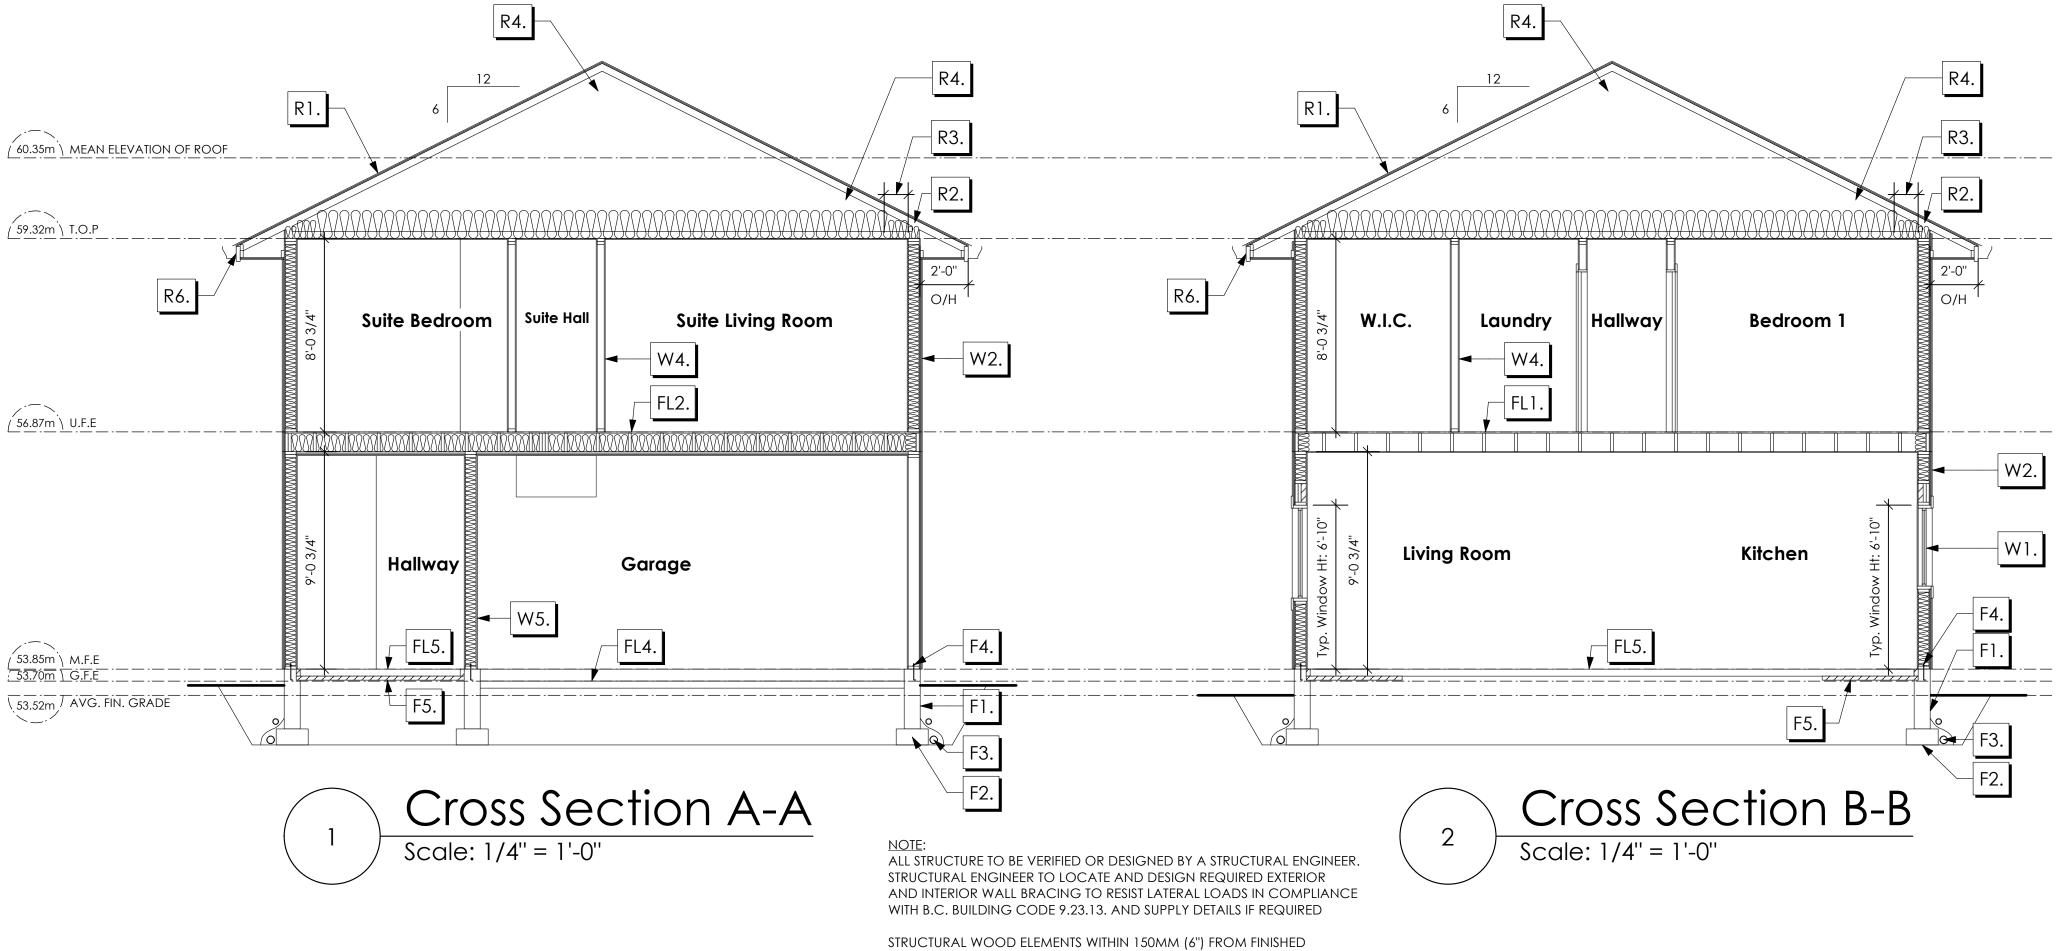

GROUND LEVEL SHALL BE PRESSURE TREATED WITH A PRESERVATOR FOR TERMITE AND DECAY PROTECTION B.C.B.C. 9.3.2.9.(3)

### ROOFS

- R1. LAMINATED ASPHALT SHINGLES ON
  7/16" ORIENTED STRAND BOARD C/W "H" CLIPS
  WD TRUSSES (DESIGNED BY MANUF.)
  R-40 FIBRE GLAS BATT INSULATION OR
  14 1/2" FIBRE GLASS LOOSE FILL INSULATION
  6 MIL POLY'N V.B.
  5/8" GYPSUM BOARD OR
  5/8" X-TYPE GYPSUM BOARD
  45 MINUTE RATED F.R.R.
- R2. PROVIDE 2 1/2" (63MM) CLEAR BETWEEN R-20 INSULATION AND SHEATHING.
  (MIN. R-20 @ ROOF-WALL CONNECTION FOR 4'-0" (1.2M) AROUND PERIMETER OF BUILDING. AIR VENTILATION BAFFLES TO BE INSTALLED WHERE REQUIRED IN AS PER BCBC 9.19.)

(OVER SECONDARY SUITE)

- R3. EAVE PROTECTION

  CONT. UP ROOF SLOPE FOR 12"

  PAST EXTERIOR WALL.
- R4. PROVIDE 1 SQ.FT. ATTIC VENT PER
  300 SQ.FT. OF INSULATED AREA MIN.
  25% OF REQUIRED TO BE @ TOP AND BOTTOM
  (TO COMPLY WI. B.C. BLDG. CODE 9.19.1)
- R5. PRE-FIN. FASCIA GUTTER

  2×8 FASCIA BD.

  2×4 SUB. FASCIA BD.

  VENTED SOFFIT

  (SEE CONTRACTOR)

  (NOT SHOWN IN SECTION)
- R6. PRE-FIN. FASCIA GUTTER
  2×8 FASCIA BD.
  2×4 SUB. FASCIA BD.
  1/2" ORIENTED STRAND BOARD
  VENTED SOFFIT
  (SEE CONTRACTOR)

### **FLOORS**

- FL1. FINISHED FLOORING ON
  19/32" ORIENTED STRAND BOARD
  (NAILED & GLUED TO FLOOR STRUCT. BELOW) ON
  2×10 FLOOR JOISTS @ 16" OR 12" O/C
  C/W 2×2 X-BRIDGING @ 7.0' O/C (MAX)
  1/2" GYPSUM BOARD
- FL2. B.C. BUILDING CODE (TABLE-9.10.3.1.B)
  RATED FLOOR ASSEMBLY F8D
  FINISHED FLOORING ON
  11/16" ORIENTED STRAND BOARD
  (FASTENED & GLUED TO FLOOR STRUCT. BELOW) ON
  2×10 FLOOR JOISTS @ 16" OR 12" O/C
  C/W 2×2 X-BRIDGING @ 7.0' O/C (MAX)
  R-31 INSULATION
  RESILIENT METAL CHANNELS @ 24" O/C
  1 LAYERS 5/8" X-TYPE GYPSUM BOARD
  30 MINUTE F.R.R., 50 S.T.C.
- FL3. FINISHED FLOORING ON

  11/16" ORIENTED STRAND BOARD

  (FASTENED & GLUED TO FLOOR STRUCT. BELOW) ON

  2×10 FLOOR JOISTS @ 16" OR 12" O/C

  C/W 2×2 X-BRIDGING @ 7.0' O/C (MAX)

  PROVIDE R-31 F/G BATT INSULATION IN

  JOIST CAVITY C/W

  BUILDING WRAP

  VENTED SOFFIT (TO OWNERS SPEC'S)

  TO ALL SUSPENDED FLOOR AREAS

  (NOT SHOWN IN SECTION)
- FL4. 3 1/2" CONCRETE SLAB
  6 MIL. POLY'N V.B.
  6" COMPACTED GRAVEL OR SAND
  SLOPE TO DOORS 1"
- FL5. 3 1/2" CONCRETE SLAB
  6 MIL. POLY'N V.B.
  6" COMPACTED GRAVEL OR SAND
- FL6. 3 1/2" CONCRETE SLAB 6" COMPACTED GRAVEL OR SAND SLOPE MIN. 2% AWAY FROM BUILDING

### WALLS

- W1. DOUBLE GLAZING
  ENERGY STAR LOW "E" RATING IN
  THERMAL BREAK FRAMES
  2/2"X10" LINTEL OVER (@ bearing walls only)
  (TYPICAL, wi. 2 1/2" XPS insulation)
  FLASHING OVER @ EXTERIOR
  (glazing in all exterior doors & within 3 ft.
  of exterior doors to be shatterproof (SP))
- W2. CONC. FIBRE BOARD ON
  9.5MM (3/8") AIR SPACE / STRAPPING
  3/8"×2" BORATE TREATED PLYWOOD STRAPPING
  HOUSE WRAP (A.B.) (TYVEK OR EQ.)
  7/16" ORIENTED STRAND BOARD SHEATHING
  2×6 STUDS @ 16" O/C
  R-20 INSULATION
  6 MIL. POLYETHYLENE VAPOUR BARRIER
  1/2" GYPSUM BOARD
- W3. B.C. BUILDING CODE (TABLE 9.10.3.1.A)
  RATED WALL ASSEMBLY W3C

  1 LAYER 1/2" X-TYPE GYPSUM BOARD
  RESILIENT METAL CHANNELS @ 24" O/C
  2×4 STUDS @ 16" O/C OR
  2×6 STUDS @ 16" O/C (IF NOTED) C/W
  3 1/2" FIBRE GLASS SOUND BATTS
  1 LAYER 1/2" X-TYPE GYPSUM BOARD
  45 MIN. F.R.R 43 S.T.C
  (BETWEEN PRIMARY LIVING & SECONDARY SUITE)
  (NOT SHOWN IN SECTION)
- W4. INTERIOR PARTITION
  1/2" GYPSUM BOARD ON EACH SIDE
  OF 2×4 STUDS @ 16" O/C OR
  2×6 STUDS @ 16" O/C (IF NOTED)
- W5. 5/8" X-TYPE GYPSUM BOARD ON 2×6 STUDS @ 16" O/C C/W
  R-20 INSULATION
  6 MIL. POLY'N V.B
  1/2" GYPSUM BOARD
  (BETWEEN GARAGE & LIVING)

### **FOUNDATION**

- F1. DAMP PROOFING (WHERE REQUIRED) ON 8" THK. CONC. FOUNDATION WALL C/W 15 M BARS @ 24" O/C B/W
- F2. 16"X 8" CONC. FOOTINGS

  C/W 2 (TWO) 15M BARS CONT. 3 IN. FROM BOTT.

  ON UNDISTURBED SOIL (SOLID BEARING)
- F3. 4" PERIMETER DRAIN
  3" TIGHT PIPE FOR RWL
  DRAIN ROCK
- . ANCHOR BOLTS @ 4.0 FT. O/C MAX C/W SILL GASKETS
- F5. UNDER SLAB INSULATION
  2 1/2" (RSI 2.15) EXTRUDED POLYSTYRENE
  RIGID INSULATION 4'-0" (1.2M)
  CONT. AROUND PERIMETER UNDER
  SLAB INSTALLED HORIZONTALLY
  (VERIFY WITH MUNICIPALITY DEPTH OF FROST LINE)

### Date

Nov 14, 2024

Project Address
3591 Temperate Place
Lot 23 - Royal Bay
Colwood, B.C.
Prepared for

Verity Construction

Project #

8298-23


Scale

As Noted

Drawn By

NS

BASEPLAN D TYPE C

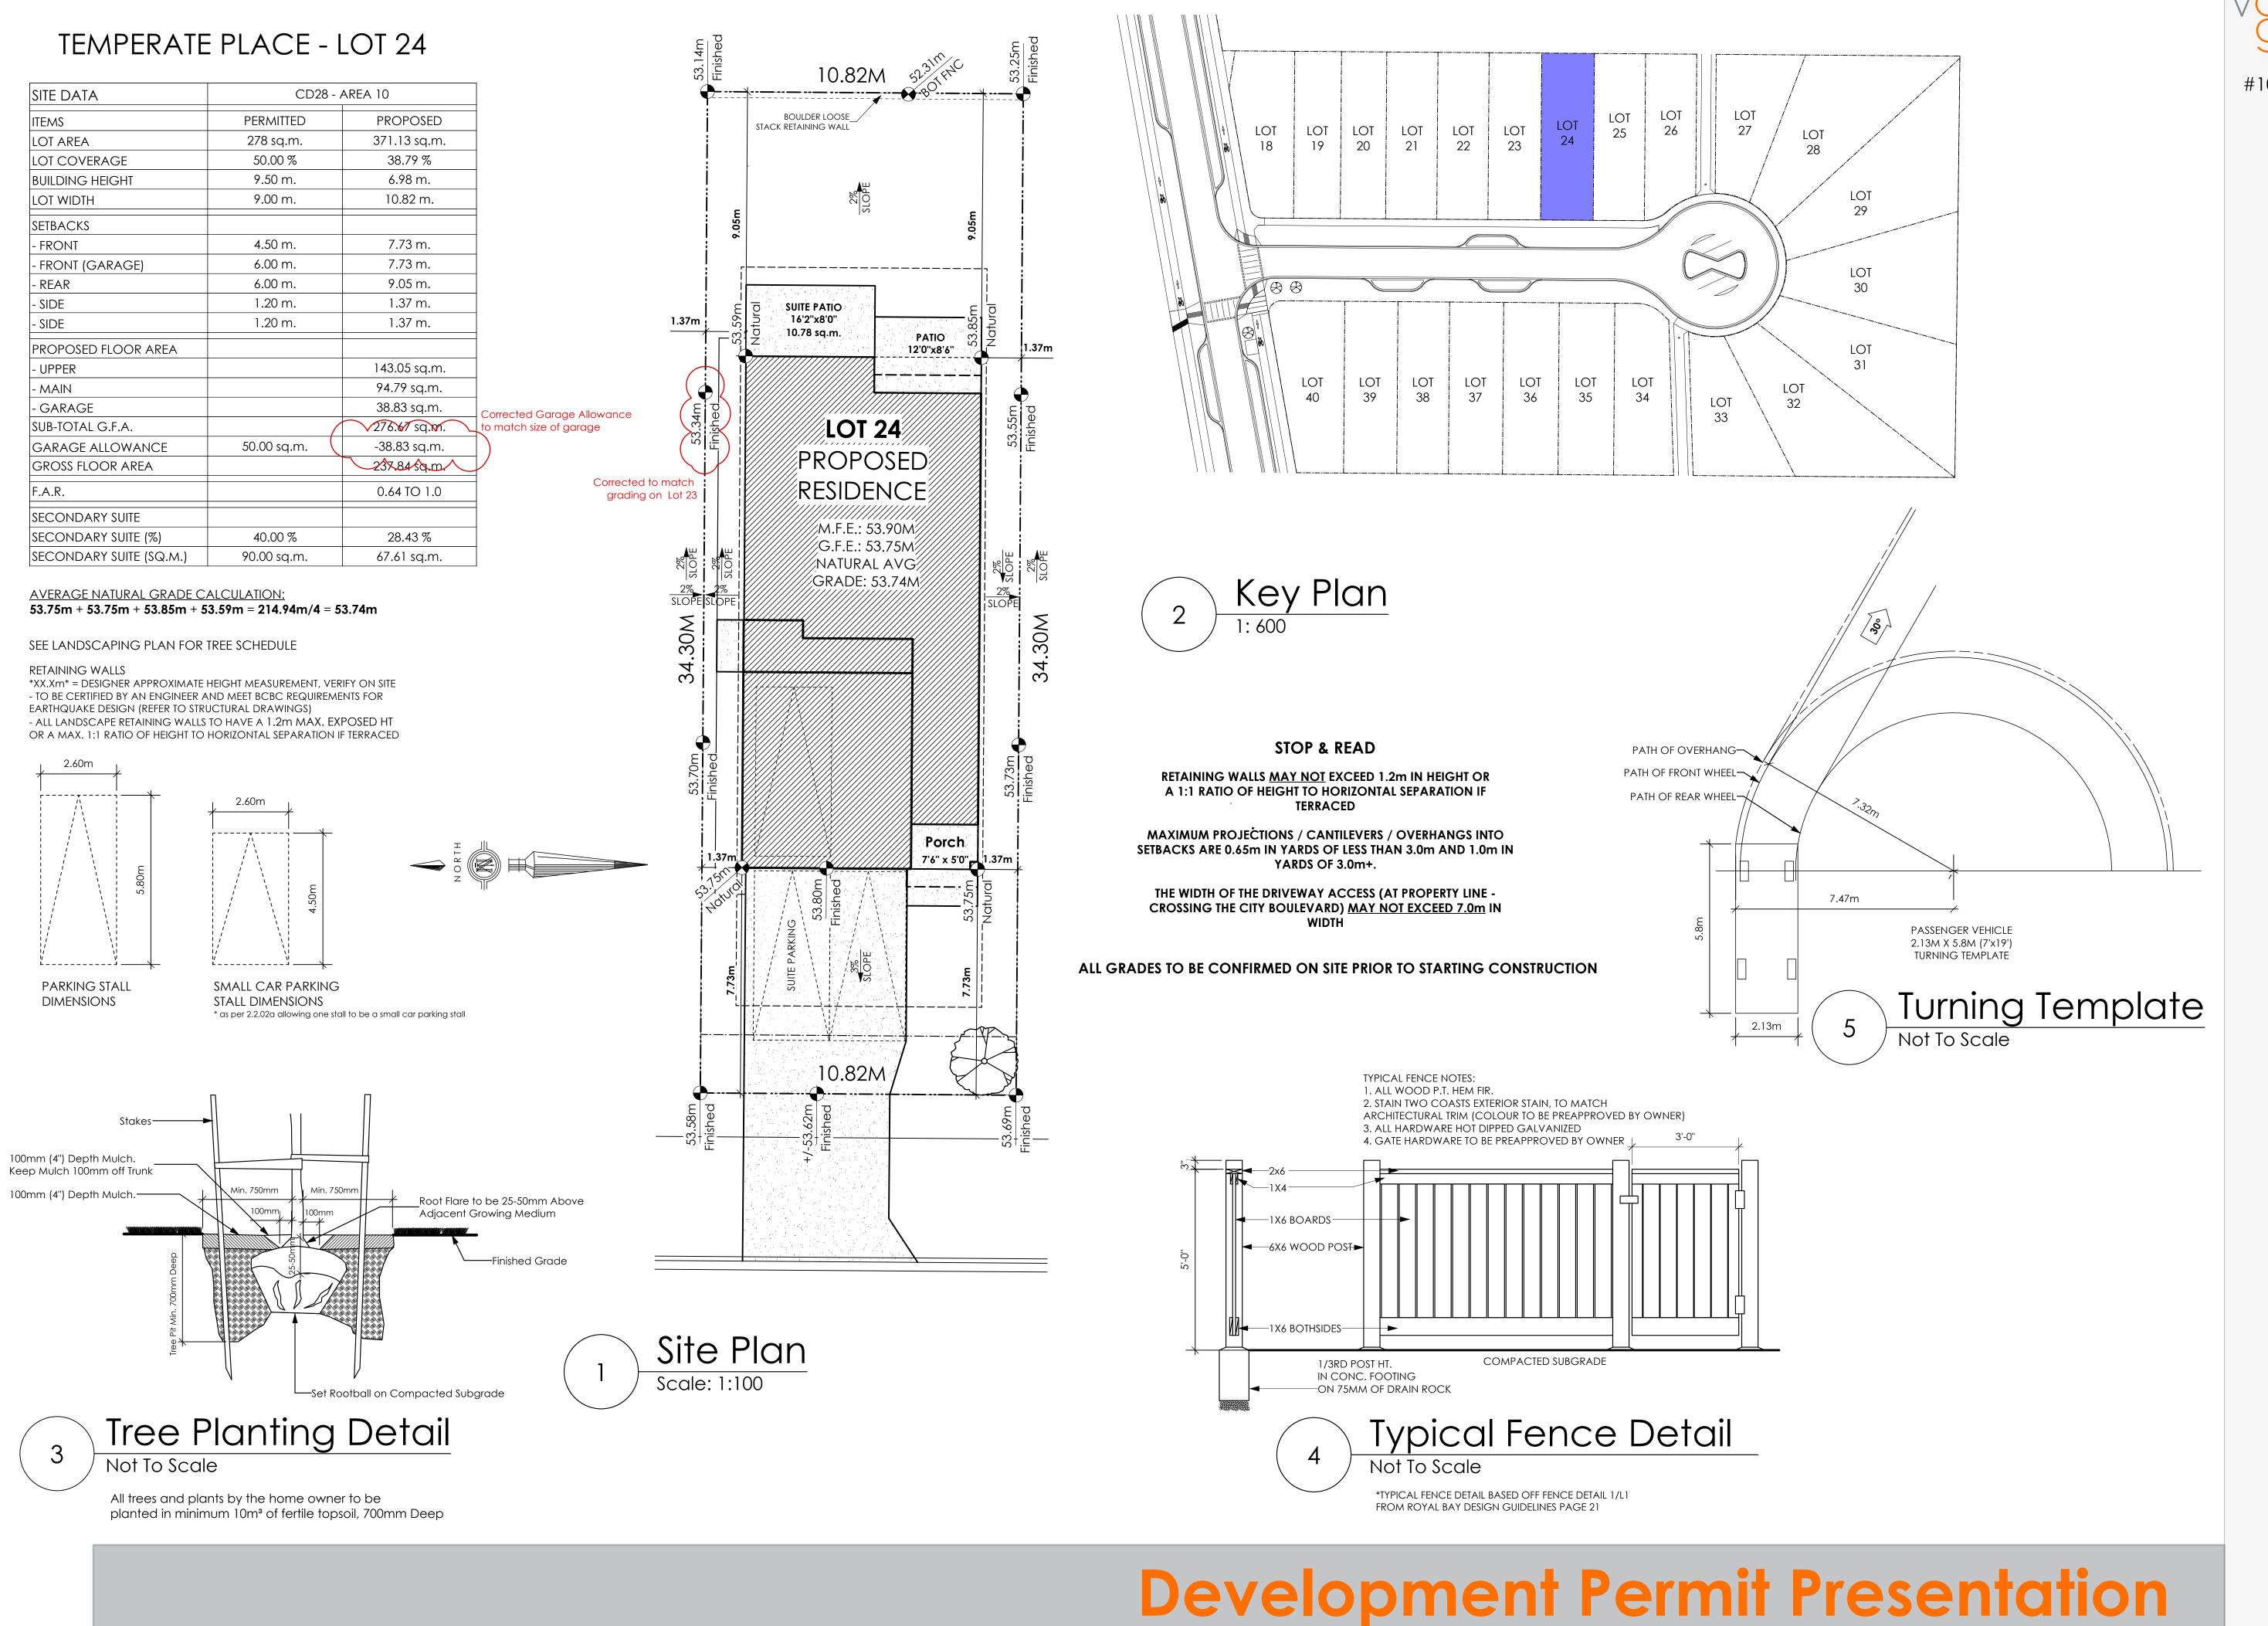

Date

Nov 14, 2024

**Project Address** 

3593 Temperate Place Lot 24 - Royal Bay Colwood, B.C. Prepared for

Verity Construction

Project #

8298-24


Scale


As Noted

Drawn By


MIS

BASEPLAN D TYPE A

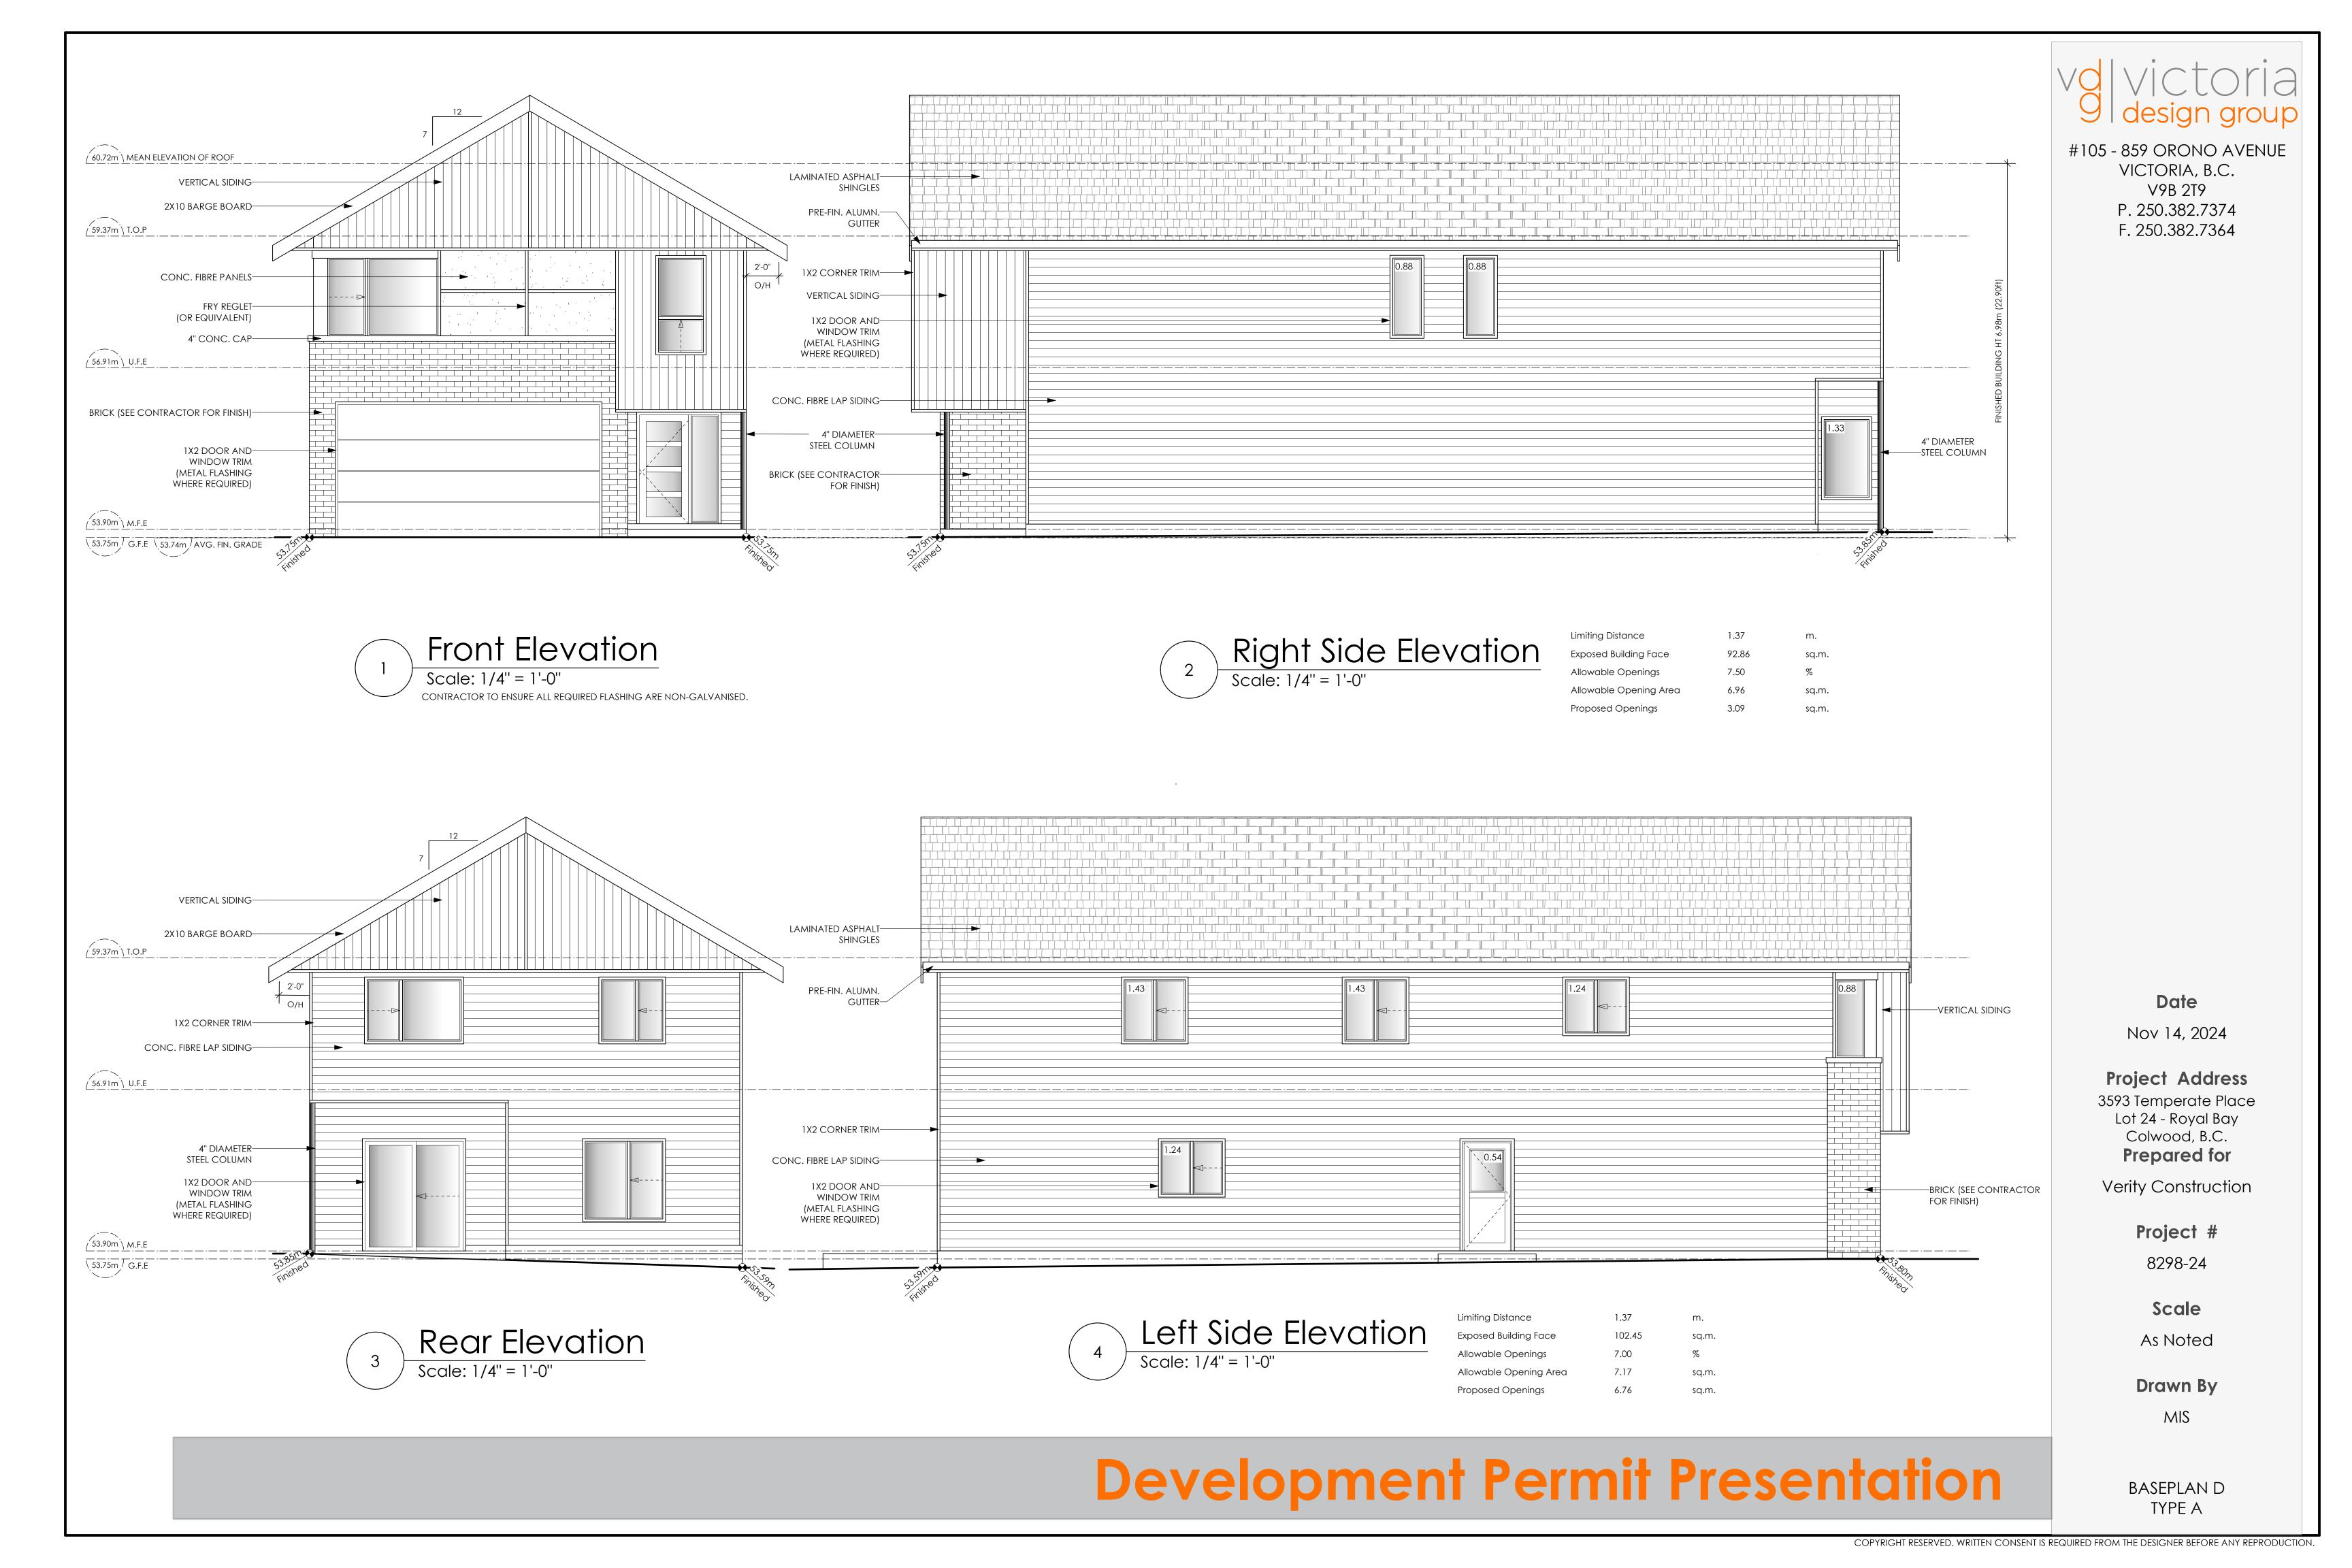

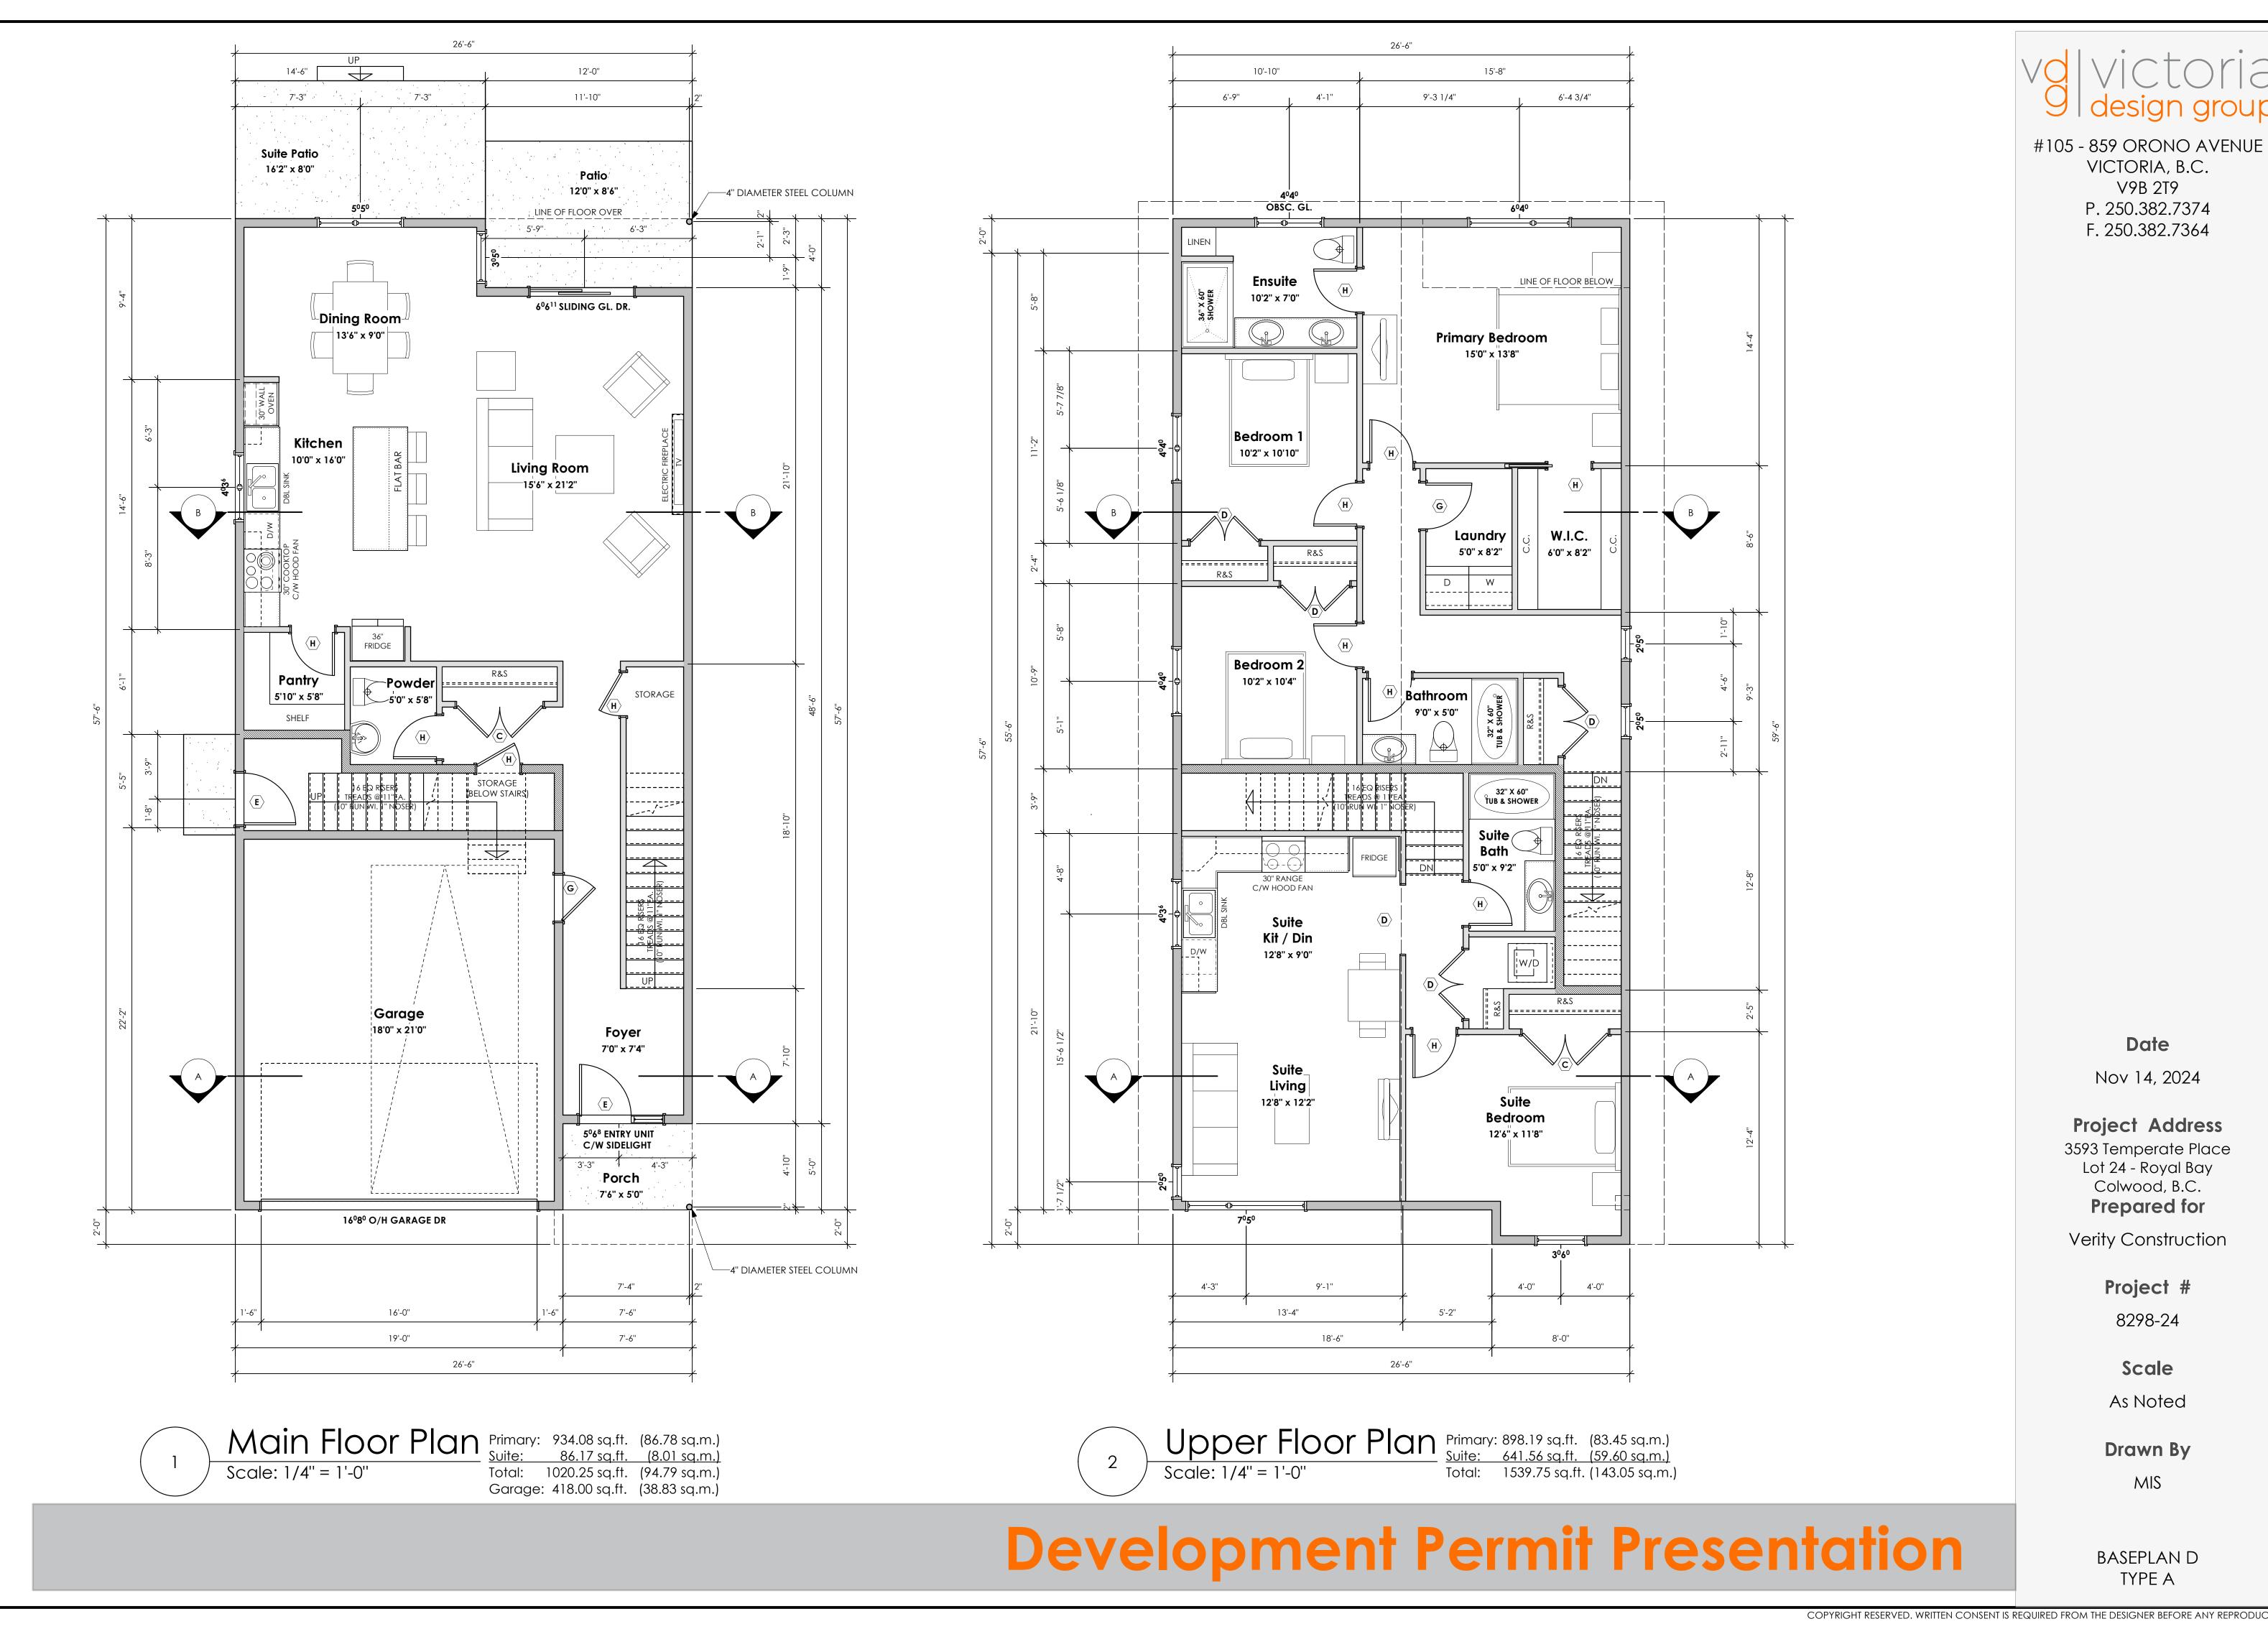



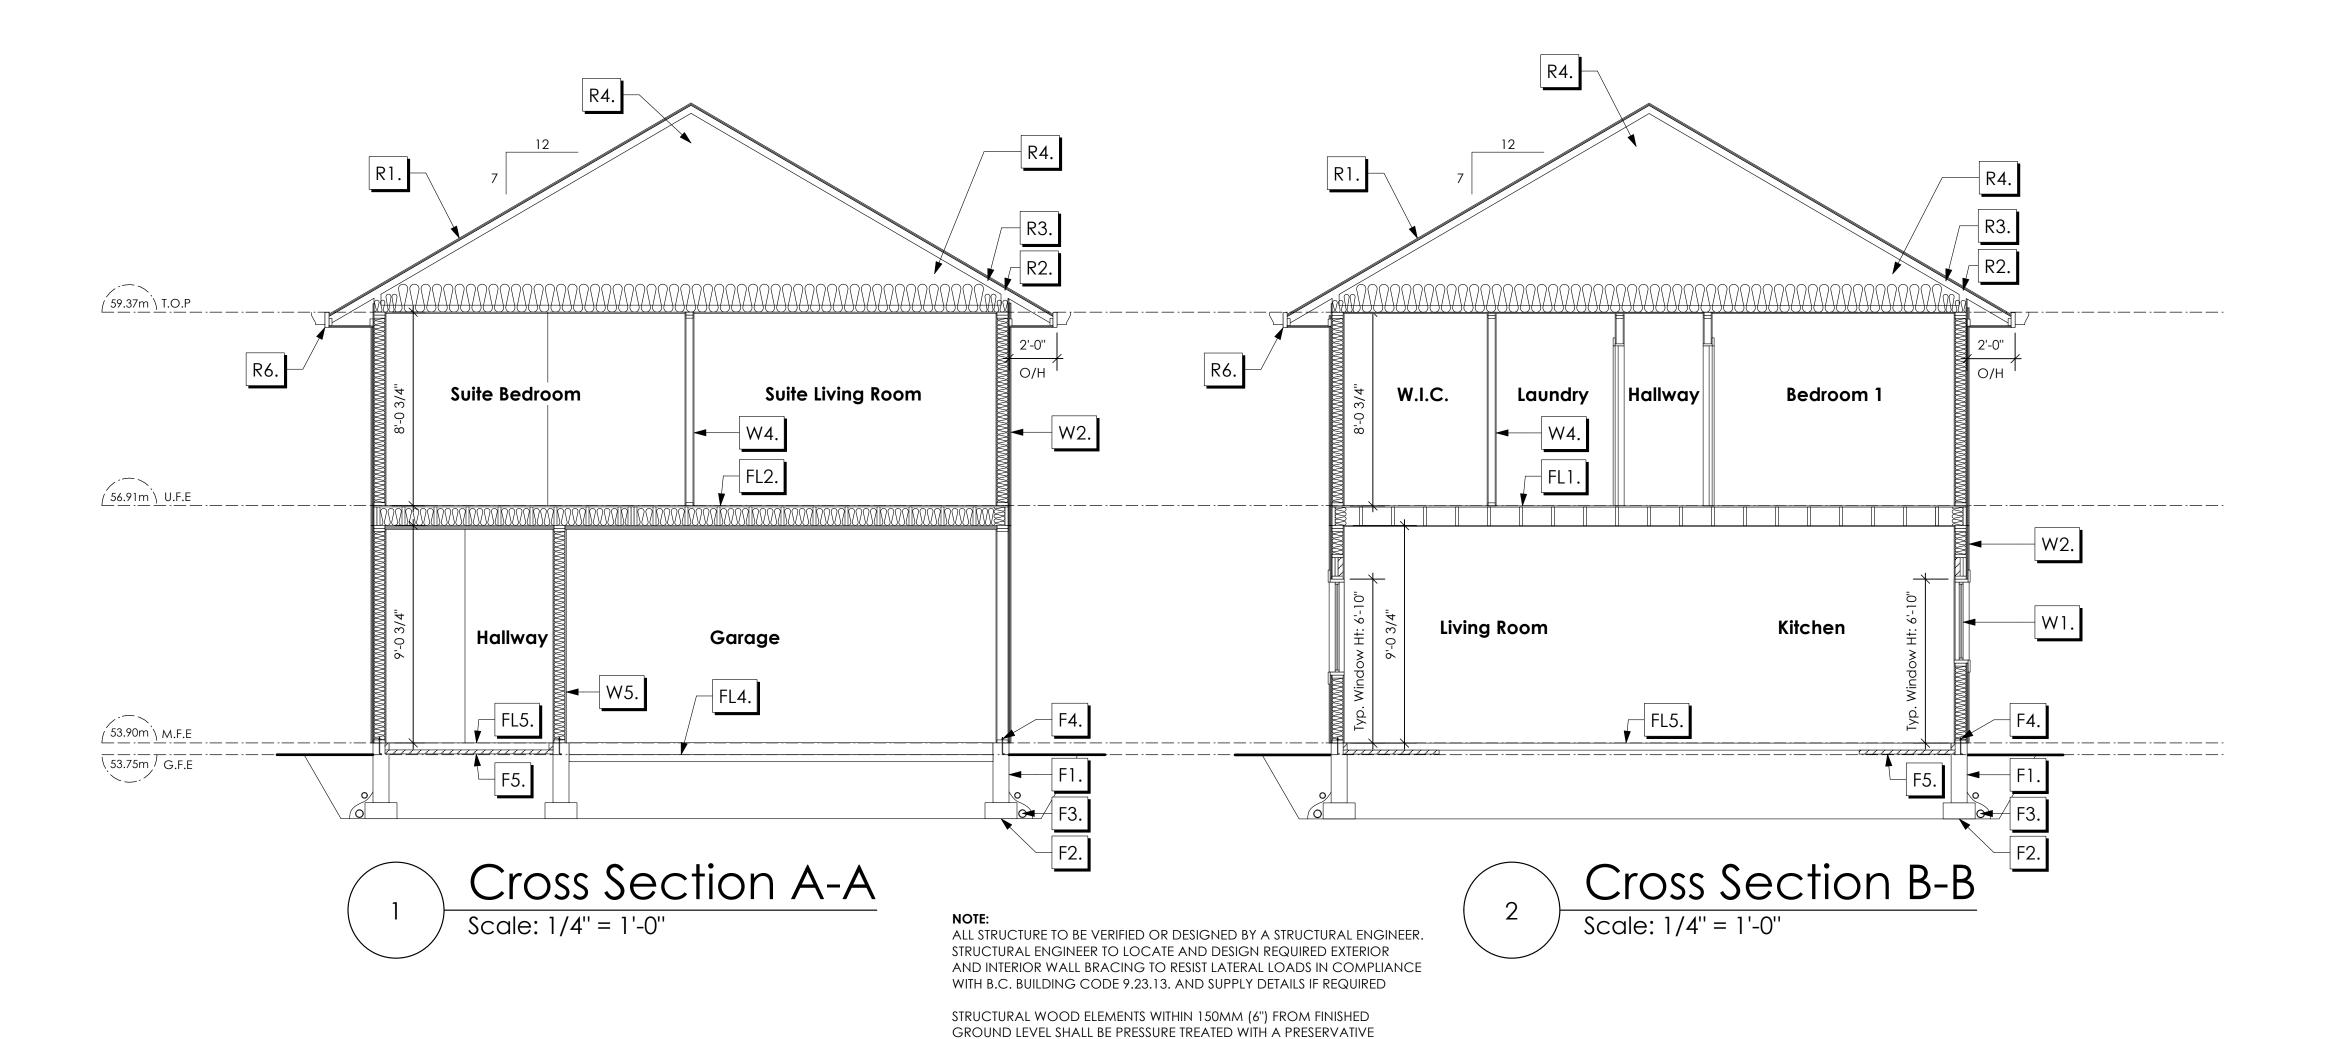

### ROOFS

R1. LAMINATED ASPHALT SHINGLES ON 7/16" ORIENTED STRAND BOARD C/W "H" CLIPS WD TRUSSES (DESIGNED BY MANUF.)
R-40 FIBRE GLAS BATT INSULATION OR 14 1/2" FIBRE GLASS LOOSE FILL INSULATION 6 MIL POLY'N V.B.
5/8" GYPSUM BOARD OR 5/8" X-TYPE GYPSUM BOARD 45 MINUTE RATED F.R.R.

(OVER SECONDARY SUITE)

- R2. PROVIDE 2 1/2" (63MM) CLEAR BETWEEN
  R-20 INSULATION AND SHEATHING.
  (MIN. R-20 @ ROOF-WALL CONNECTION FOR
  4'-0" (1.2M) AROUND PERIMETER OF BUILDING.
  AIR VENTILATION BAFFLES TO BE INSTALLED
  WHERE REQUIRED IN AS PER BCBC 9.19.)
- R3. EAVE PROTECTION

  CONT. UP ROOF SLOPE FOR 12"

  PAST EXTERIOR WALL.
- R4. PROVIDE 1 SQ.FT. ATTIC VENT PER
  300 SQ.FT. OF INSULATED AREA MIN.
  25% OF REQUIRED TO BE @ TOP AND BOTTOM
  (TO COMPLY WI. B.C. BLDG. CODE 9.19.1)
- R5. PRE-FIN. FASCIA GUTTER
  2×8 FASCIA BD.
  2×4 SUB. FASCIA BD.
  VENTED SOFFIT
  (SEE CONTRACTOR)
  (NOT SHOWN IN SECTION)
- R6. PRE-FIN. FASCIA GUTTER
  2×8 FASCIA BD.
  2×4 SUB. FASCIA BD.
  1/2" ORIENTED STRAND BOARD
  VENTED SOFFIT
  (SEE CONTRACTOR)

### **FLOORS**

- FL1. FINISHED FLOORING ON
  19/32" ORIENTED STRAND BOARD
  (NAILED & GLUED TO FLOOR STRUCT. BELOW) ON
  2×10 FLOOR JOISTS @ 16" OR 12" O/C
  C/W 2×2 X-BRIDGING @ 7.0' O/C (MAX)
  1/2" GYPSUM BOARD
- FL2. B.C. BUILDING CODE (TABLE-9.10.3.1.B)
  RATED FLOOR ASSEMBLY F8D
  FINISHED FLOORING ON
  11/16" ORIENTED STRAND BOARD
  (FASTENED & GLUED TO FLOOR STRUCT. BELOW) ON
  2×10 FLOOR JOISTS @ 16" OR 12" O/C
  C/W 2×2 X-BRIDGING @ 7.0' O/C (MAX)
  R-31 INSULATION
  RESILIENT METAL CHANNELS @ 24" O/C
  1 LAYERS 5/8" X-TYPE GYPSUM BOARD
  30 MINUTE F.R.R., 50 S.T.C.
- FL3. FINISHED FLOORING ON

  11/16" ORIENTED STRAND BOARD

  (FASTENED & GLUED TO FLOOR STRUCT. BELOW) ON

  2×10 FLOOR JOISTS @ 16" OR 12" O/C

  C/W 2×2 X-BRIDGING @ 7.0' O/C (MAX)

  PROVIDE R-31 F/G BATT INSULATION IN

  JOIST CAVITY C/W

  BUILDING WRAP

  VENTED SOFFIT (TO OWNERS SPEC'S)

  TO ALL SUSPENDED FLOOR AREAS
- FL4. 3 1/2" CONCRETE SLAB
  6 MIL. POLY'N V.B.
  6" COMPACTED GRAVEL OR SAND
  SLOPE TO DOORS 1"

(NOT SHOWN IN SECTION)

- FL5. 3 1/2" CONCRETE SLAB
  6 MIL. POLY'N V.B.
  6" COMPACTED GRAVEL OR SAND
- FL6. 3 1/2" CONCRETE SLAB 6" COMPACTED GRAVEL OR SAND SLOPE MIN. 2% AWAY FROM BUILDING

### WALLS

FOR TERMITE AND DECAY PROTECTION B.C.B.C. 9.3.2.9.(3)

- W1. DOUBLE GLAZING
  ENERGY STAR LOW "E" RATING IN
  THERMAL BREAK FRAMES
  2/2"X10" LINTEL OVER (@ bearing walls only)
  (TYPICAL, wi. 2 1/2" XPS insulation)
  FLASHING OVER @ EXTERIOR
  (glazing in all exterior doors & within 3 ft.
  of exterior doors to be shatterproof (SP))
- W2. CONC. FIBRE BOARD ON
  9.5MM (3/8") AIR SPACE / STRAPPING
  3/8"×2" BORATE TREATED PLYWOOD STRAPPING
  HOUSE WRAP (A.B.) (TYVEK OR EQ.)
  7/16" ORIENTED STRAND BOARD SHEATHING
  2×6 STUDS @ 16" O/C
  R-20 INSULATION
  6 MIL. POLYETHYLENE VAPOUR BARRIER
  1/2" GYPSUM BOARD
- W3. B.C. BUILDING CODE (TABLE 9.10.3.1.A)
  RATED WALL ASSEMBLY W3c
  1 LAYER 1/2" X-TYPE GYPSUM BOARD
  RESILIENT METAL CHANNELS @ 24" O/C
  2×4 STUDS @ 16" O/C OR
  2×6 STUDS @ 16" O/C (IF NOTED) C/W
  3 1/2" FIBRE GLASS SOUND BATTS
  1 LAYER 1/2" X-TYPE GYPSUM BOARD
  45 MIN. F.R.R 43 S.T.C
  (BETWEEN PRIMARY LIVING & SECONDARY SUITE)
  (NOT SHOWN IN SECTION)
- W4. INTERIOR PARTITION

  1/2" GYPSUM BOARD ON EACH SIDE

  OF 2×4 STUDS @ 16" O/C OR

  2×6 STUDS @ 16" O/C (IF NOTED)
- W5. 5/8" X-TYPE GYPSUM BOARD ON 2×6 STUDS @ 16" O/C C/W
  R-20 INSULATION
  6 MIL. POLY'N V.B
  1/2" GYPSUM BOARD
  (BETWEEN GARAGE & LIVING)

### FOUNDATION

- F1. DAMP PROOFING (WHERE REQUIRED) ON 8" THK. CONC. FOUNDATION WALL C/W 15 M BARS @ 24" O/C B/W
- F2. 16"X 8" CONC. FOOTINGS

  C/W 2 (TWO) 15M BARS CONT. 3 IN. FROM BOTT.

  ON UNDISTURBED SOIL (SOLID BEARING)
- F3. 4" PERIMETER DRAIN
  3" TIGHT PIPE FOR RWL
  DRAIN ROCK
- F4. ANCHOR BOLTS @ 4.0 FT. O/C MAX C/W SILL GASKETS
- F5. UNDER SLAB INSULATION
  2 1/2" (RSI 2.15) EXTRUDED POLYSTYRENE
  RIGID INSULATION 4'-0" (1.2M)
  CONT. AROUND PERIMETER UNDER
  SLAB INSTALLED HORIZONTALLY
  (VERIFY WITH MUNICIPALITY DEPTH OF FROST LINE)

### Date

Nov 14, 2024

# Project Address 3593 Temperate Place Lot 24 - Royal Bay Colwood, B.C.

Prepared for

Verity Construction

Project #

8298-24


Scale

As Noted

Drawn By

MIS

BASEPLAN D TYPE A

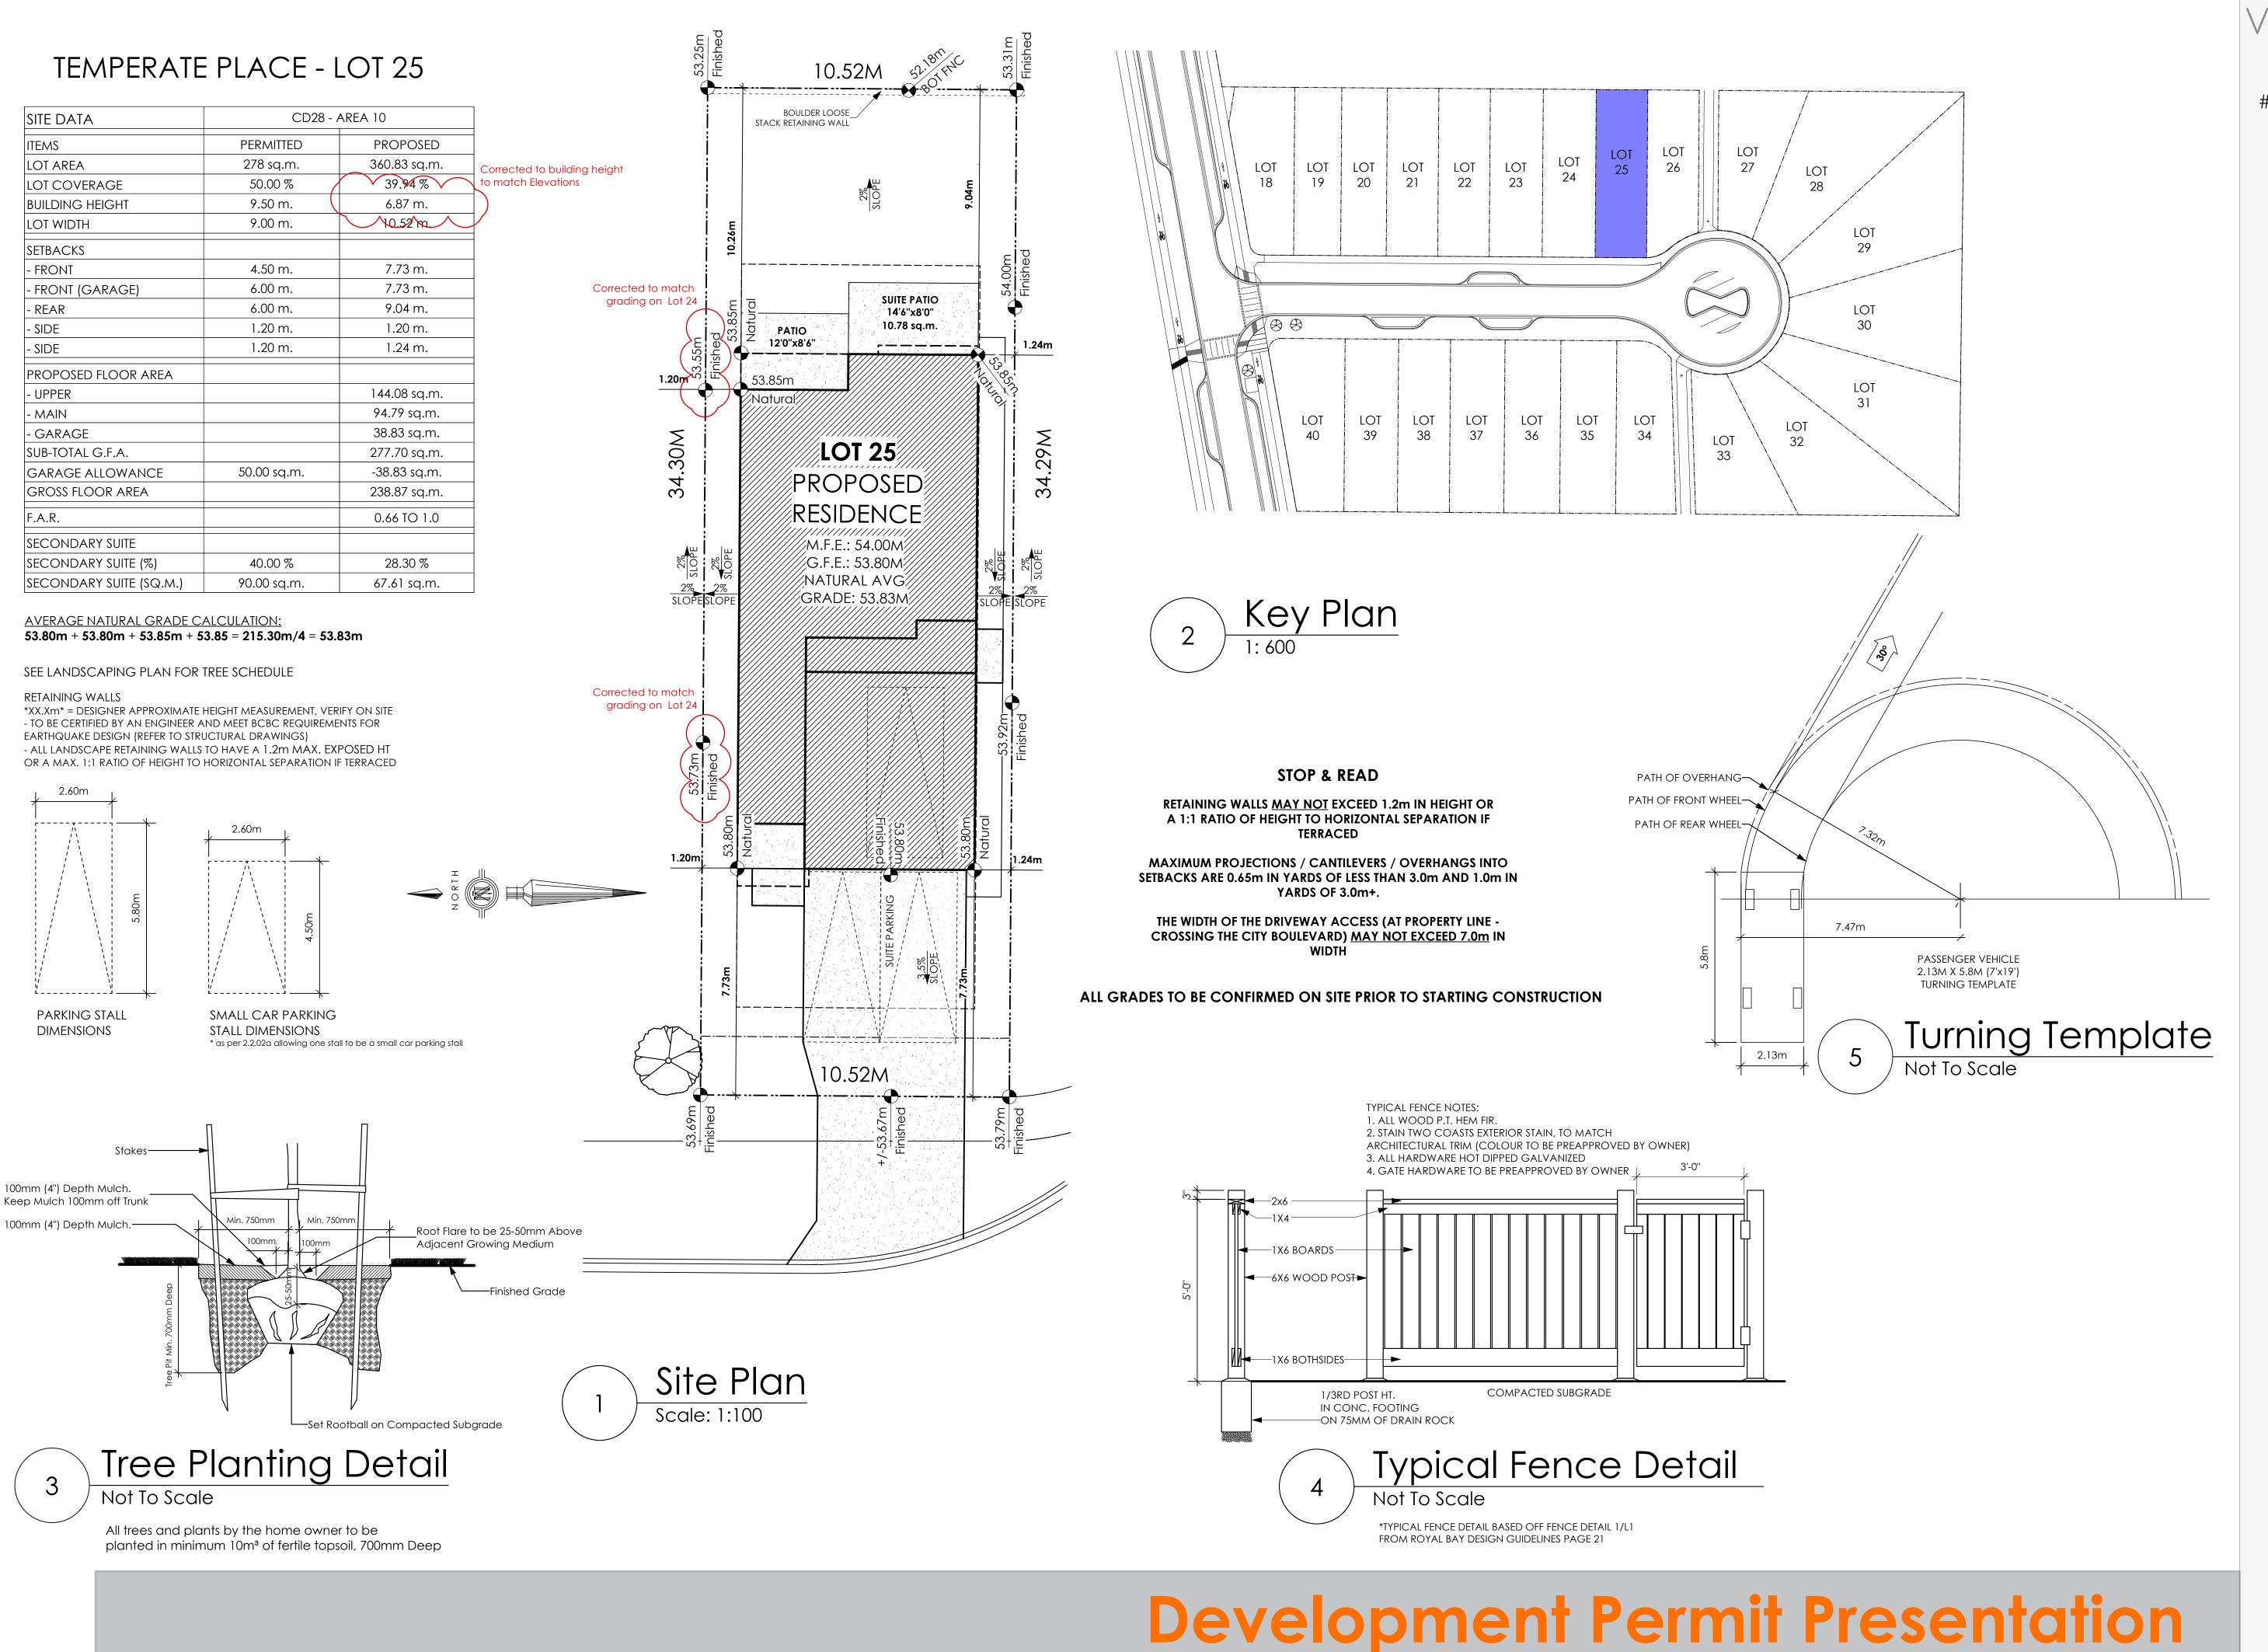

#105 - 859 ORONO AVENUE VICTORIA, B.C.

#105 - 859 ORONO AVEN VICTORIA, B.C. V9B 2T9 P. 250.382.7374 F. 250.382.7364

Date

Nov 25, 2024

**Project Address** 

3595 Temperate Place Lot 25 - Royal Bay Colwood, B.C. **Prepared for** 

Verity Construction

Project #

8298-25


Scale


As Noted

Drawn By


MIS/NS

BASEPLAN D TYPE B

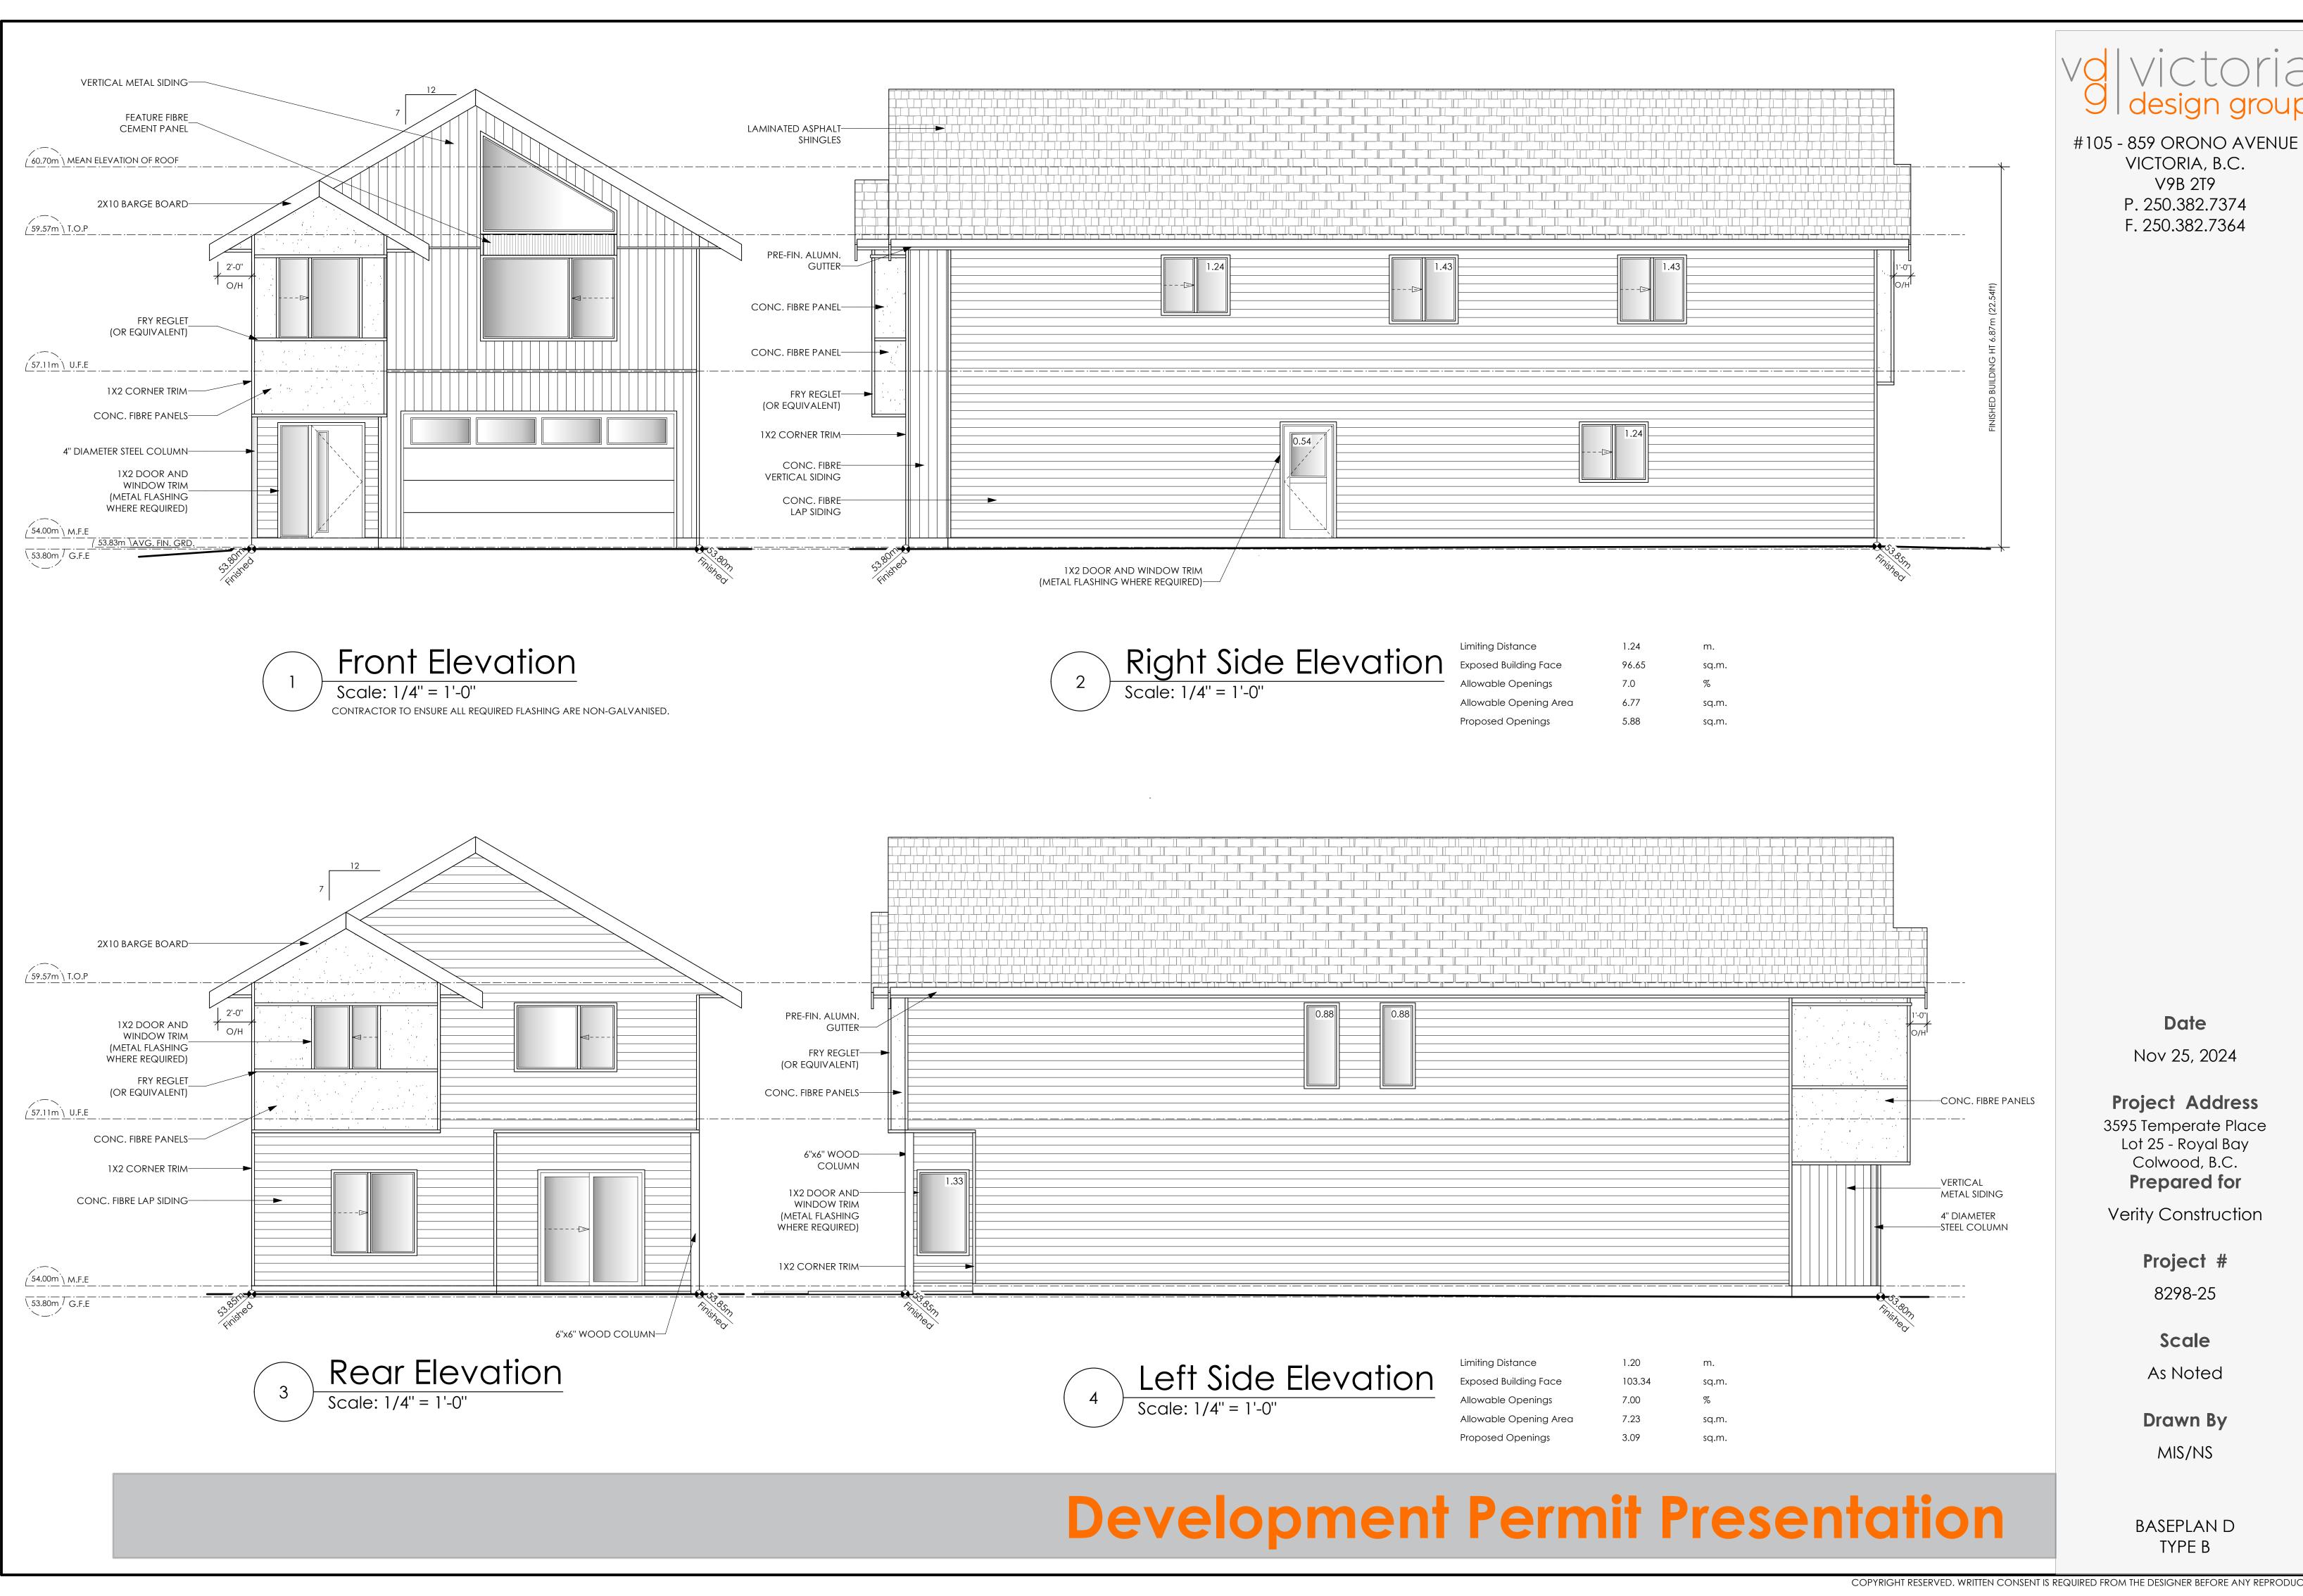

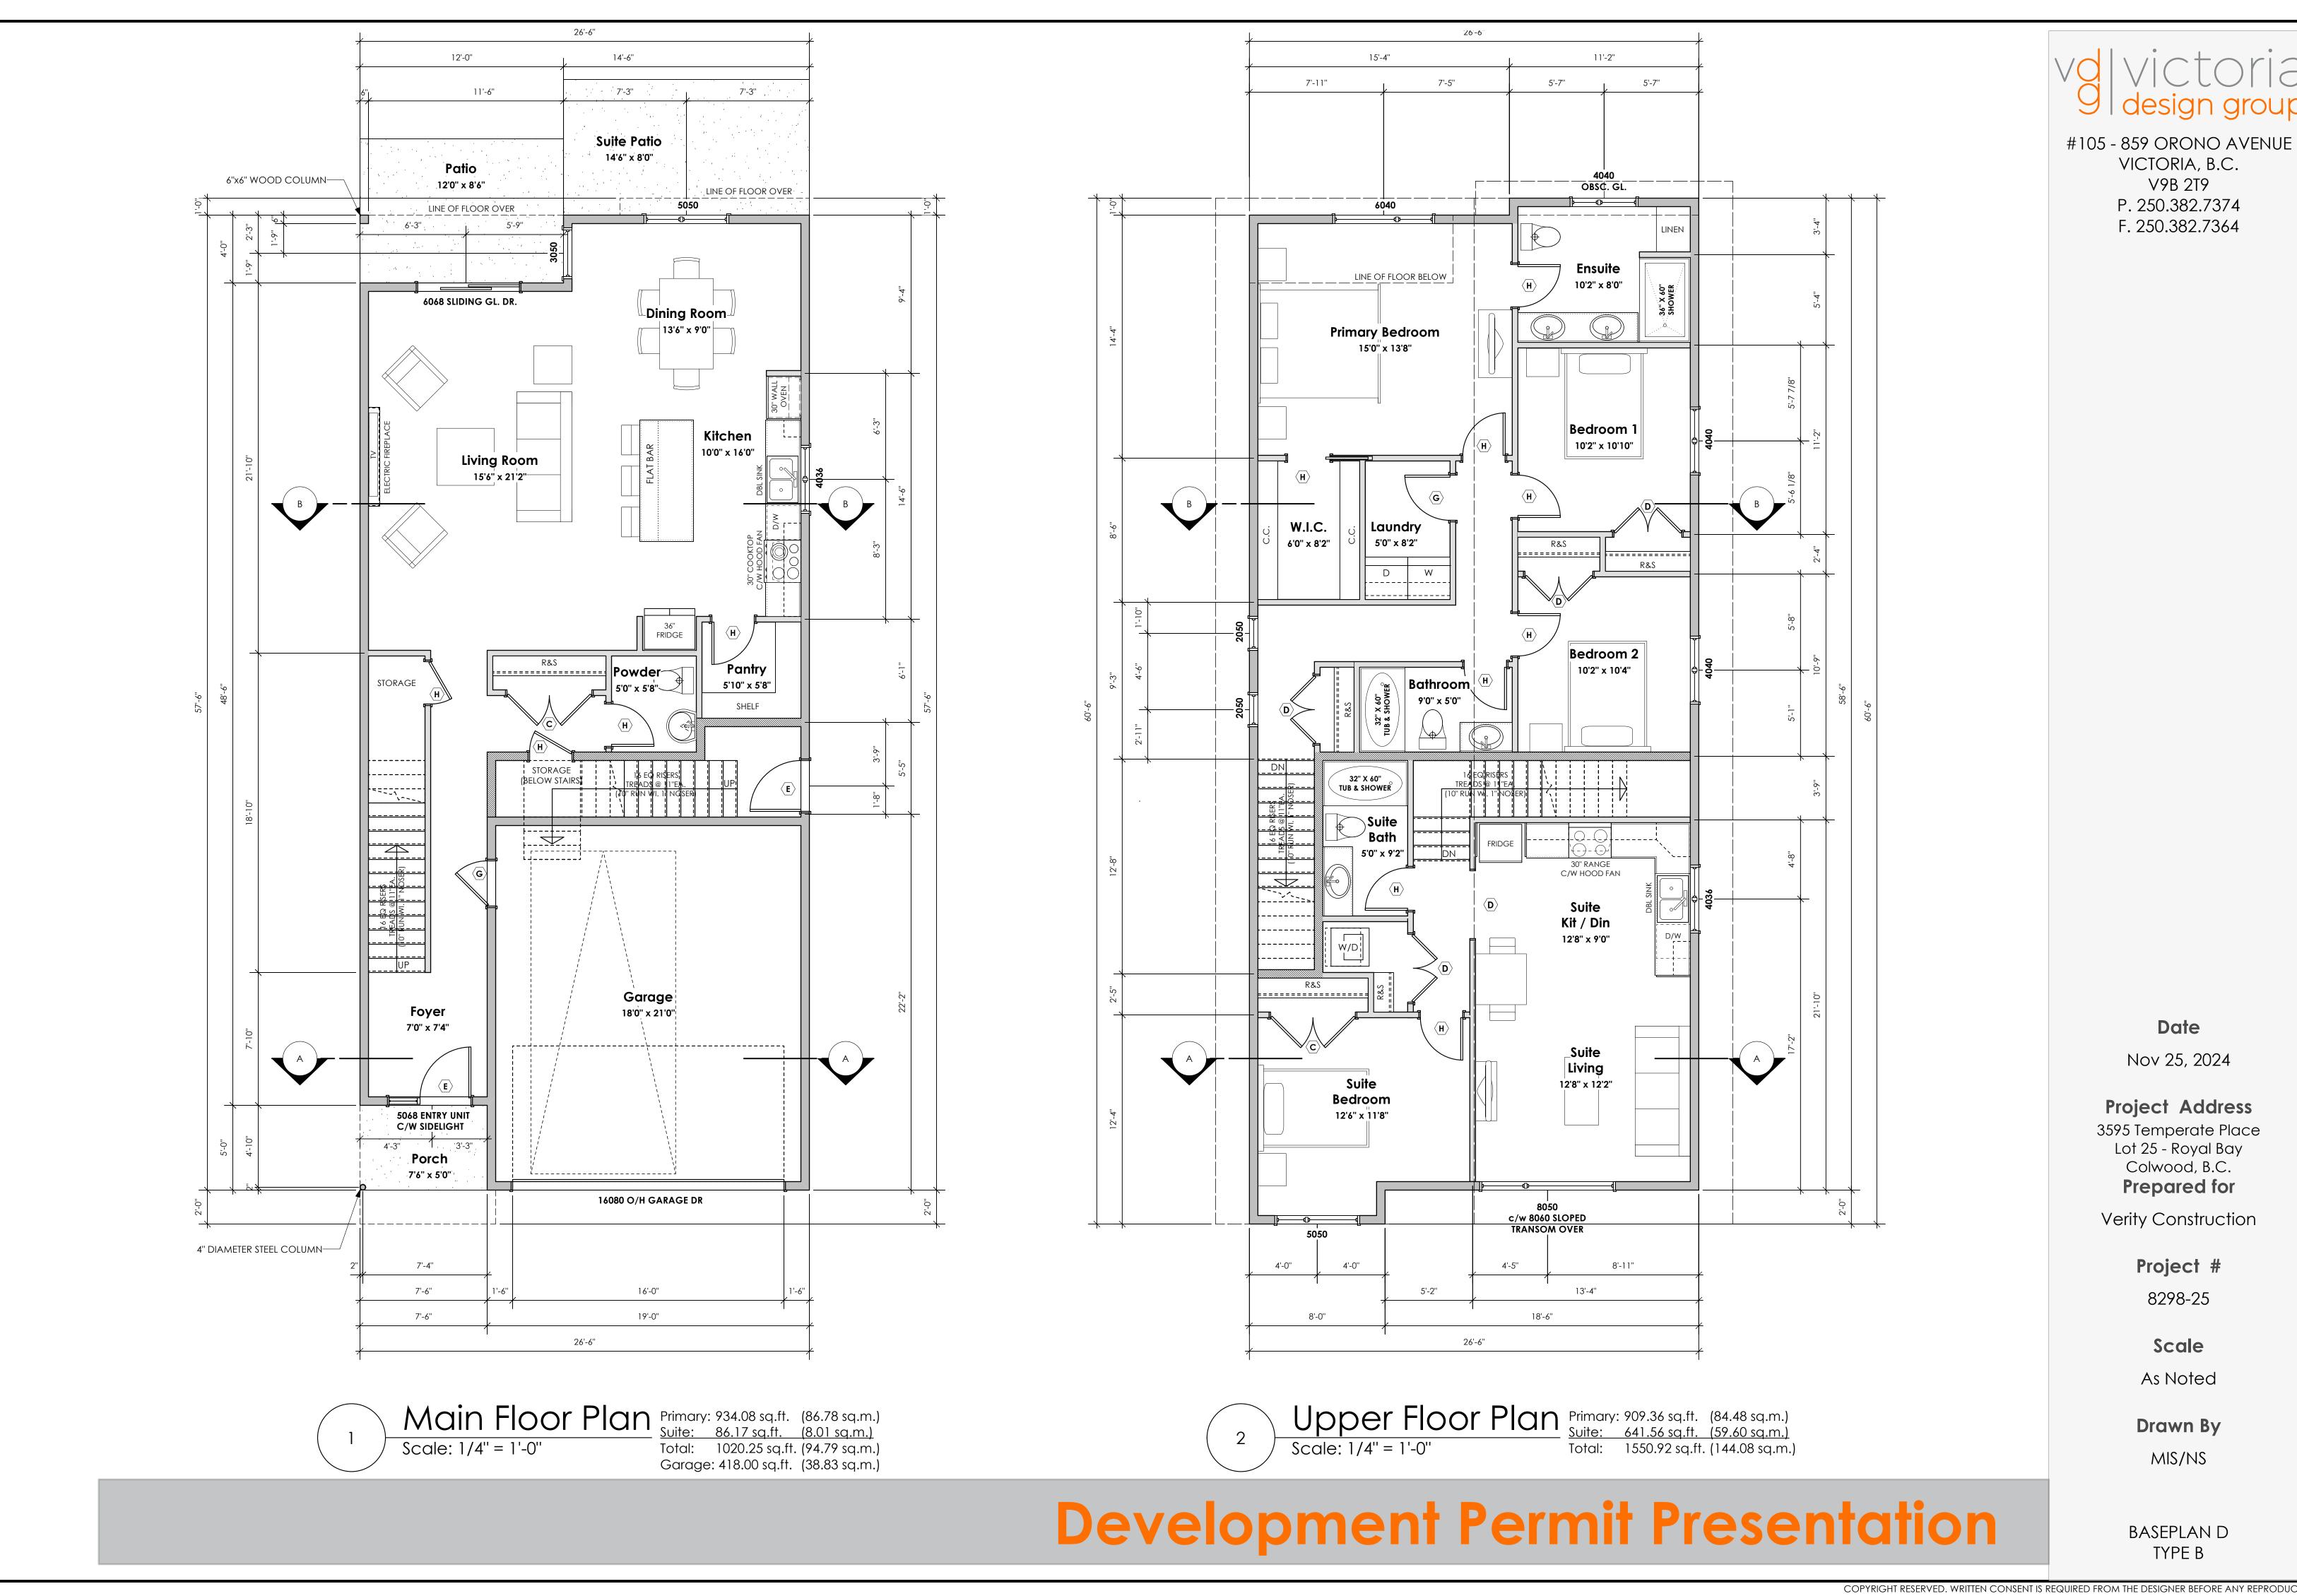



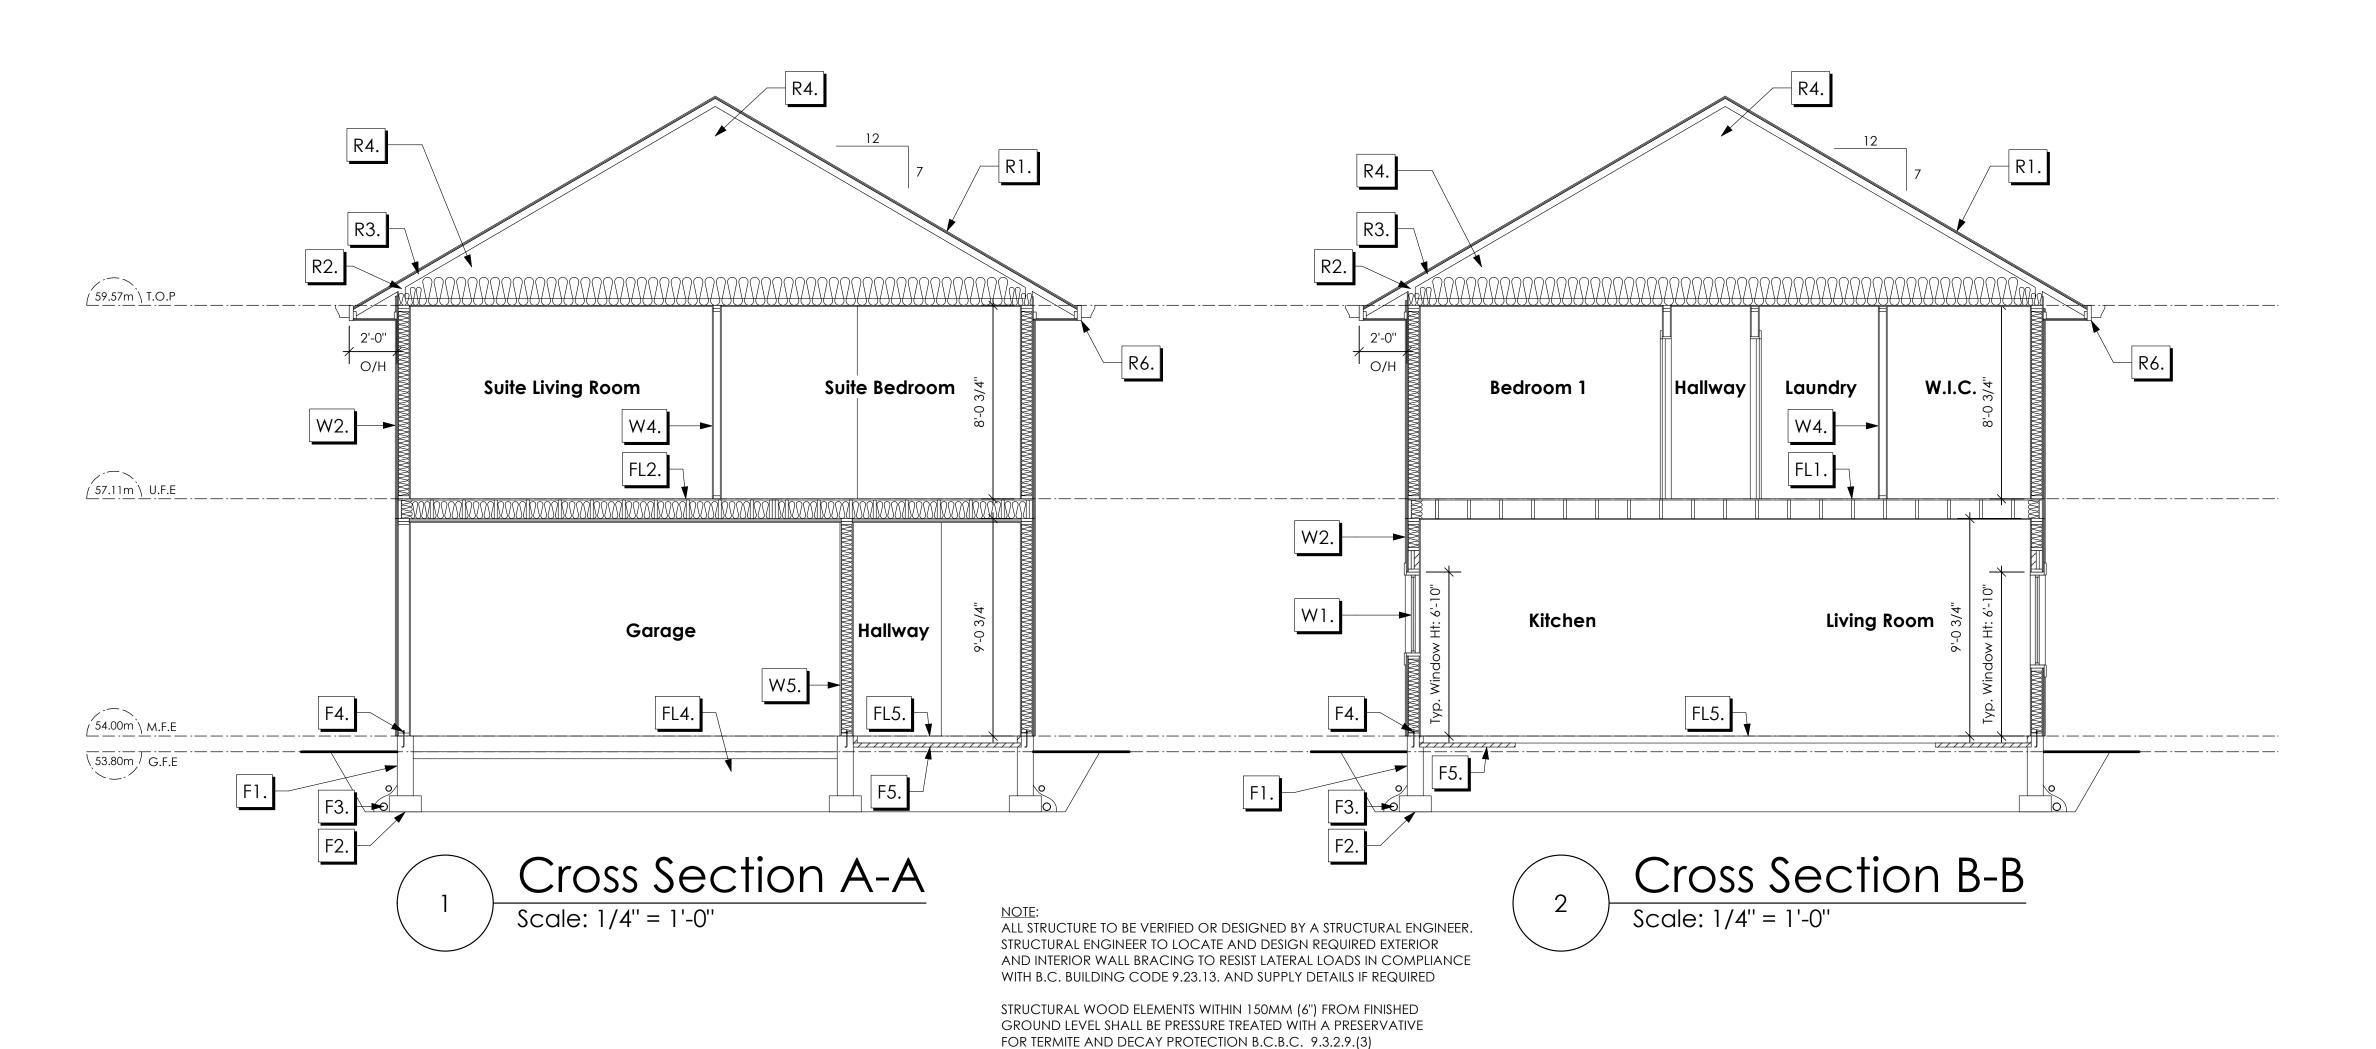

### ROOFS

- R1. LAMINATED ASPHALT SHINGLES ON
  7/16" ORIENTED STRAND BOARD C/W "H" CLIPS
  WD TRUSSES (DESIGNED BY MANUF.)
  R-40 FIBRE GLAS BATT INSULATION OR
  14 1/2" FIBRE GLASS LOOSE FILL INSULATION
  6 MIL POLY'N V.B.
  5/8" GYPSUM BOARD OR
  5/8" X-TYPE GYPSUM BOARD
  45 MINUTE RATED F.R.R.
  (OVER SECONDARY SUITE)
- R2. PROVIDE 2 1/2" (63MM) CLEAR BETWEEN
  R-20 INSULATION AND SHEATHING.
  (MIN. R-20 @ ROOF-WALL CONNECTION FOR
  4'-0" (1.2M) AROUND PERIMETER OF BUILDING.
  AIR VENTILATION BAFFLES TO BE INSTALLED
  WHERE REQUIRED IN AS PER BCBC 9.19.)
- R3. EAVE PROTECTION

  CONT. UP ROOF SLOPE FOR 12"

  PAST EXTERIOR WALL.
- R4. PROVIDE 1 SQ.FT. ATTIC VENT PER
  300 SQ.FT. OF INSULATED AREA MIN.
  25% OF REQUIRED TO BE @ TOP AND BOTTOM
  (TO COMPLY WI. B.C. BLDG. CODE 9.19.1)
- R5. PRE-FIN. FASCIA GUTTER
  2×8 FASCIA BD.
  2×4 SUB. FASCIA BD.
  VENTED SOFFIT
  (SEE CONTRACTOR)
  (NOT SHOWN IN SECTION)
- R6. PRE-FIN. FASCIA GUTTER
  2×8 FASCIA BD.
  2×4 SUB. FASCIA BD.
  1/2" ORIENTED STRAND BOARD
  VENTED SOFFIT
  (SEE CONTRACTOR)

### **FLOORS**

- FL1. FINISHED FLOORING ON
  19/32" ORIENTED STRAND BOARD
  (NAILED & GLUED TO FLOOR STRUCT. BELOW) ON
  2×10 FLOOR JOISTS @ 16" OR 12" O/C
  C/W 2×2 X-BRIDGING @ 7.0' O/C (MAX)
  1/2" GYPSUM BOARD
- FL2. B.C. BUILDING CODE (TABLE-9.10.3.1.B)
  RATED FLOOR ASSEMBLY F8D
  FINISHED FLOORING ON
  11/16" ORIENTED STRAND BOARD
  (FASTENED & GLUED TO FLOOR STRUCT. BELOW) ON
  2×10 FLOOR JOISTS @ 16" OR 12" O/C
  C/W 2×2 X-BRIDGING @ 7.0' O/C (MAX)
  R-31 INSULATION
  RESILIENT METAL CHANNELS @ 24" O/C
  1 LAYERS 5/8" X-TYPE GYPSUM BOARD
  30 MINUTE F.R.R., 50 S.T.C.
- FL3. FINISHED FLOORING ON
  11/16" ORIENTED STRAND BOARD
  (FASTENED & GLUED TO FLOOR STRUCT. BELOW) ON
  2×10 FLOOR JOISTS @ 16" OR 12" O/C
  C/W 2×2 X-BRIDGING @ 7.0' O/C (MAX)
  PROVIDE R-31 F/G BATT INSULATION IN
  JOIST CAVITY C/W
  BUILDING WRAP
  VENTED SOFFIT (TO OWNERS SPEC'S)
  TO ALL SUSPENDED FLOOR AREAS
- FL4. 3 1/2" CONCRETE SLAB
  6 MIL. POLY'N V.B.
  6" COMPACTED GRAVEL OR SAND
  SLOPE TO DOORS 1"

(NOT SHOWN IN SECTION)

- FL5. 3 1/2" CONCRETE SLAB 6 MIL. POLY'N V.B. 6" COMPACTED GRAVEL OR SAND
- FL6. 3 1/2" CONCRETE SLAB
  6" COMPACTED GRAVEL OR SAND
  SLOPE MIN. 2% AWAY FROM BUILDING

### WALLS

- W1. DOUBLE GLAZING
  ENERGY STAR LOW "E" RATING IN
  THERMAL BREAK FRAMES
  2/2"X10" LINTEL OVER (@ bearing walls only)
  (TYPICAL, wi. 2 1/2" XPS insulation)
  FLASHING OVER @ EXTERIOR
  (glazing in all exterior doors & within 3 ft.
  of exterior doors to be shatterproof (SP))
- W2. CONC. FIBRE BOARD ON
  9.5MM (3/8") AIR SPACE / STRAPPING
  3/8"×2" BORATE TREATED PLYWOOD STRAPPING
  HOUSE WRAP (A.B.) (TYVEK OR EQ.)
  7/16" ORIENTED STRAND BOARD SHEATHING
  2×6 STUDS @ 16" O/C
  R-20 INSULATION
  6 MIL. POLYETHYLENE VAPOUR BARRIER
  1/2" GYPSUM BOARD
- W3. B.C. BUILDING CODE (TABLE 9.10.3.1.A)
  RATED WALL ASSEMBLY W3c
  1 LAYER 1/2" X-TYPE GYPSUM BOARD
  RESILIENT METAL CHANNELS @ 24" O/C
  2×4 STUDS @ 16" O/C OR
  2×6 STUDS @ 16" O/C (IF NOTED) C/W
  3 1/2" FIBRE GLASS SOUND BATTS
  1 LAYER 1/2" X-TYPE GYPSUM BOARD
  45 MIN. F.R.R 43 S.T.C
  (BETWEEN PRIMARY LIVING & SECONDARY SUITE)
  (NOT SHOWN IN SECTION)
- W4. INTERIOR PARTITION

  1/2" GYPSUM BOARD ON EACH SIDE

  OF 2×4 STUDS @ 16" O/C OR

  2×6 STUDS @ 16" O/C (IF NOTED)
- W5. 5/8" X-TYPE GYPSUM BOARD ON 2×6 STUDS @ 16" O/C C/W
  R-20 INSULATION
  6 MIL. POLY'N V.B
  1/2" GYPSUM BOARD
  (BETWEEN GARAGE & LIVING)

### FOUNDATION

- F1. DAMP PROOFING (WHERE REQUIRED) ON 8" THK. CONC. FOUNDATION WALL C/W 15 M BARS @ 24" O/C B/W
- F2. 16"X 8" CONC. FOOTINGS

  C/W 2 (TWO) 15M BARS CONT. 3 IN. FROM BOTT.

  ON UNDISTURBED SOIL (SOLID BEARING)
- F3. 4" PERIMETER DRAIN
  3" TIGHT PIPE FOR RWL
  DRAIN ROCK
- F4. ANCHOR BOLTS @ 4.0 FT. O/C MAX C/W SILL GASKETS
- F5. UNDER SLAB INSULATION
  2 1/2" (RSI 2.15) EXTRUDED POLYSTYRENE
  RIGID INSULATION 4'-0" (1.2M)
  CONT. AROUND PERIMETER UNDER
  SLAB INSTALLED HORIZONTALLY
  (VERIFY WITH MUNICIPALITY DEPTH OF FROST LINE)

## Date

Nov 25, 2024

# Project Address 3595 Temperate Place Lot 25 - Royal Bay

Colwood, B.C.

Prepared for

Verity Construction

Project #

8298-25


Scale

As Noted

Drawn By

MIS/NS

BASEPLAN D TYPE B

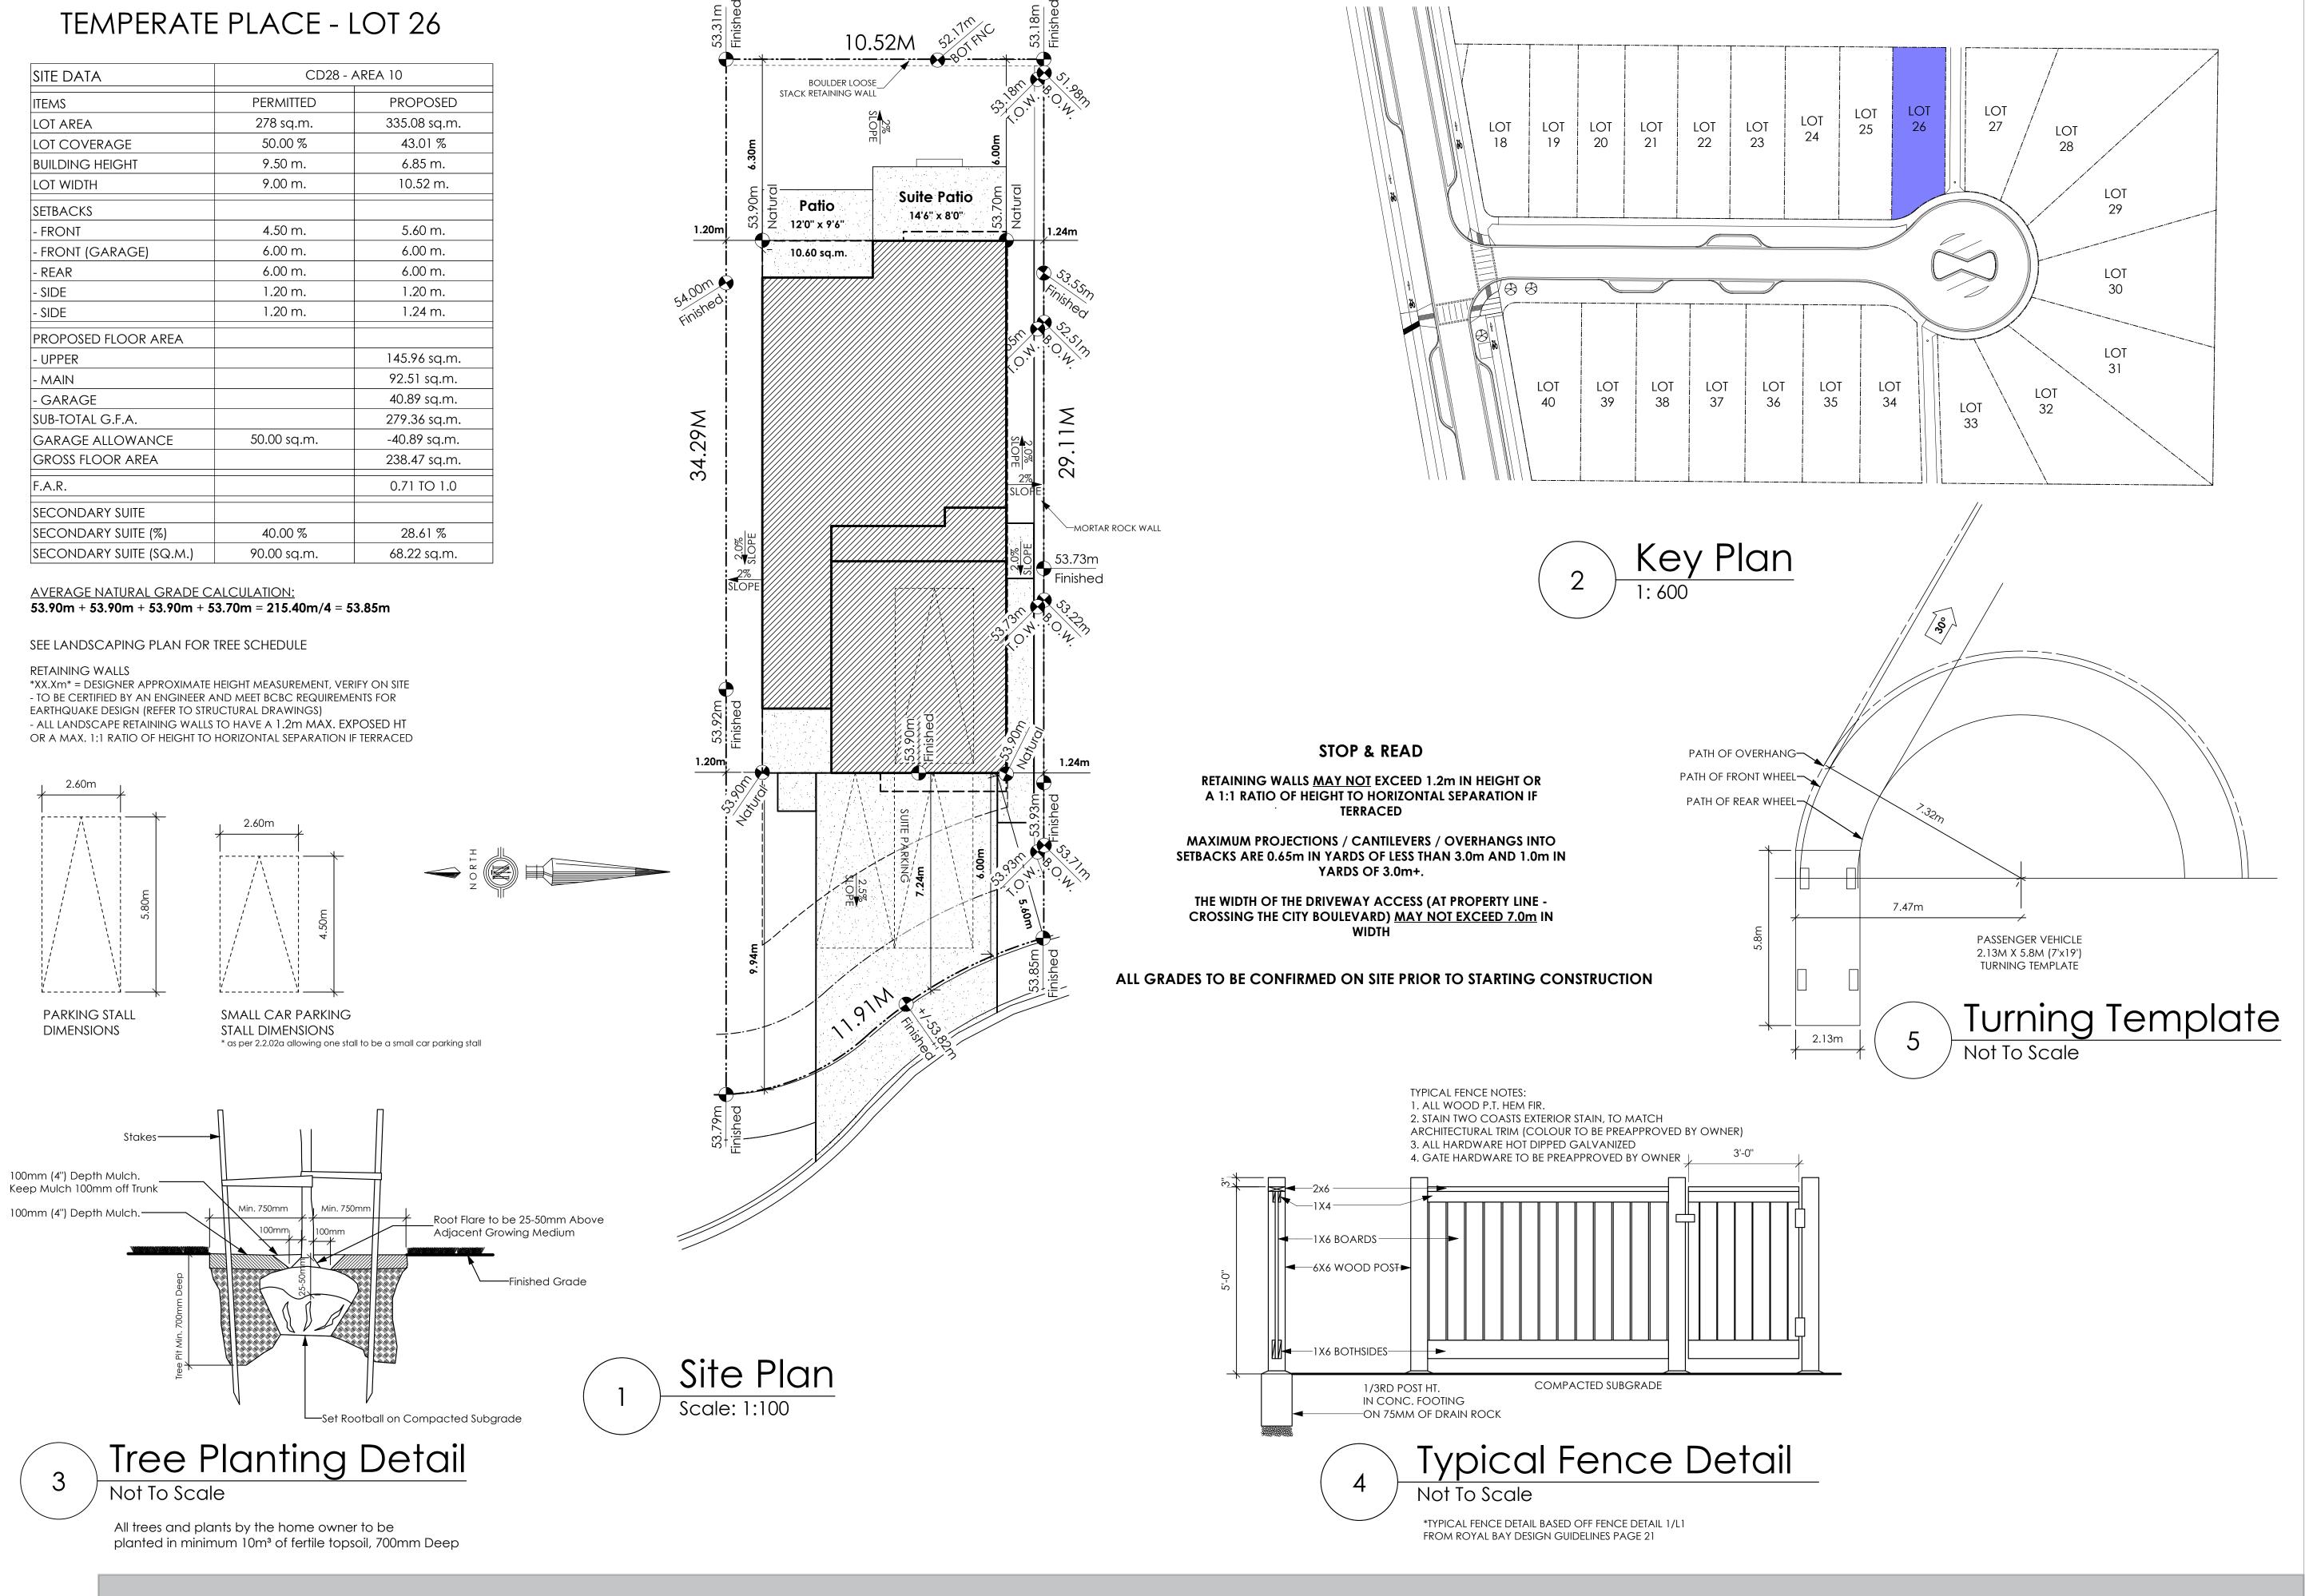

# Volvictoria 9 design group

#105 - 859 ORONO AVENUE VICTORIA, B.C. V9B 2T9 P. 250.382.7374 F. 250.382.7364

Date

Nov 5, 2024

**Project Address** 

3597 Temperate Place Lot 26 - Royal Bay Colwood, B.C. **Prepared for** 

Verity Construction

Project #

8298-26

Scale


As Noted

Drawn By

MIS

BASEPLAN D TYPE D



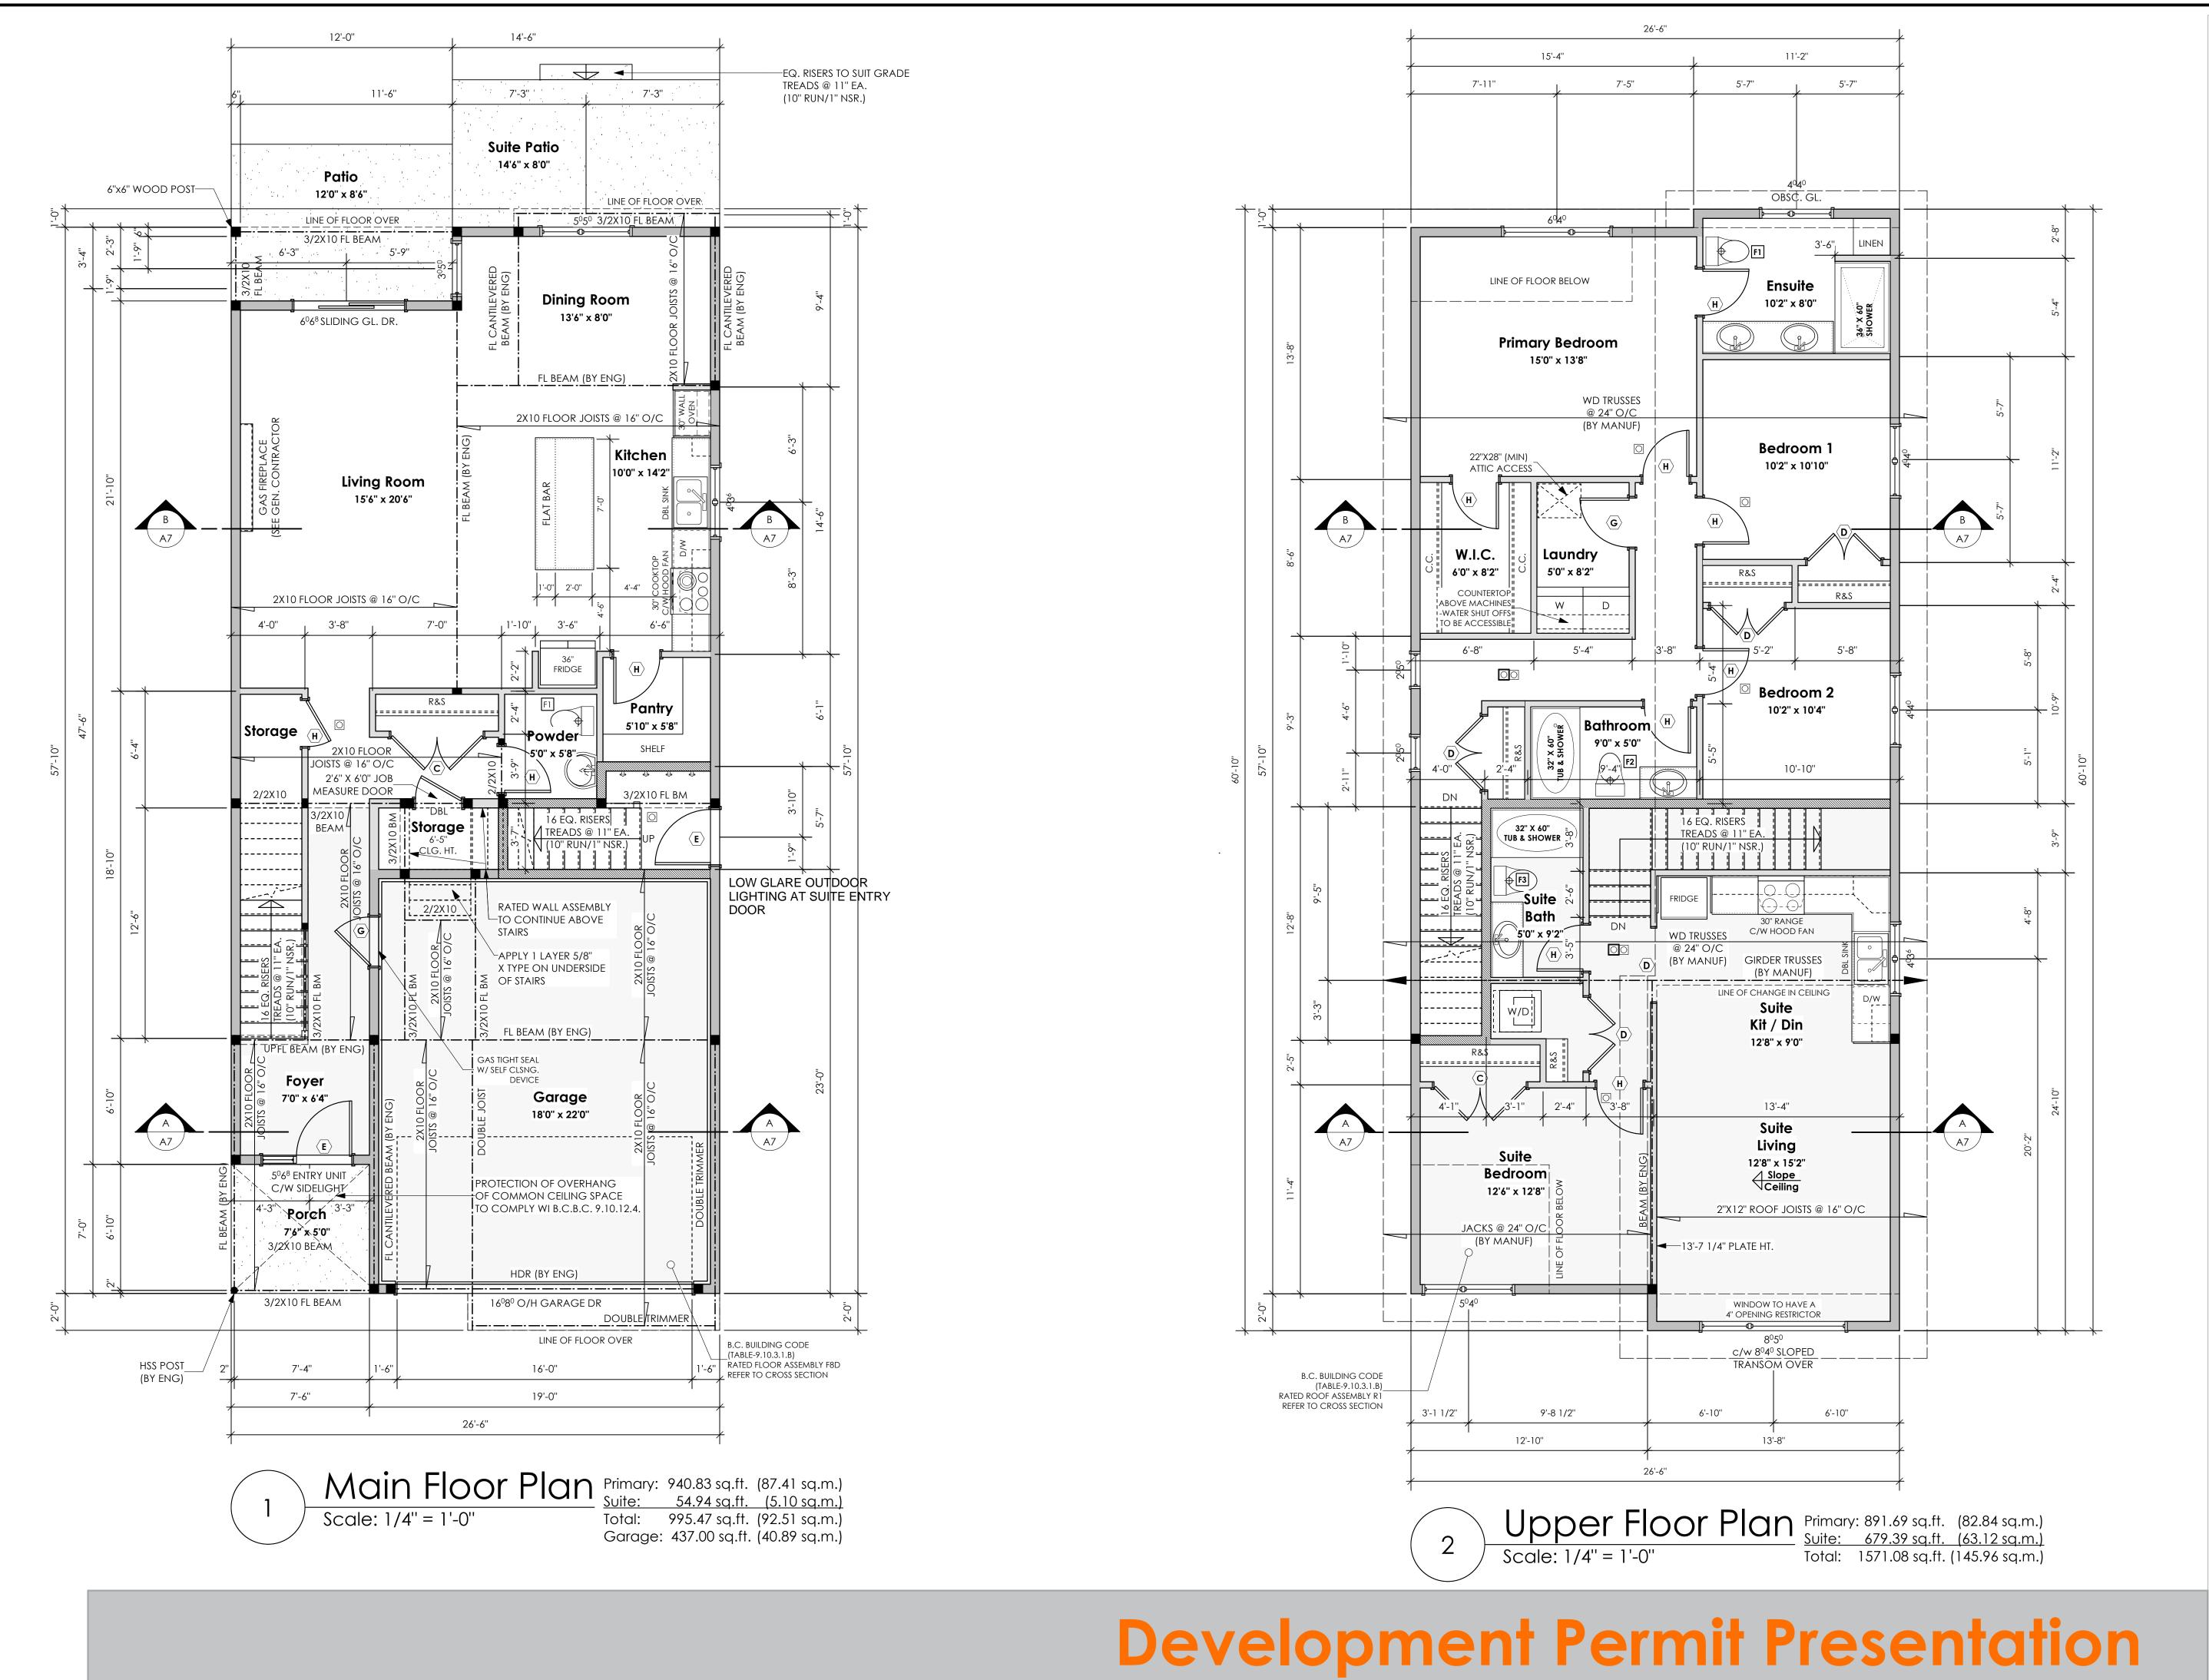

Volvictoria design group

#105 - 859 ORONO AVENUE VICTORIA, B.C. V9B 2T9 P. 250.382.7374 F. 250.382.7364

Date

Nov 5, 2024

**Project Address** 

3597 Temperate Place Lot 26 - Royal Bay Colwood, B.C. **Prepared for** 

Verity Construction

Project #

8298-26


Scale

As Noted

Drawn By

MIS

BASEPLAN D TYPE D

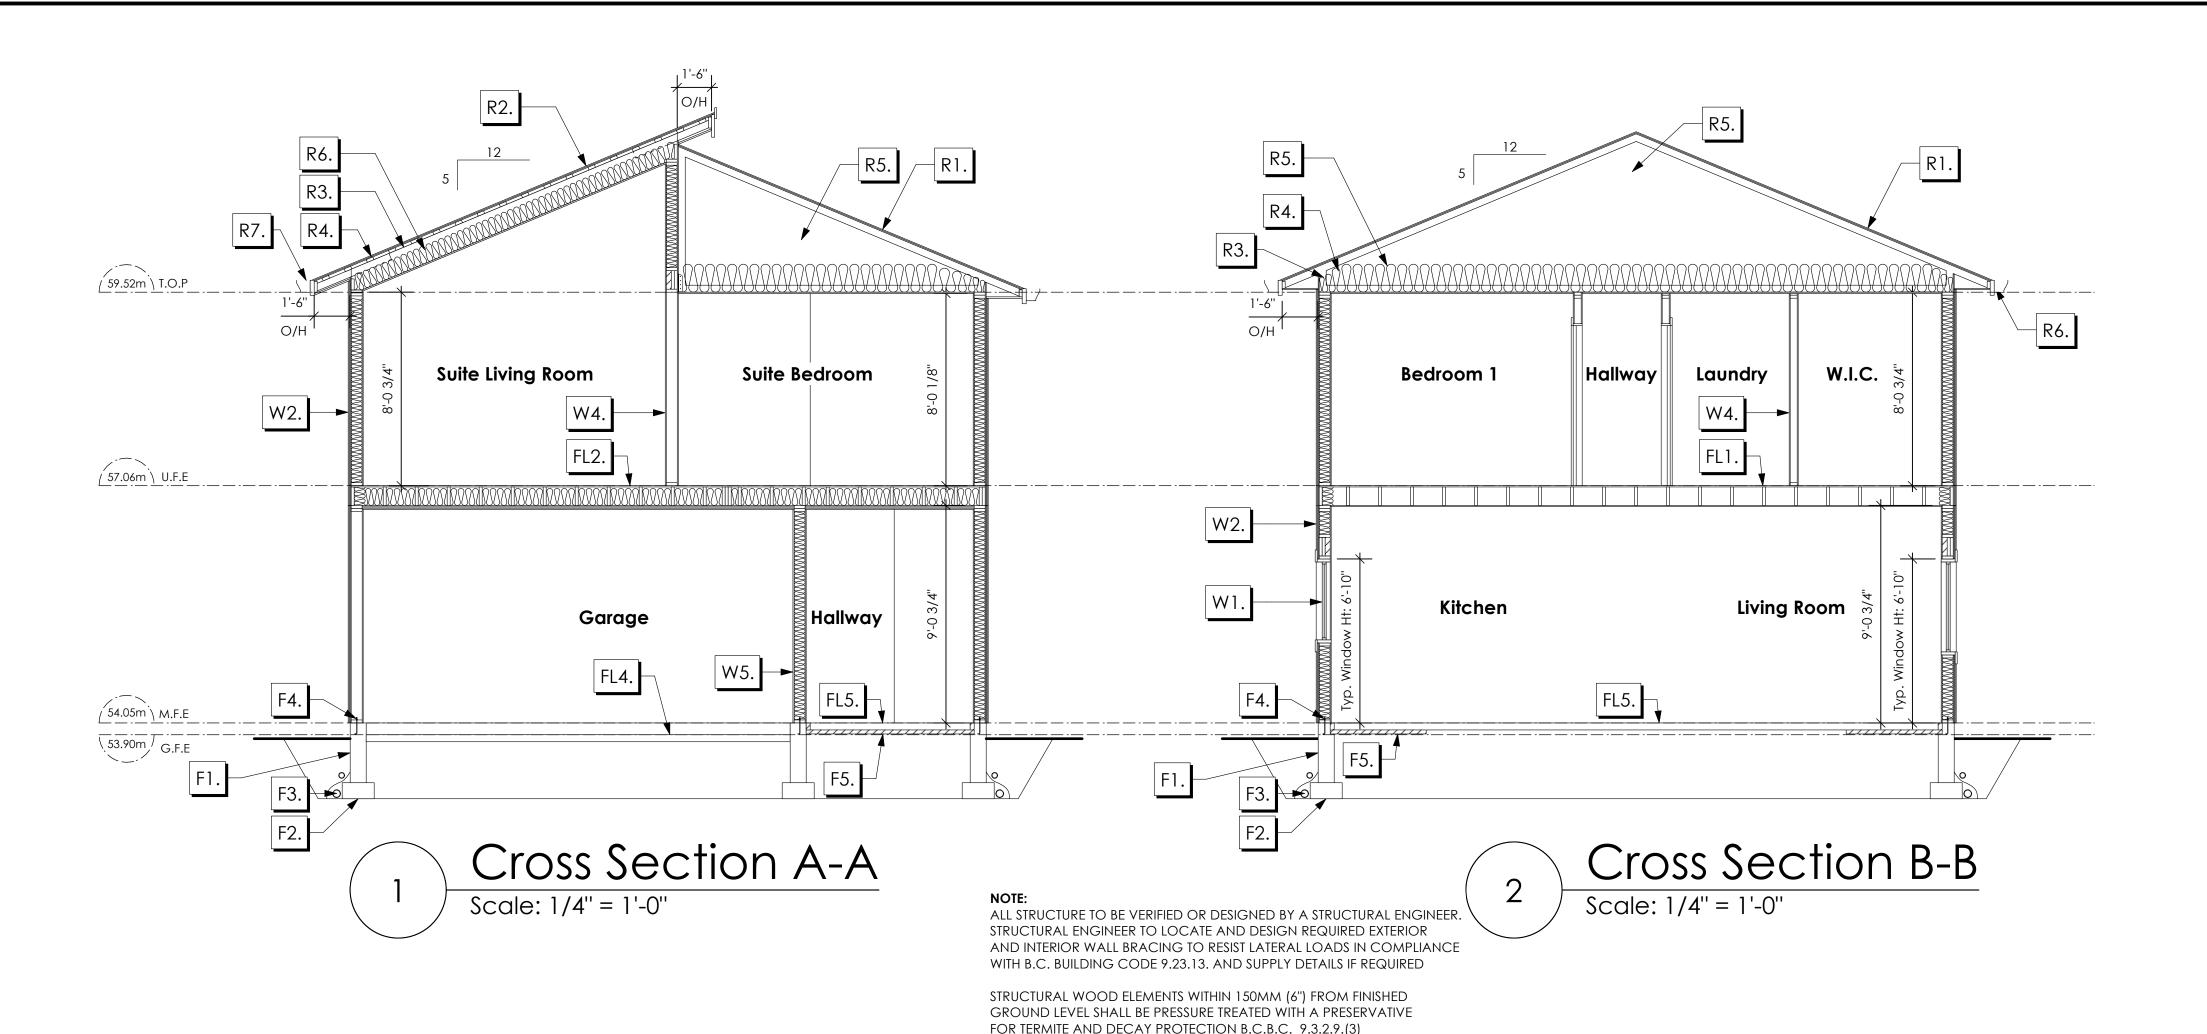

## ROOFS

- R1. LAMINATED ASPHALT SHINGLES ON
  7/16" ORIENTED STRAND BOARD C/W "H" CLIPS
  WD TRUSSES (DESIGNED BY MANUF.)
  R-40 FIBRE GLAS BATT INSULATION OR
  14 1/2" FIBRE GLASS LOOSE FILL INSULATION
  6 MIL POLY'N V.B.
  5/8" GYPSUM BOARD OR
  5/8" X-TYPE GYPSUM BOARD
  45 MINUTE RATED F.R.R.
  (OVER SECONDARY SUITE)
- R2. LAMINATED ASPHALT SHINGLES ON
  7/16" ORIENTED STRAND BOARD C/W "H" CLIPS
  2x4 STRAPPING @ 16" O/C ON
  2x12 ROOF JOISTS @ 16" O/C C/W
  R-32 FIBRE GLAS BATT INSULATION
  6 MIL POLY'N V.B.
  5/8" GYPSUM BOARD OR
  5/8" X-TYPE GYPSUM BOARD
  45 MINUTE RATED F.R.R.
  (OVER SECONDARY SUITE)
- R3. PROVIDE 2 1/2" (63MM) CLEAR BETWEEN R-20 INSULATION AND SHEATHING. (MIN. R-20 @ ROOF-WALL CONNECTION FOR 4'-0" (1.2M) AROUND PERIMETER OF BUILDING. AIR VENTILATION BAFFLES TO BE INSTALLED WHERE REQUIRED IN AS PER BCBC 9.19.)
- R4. EAVE PROTECTION
  CONT. UP ROOF SLOPE FOR 12"
  PAST EXTERIOR WALL.
- R5. PROVIDE 1 SQ.FT. ATTIC VENT PER
  300 SQ.FT. OF INSULATED AREA MIN.
  25% OF REQUIRED TO BE @ TOP AND BOTTOM
  (TO COMPLY WI. B.C. BLDG. CODE 9.19.1)
- R6. PROVIDE 1 SQ.FT. ATTIC VENT PER
  150 SQ.FT. OF INSULATED AREA MIN.
  25% OF REQUIRED TO BE @ TOP AND BOTTOM
  (TO COMPLY WI. B.C. BLDG. CODE 9.19.1)
  6" COMPACTED GRAVE
- R7. PRE-FIN. FASCIA GUTTER
  2×8 FASCIA BD.
  2×4 SUB. FASCIA BD.
  VENTED SOFFIT
  (SEE CONTRACTOR)
  (NOT SHOWN IN SECTION)
- R8. PRE-FIN. FASCIA GUTTER
  2×8 FASCIA BD.
  2×4 SUB. FASCIA BD.
  1/2" ORIENTED STRAND BOARD
  VENTED SOFFIT
  (SEE CONTRACTOR)

## **FLOORS**

- FL1. FINISHED FLOORING ON
  19/32" ORIENTED STRAND BOARD
  (NAILED & GLUED TO FLOOR STRUCT. BELOW) ON
  2×10 FLOOR JOISTS @ 16" OR 12" O/C
  C/W 2×2 X-BRIDGING @ 7.0' O/C (MAX)
  1/2" GYPSUM BOARD
- FL2. B.C. BUILDING CODE (TABLE-9.10.3.1.B)
  RATED FLOOR ASSEMBLY F8D
  FINISHED FLOORING ON
  11/16" ORIENTED STRAND BOARD
  (FASTENED & GLUED TO FLOOR STRUCT. BELOW) ON
  2×10 FLOOR JOISTS @ 16" OR 12" O/C
  C/W 2×2 X-BRIDGING @ 7.0' O/C (MAX)
  R-31 INSULATION
  RESILIENT METAL CHANNELS @ 24" O/C
  1 LAYERS 5/8" X-TYPE GYPSUM BOARD
- FL3. FINISHED FLOORING ON
  11/16" ORIENTED STRAND BOARD
  (FASTENED & GLUED TO FLOOR STRUCT. BELOW) ON
  2×10 FLOOR JOISTS @ 16" OR 12" O/C
  C/W 2×2 X-BRIDGING @ 7.0' O/C (MAX)
  PROVIDE R-31 F/G BATT INSULATION IN
  JOIST CAVITY C/W
  BUILDING WRAP
  VENTED SOFFIT (TO OWNERS SPEC'S)
  TO ALL SUSPENDED FLOOR AREAS
- FL4. 3 1/2" CONCRETE SLAB
  6 MIL. POLY'N V.B.
  6" COMPACTED GRAVEL OR SAND
  SLOPE TO DOORS 1"

(NOT SHOWN IN SECTION)

30 MINUTE F.R.R., 50 S.T.C.

- FL5. 3 1/2" CONCRETE SLAB
  6 MIL. POLY'N V.B.
  6" COMPACTED GRAVEL OR SAND
  - 6" COMPACTED GRAVEL OR SAND SLOPE MIN. 2% AWAY FROM BUILDING

## WALLS

- W1. DOUBLE GLAZING
  ENERGY STAR LOW "E" RATING IN
  THERMAL BREAK FRAMES
  2/2"X10" LINTEL OVER (@ bearing walls only)
  (TYPICAL, wi. 2 1/2" XPS insulation)
  FLASHING OVER @ EXTERIOR
  (glazing in all exterior doors & within 3 ft.
  of exterior doors to be shatterproof (SP))
- W2. CONC. FIBRE BOARD ON
  9.5MM (3/8") AIR SPACE / STRAPPING
  3/8"×2" BORATE TREATED PLYWOOD STRAPPING
  HOUSE WRAP (A.B.) (TYVEK OR EQ.)
  7/16" ORIENTED STRAND BOARD SHEATHING
  2×6 STUDS @ 16" O/C
  R-20 INSULATION
  6 MIL. POLYETHYLENE VAPOUR BARRIER
  1/2" GYPSUM BOARD
- W3. B.C. BUILDING CODE (TABLE 9.10.3.1.A)
  RATED WALL ASSEMBLY W3c

  1 LAYER 1/2" X-TYPE GYPSUM BOARD
  RESILIENT METAL CHANNELS @ 24" O/C
  2×4 STUDS @ 16" O/C OR
  2×6 STUDS @ 16" O/C (IF NOTED) C/W
  3 1/2" FIBRE GLASS SOUND BATTS
  1 LAYER 1/2" X-TYPE GYPSUM BOARD
  45 MIN. F.R.R 43 S.T.C
  (BETWEEN PRIMARY LIVING & SECONDARY SUITE)
  (NOT SHOWN IN SECTION)
- W4. INTERIOR PARTITION
  1/2" GYPSUM BOARD ON EACH SIDE
  OF 2×4 STUDS @ 16" O/C OR
  2×6 STUDS @ 16" O/C (IF NOTED)
- W5. 5/8" X-TYPE GYPSUM BOARD ON 2×6 STUDS @ 16" O/C C/W
  R-20 INSULATION
  6 MIL. POLY'N V.B
  1/2" GYPSUM BOARD
  (BETWEEN GARAGE & LIVING)

## FOUNDATION

- F1. DAMP PROOFING (WHERE REQUIRED) ON 8" THK. CONC. FOUNDATION WALL C/W 15 M BARS @ 24" O/C B/W
- F2. 16"X 8" CONC. FOOTINGS

  C/W 2 (TWO) 15M BARS CONT. 3 IN. FROM BOTT.

  ON UNDISTURBED SOIL (SOLID BEARING)
- F3. 4" PERIMETER DRAIN
  3" TIGHT PIPE FOR RWL
  DRAIN ROCK
- F4. ANCHOR BOLTS @ 4.0 FT. O/C MAX C/W SILL GASKETS
- F5. UNDER SLAB INSULATION
  2 1/2" (RSI 2.15) EXTRUDED POLYSTYRENE
  RIGID INSULATION 4'-0" (1.2M)
  CONT. AROUND PERIMETER UNDER
  SLAB INSTALLED HORIZONTALLY
  (VERIFY WITH MUNICIPALITY DEPTH OF FROST LINE)

# vol Victoria 9 design group

#105 - 859 ORONO AVENUE VICTORIA, B.C. V9B 2T9 P. 250.382.7374 F. 250.382.7364

Date

Nov 5, 2024

**Project Address** 

3597 Temperate Place Lot 26 - Royal Bay Colwood, B.C. **Prepared for** 

Verity Construction

Project #

8298-26


Scale

As Noted

Drawn By

MIS

BASEPLAN D TYPE D

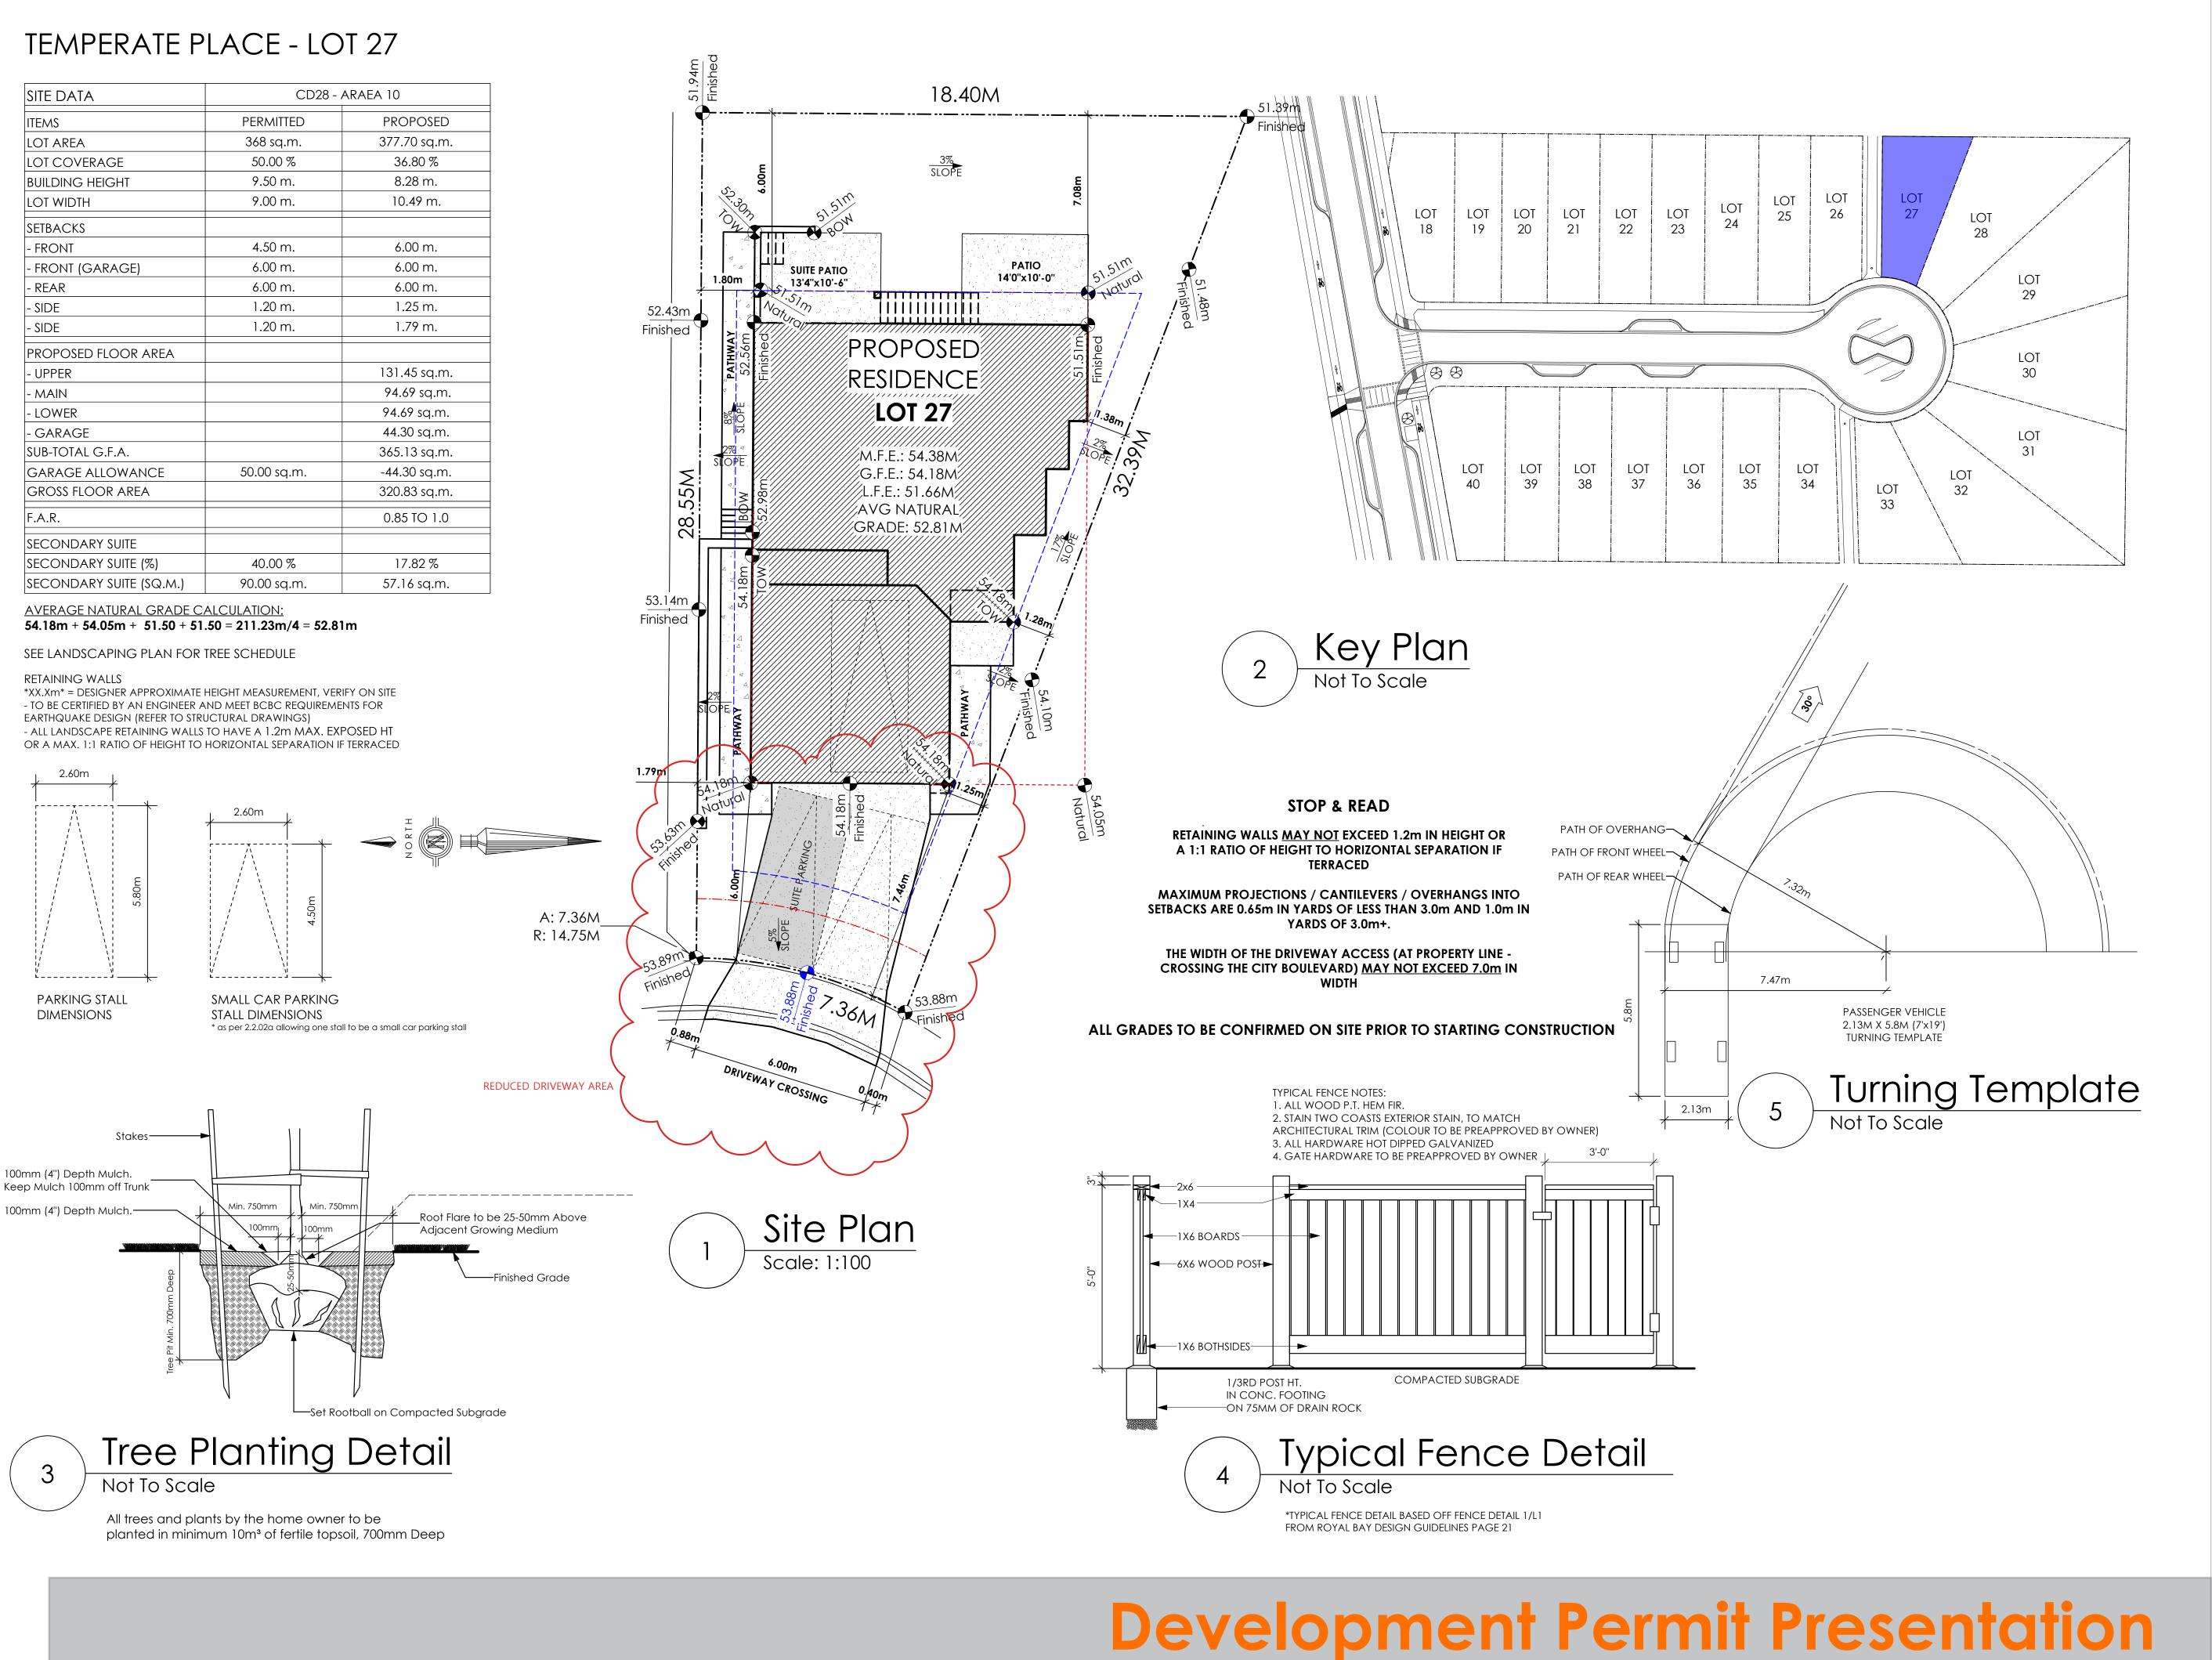

volvictoria design group

#103 - 891ATTREE AVENUE VICTORIA, B.C. V9B 0A6 P. 250.382.7374 F. 250.382.7364

Date

Nov 15, 2024

Project Address
3599 Temperate Place
Lot 27 - Royal Bay
Colwood, B.C.
Prepared for

Verity Construction

Project #

8298-27


Scale


As Noted

Drawn By

MDK

BASE PLAN E TYPE A

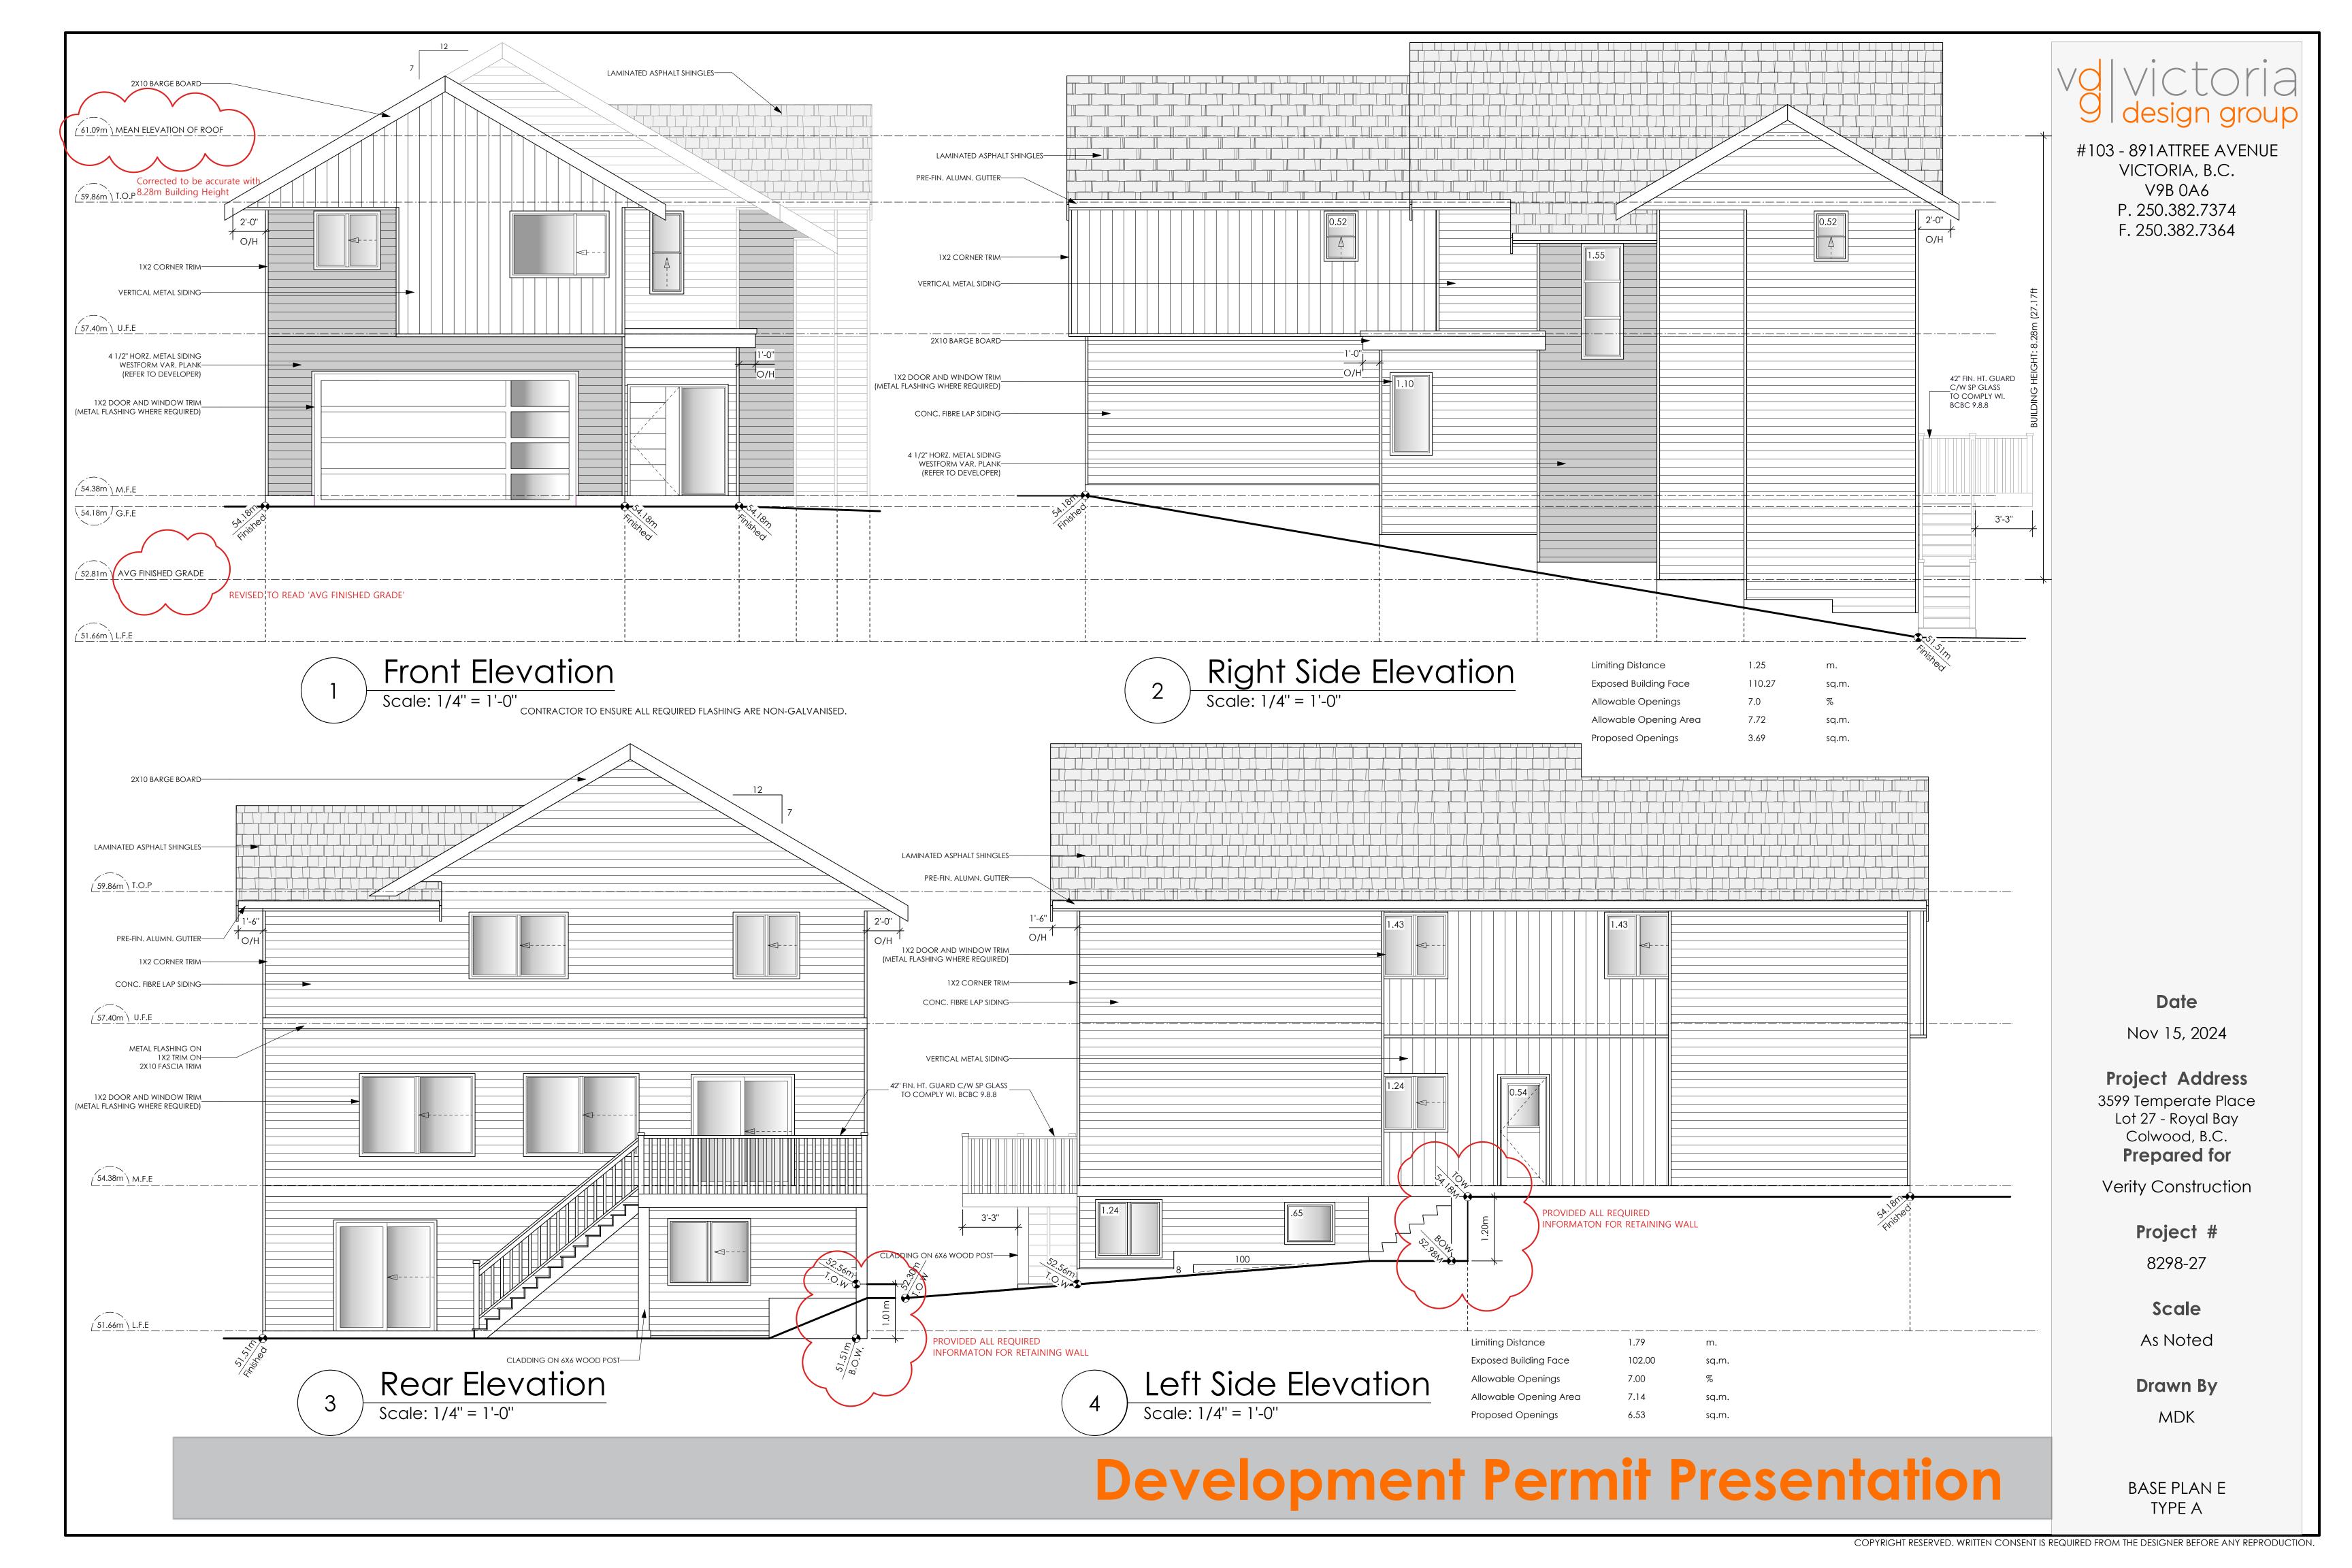

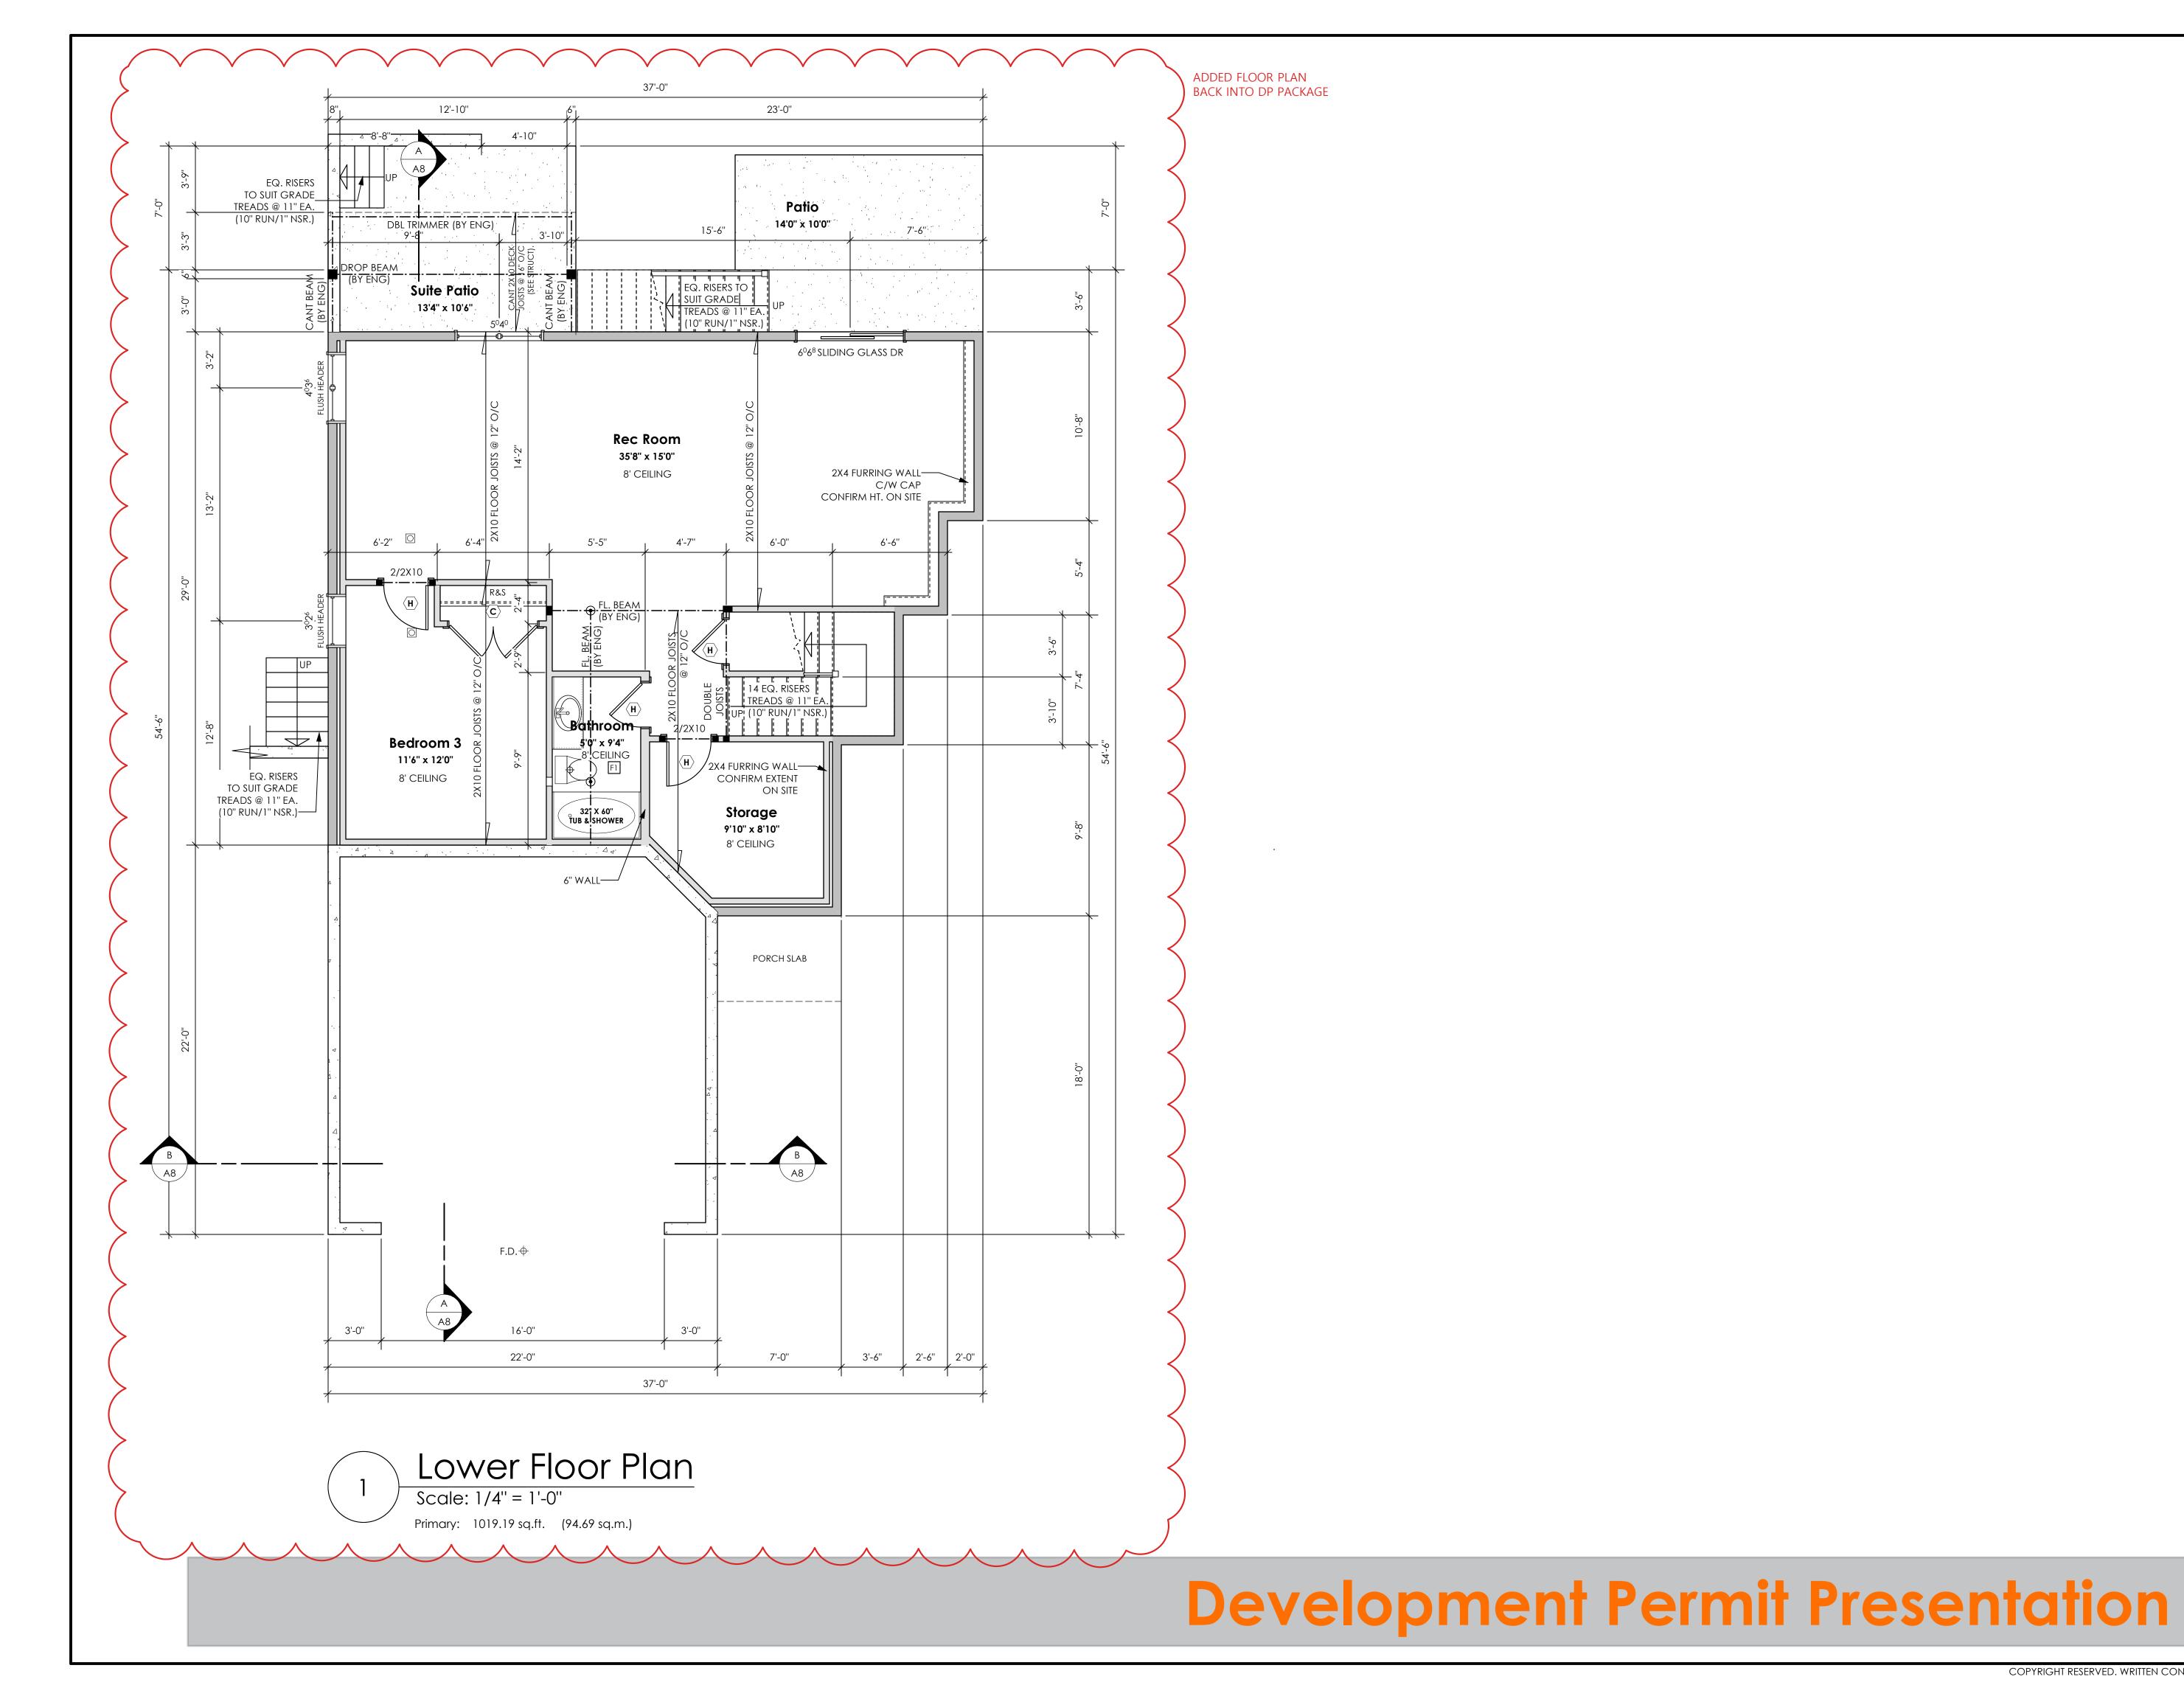

volvictoria 9 design group

#103 - 891ATTREE AVENUE VICTORIA, B.C. V9B 0A6 P. 250.382.7374 F. 250.382.7364

Date

Nov 15, 2024

Project Address
3599 Temperate Place
Lot 27 - Royal Bay
Colwood, B.C.
Prepared for

Verity Construction

Project #

8298-27


Scale

As Noted

Drawn By

MDK

BASE PLAN E TYPE A

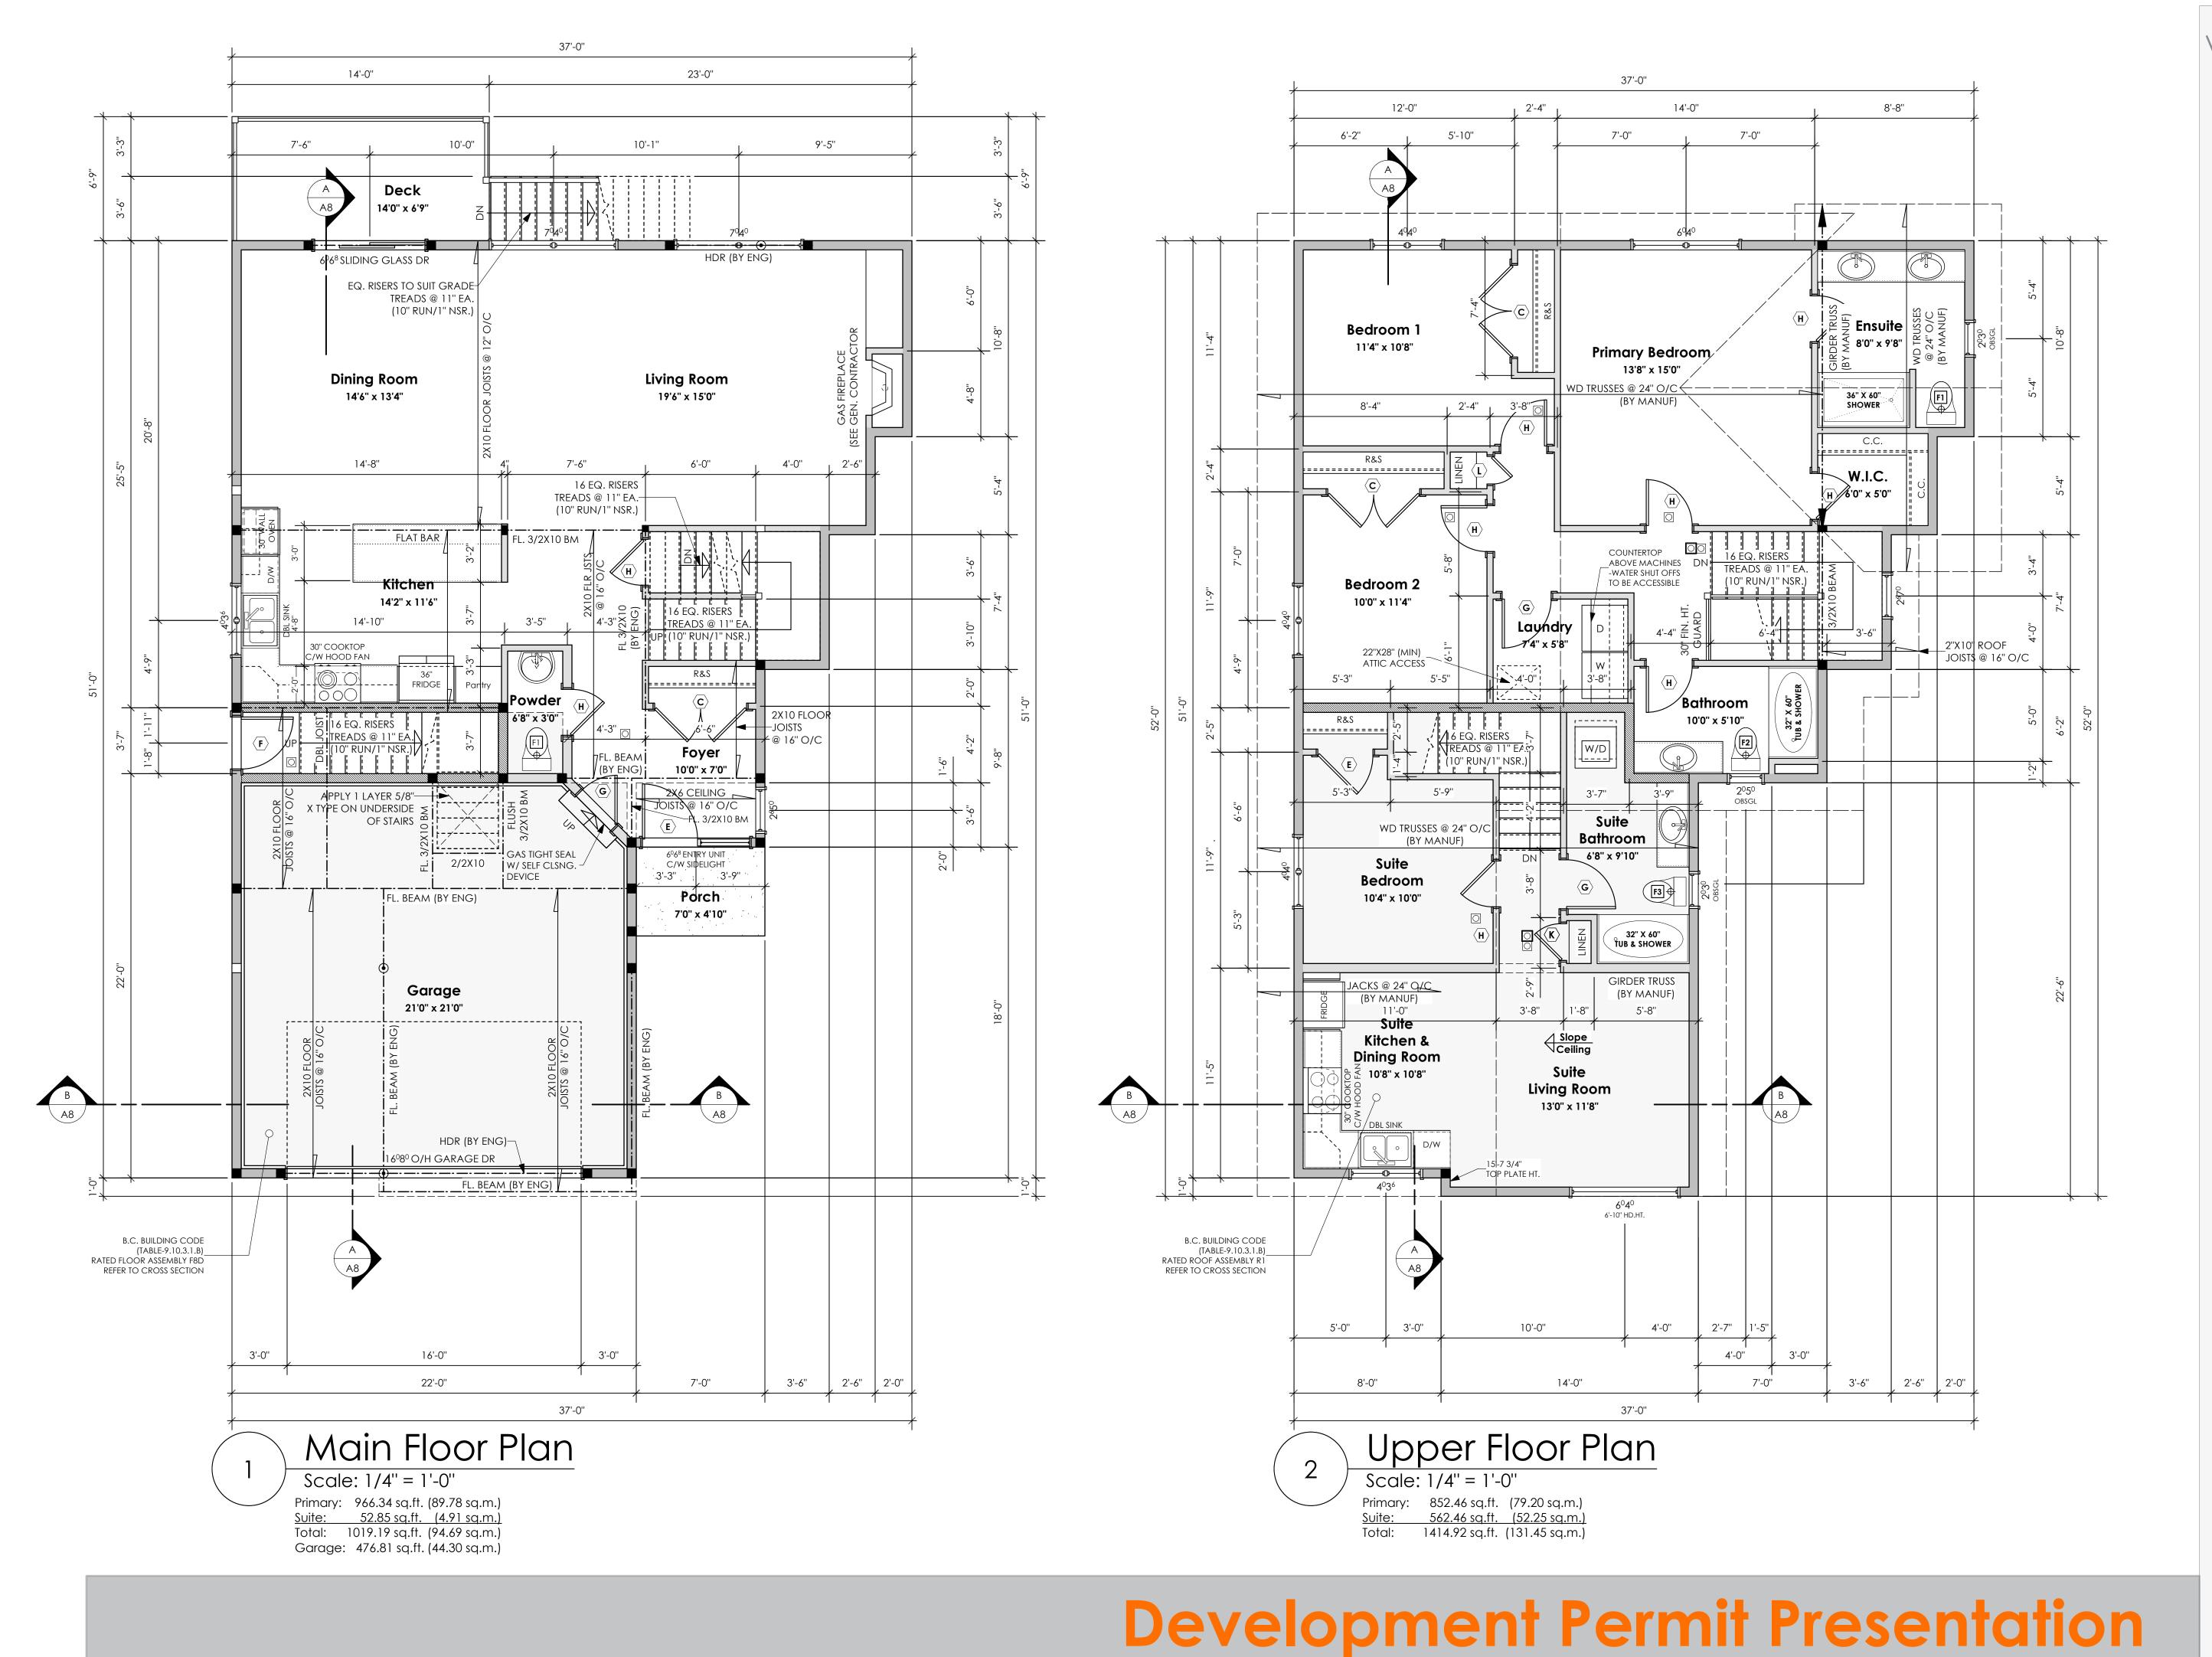

volvictoria 9 design group

> #103 - 891 ATTREE AVENUE VICTORIA, B.C. V9B 0A6 P. 250.382.7374 F. 250.382.7364

> > Date

Nov 15, 2024

Project Address
3599 Temperate Place
Lot 27 - Royal Bay
Colwood, B.C.
Prepared for

Verity Construction

Project #

8298-27


Scale

As Noted

Drawn By

MDK

BASE PLAN E TYPE A

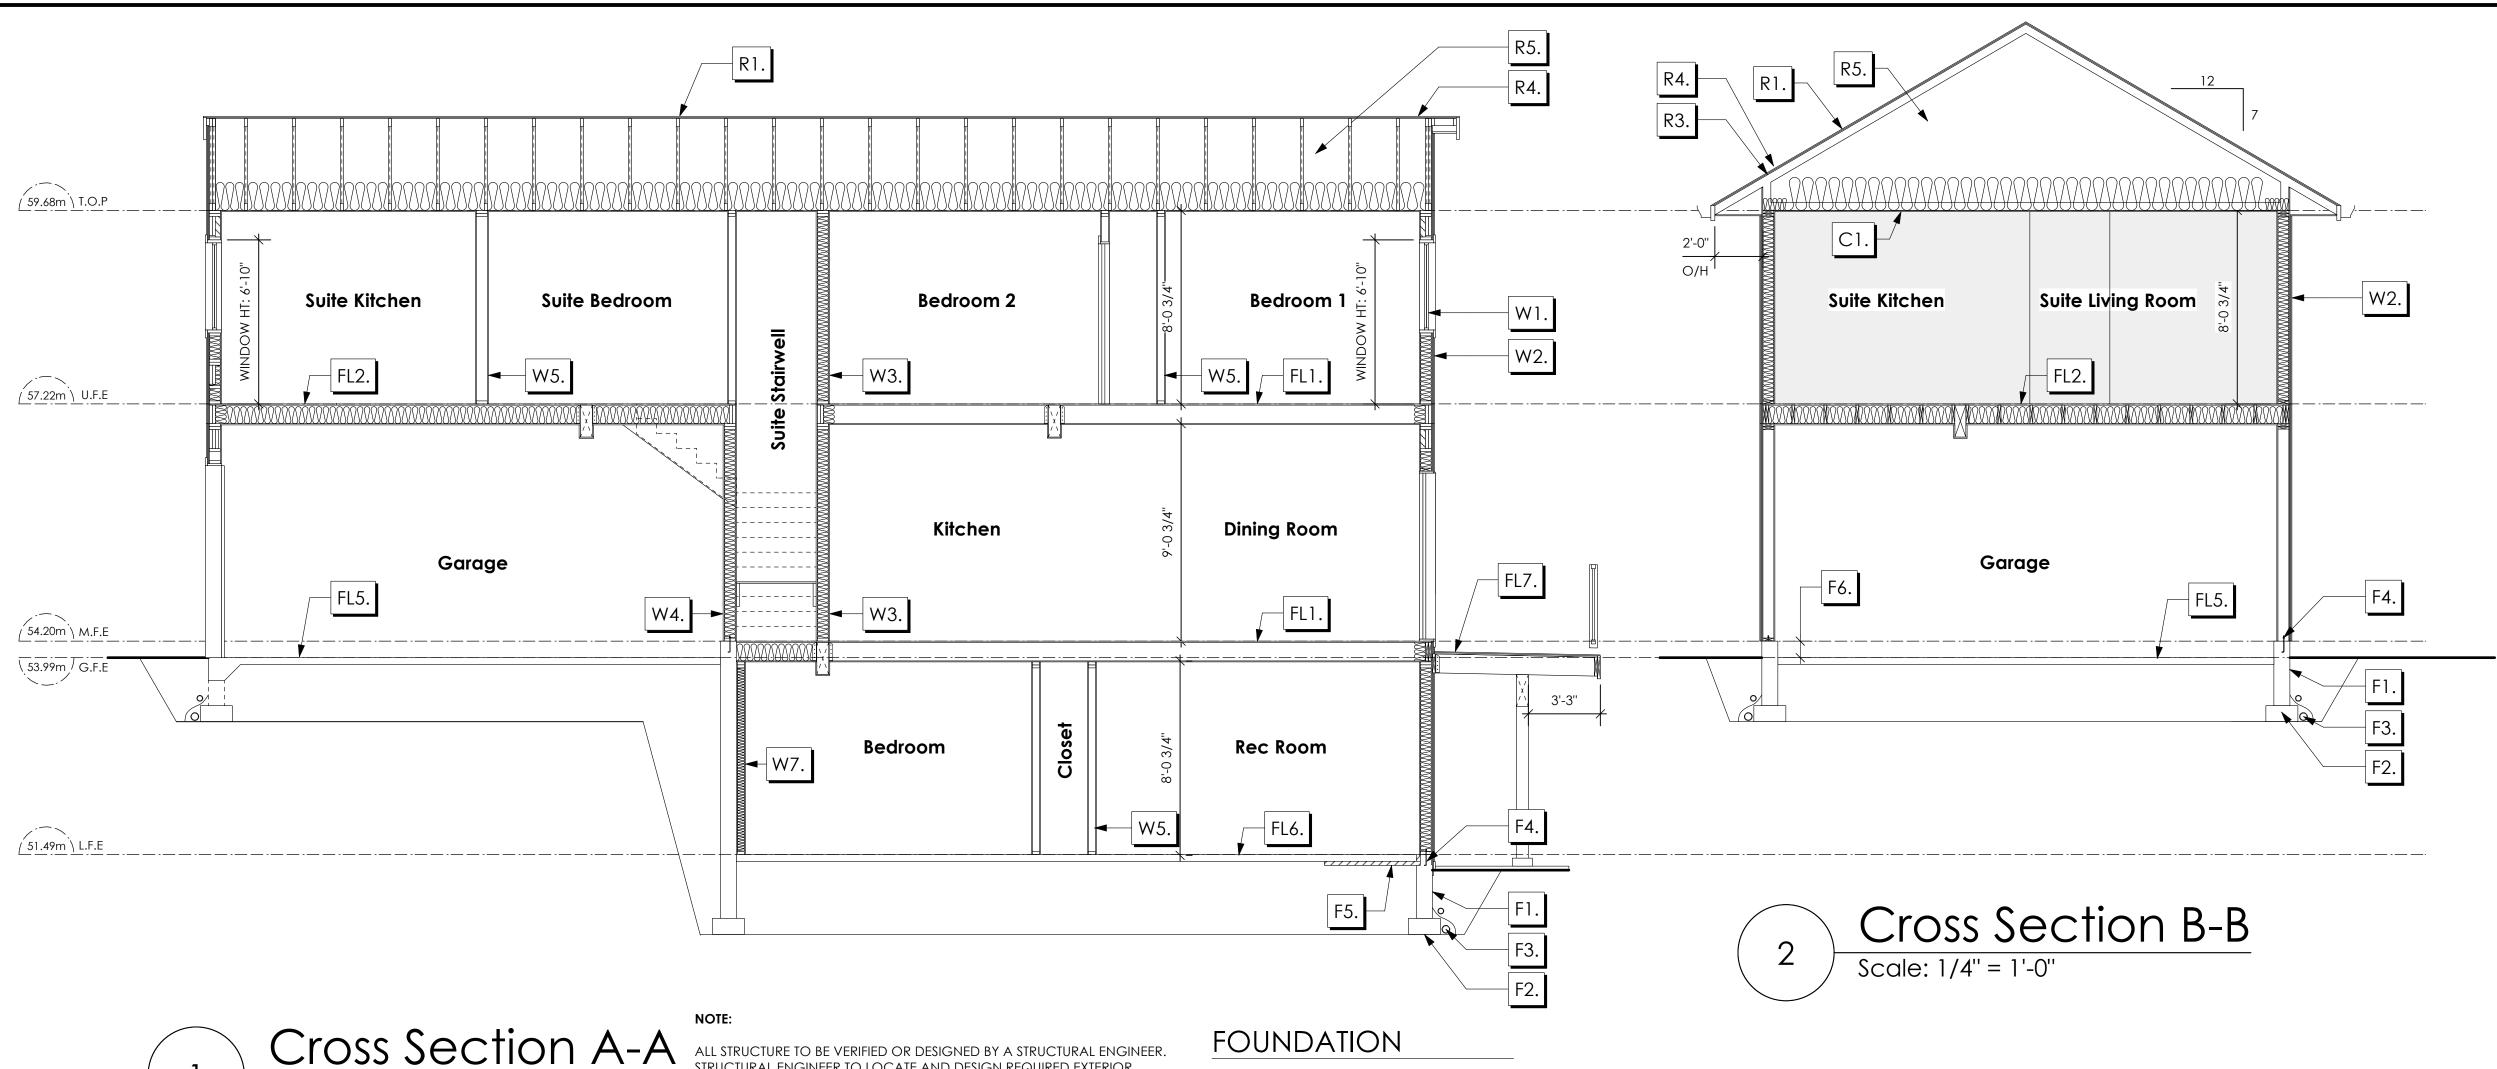

## ROOFS

LAMINATED ASPHALT SHINGLES ON 7/16" ORIENTED STRAND BOARD C/W "H" CLIPS WD TRUSSES (DESIGNED BY MANUF.) R-40 FIBRE GLAS BATT INSULATION OR 14 1/2" FIBRE GLASS LOOSE FILL INSULATION 6 MIL POLY'N V.B. 5/8" GYPSUM BOARD OR 5/8" X-TYPE GYPSUM BOARD 45 MINUTE RATED F.R.R. (OVER SECONDARY SUITE)

Scale: 1/4" = 1'-0"

R2. 2 PLY S.B.S.MODIFIED BITUMEN FULLY ADHERED MEMBRANE (TO COMPLY WI. CGSB 37-GP-56M AND CGSB-37-6P-9MA) ON 7/16" ORIENTED STRAND BOARD C/W "H" CLIPS 2×10 ROOF JOISTS @ 16" O/C **VENTED SOFFIT** (NOT IN SECTION)

R3. PROVIDE 2 1/2" (63MM) CLEAR BETWEEN R-20 INSULATION AND SHEATHING. (MIN. R-20 @ ROOF-WALL CONNECTION FOR 4'-0" (1.2M) AROUND PERIMETER OF BUILDING. AIR VENTILATION BAFFLES TO BE INSTALLED WHERE REQUIRED IN AS PER BCBC 9.19.) (NOT SHOWN IN SECTION)

R4. EAVE PROTECTION CONT. UP ROOF SLOPE FOR 12" PAST EXTERIOR WALL.

R5. PROVIDE 1 SQ.FT. ATTIC VENT PER 300 SQ.FT. OF INSULATED AREA MIN. 25% OF REQUIRED TO BE @ TOP AND BOTTOM (TO COMPLY WI. B.C. BLDG. CODE 9.19.1)

R6. PRE-FIN. FASCIA GUTTER 2×8 FASCIA BD. 2×4 SUB. FASCIA BD. **VENTED SOFFIT** (SEE CONTRACTOR) (NOT SHOWN IN SECTION)

R7. PRE-FIN. FASCIA GUTTER 2×8 FASCIA BD. 2×4 SUB. FASCIA BD. 1/2" ORIENTED STRAND BOARD **VENTED SOFFIT** (SEE CONTRACTOR) (NOT SHOWN IN SECTION)

## **FLOORS**

FL1. FINISHED FLOORING ON 19/32" ORIENTED STRAND BOARD (NAILED & GLUED TO FLOOR STRUCT. BELOW) ON 2×10 FLOOR JOISTS @ 16" OR 12" O/C C/W 2×2 X-BRIDGING @ 7.0' O/C (MAX) 1/2" GYPSUM BOARD

and interior wall bracing to resist lateral loads in compliance

FL5. 3 1/2" CONCRETE SLAB

6 MIL. POLY'N V.B.

SLOPE TO DOORS 1"

FL6. 3 1/2" CONCRETE SLAB

FL7. DECKING MEMBRANE

WALLS

W1. DOUBLE GLAZING

6 MIL. POLY'N V.B.

6" COMPACTED GRAVEL

6" COMPACTED GRAVEL OR SAND

2×10 DECK JOISTS @ 16" O/C C/W

(PROVIDE ADEQUATE MEMBRANE

ENERGY STAR LOW "E" RATING IN

(TYPICAL, wi. 2 1/2" XPS insulation)

FLASHING OVER @ EXTERIOR

2/2"X10" LINTEL OVER (@ bearing walls only)

(glazing in all exterior doors & within 3 ft.

of exterior doors to be shatterproof (SP))

3/8"×2" BORATE TREATED PLYWOOD STRAPPING

7/16" ORIENTED STRAND BOARD SHEATHING

6 MIL. POLYETHYLENE VAPOUR BARRIER

9.5MM (3/8") AIR SPACE / STRAPPING

HOUSE WRAP (A.B.) (TYVEK OR EQ.)

W3. B.C. BUILDING CODE (TABLE 9.10.3.1.A)

1 LAYER 1/2" X-TYPE GYPSUM BOARD

2×6 STUDS @ 16" O/C (IF NOTED) C/W

1 LAYER 1/2" X-TYPE GYPSUM BOARD

(BETWEEN PRIMARY LIVING & SECONDARY SUITE)

3 1/2" FIBRE GLASS SOUND BATTS

RESILIENT METAL CHANNELS @ 24" O/C

RATED WALL ASSEMBLY W3c

2×4 STUDS @ 16" O/C OR

45 MIN. F.R.R 43 S.T.C

THERMAL BREAK FRAMES

W2. CONC. FIBRE BOARD ON

2×6 STUDS @ 16" O/C

1/2" GYPSUM BOARD

R-20 INSULATION

"UPSTAND" @ EXT. WALL.)#

(TO COMPLY WITH CAN/CGSB 37.54) ON

TAPERS TO PROVIDE MIN.1:50 SLOPE ON

5/8" T&G PLYWOOD OR EQ. C/W "H" CLIPS

WITH B.C. BUILDING CODE 9.23.13. AND SUPPLY DETAILS IF REQUIRED

STRUCTURAL WOOD ELEMENTS WITHIN 150MM (6") FROM FINISHED

FOR TERMITE AND DECAY PROTECTION B.C.B.C. 9.3.2.9.(3)

FL2. B.C. BUILDING CODE (TABLE-9.10.3.1.B) RATED FLOOR ASSEMBLY F8D FINISHED FLOORING ON 11/16" ORIENTED STRAND BOARD (FASTENED & GLUED TO FLOOR STRUCT. BELOW) ON 2×10 FLOOR JOISTS @ 16" OR 12" O/C C/W 2×2 X-BRIDGING @ 7.0' O/C (MAX) R-31 INSULATION RESILIENT METAL CHANNELS @ 24" O/C 6 MIL. POLYETHYLENE VAPOUR BARRIER 1 LAYERS 5/8" X-TYPE GYPSUM BOARD 30 MINUTE F.R.R., 50 S.T.C.

FL3. FINISHED FLOORING ON 11/16" ORIENTED STRAND BOARD (FASTENED & GLUED TO FLOOR STRUCT. BELOW) ON 2×10 FLOOR JOISTS @ 16" OR 12" O/C C/W 2×2 X-BRIDGING @ 7.0' O/C (MAX) PROVIDE R-31 F/G BATT INSULATION IN JOIST CAVITY C/W BUILDING WRAP VENTED SOFFIT (TO OWNERS SPEC'S) TO ALL SUSPENDED FLOOR AREAS (NOT SHOWN IN SECTION)

FL4. FINISHED FLOORING ON 11/16" ORIENTED STRAND BOARD (FASTENED & GLUED TO FLOOR STRUCT. BELOW) ON 2×10 FLOOR JOISTS @ 16" OR 12" O/C C/W 2×2 X-BRIDGING @ 7.0' O/C (MAX) PROVIDE R-31 F/G BATT INSULATION IN JOIST CAVITY C/W **BUILDING WRAP** 1/2" ORIENTED STRAND BOARD VENTED SOFFIT (TO OWNERS SPEC'S) TO ALL SUSPENDED FLOOR AREAS

(NOT SHOWN IN SECTION)

## **FOUNDATION**

- DAMP PROOFING (WHERE REQUIRED) ON 8" THK. CONC. FOUNDATION WALL C/W 15 M BARS @ 24" O/C B/W
- F2. 16"X 8" CONC. FOOTINGS C/W 2 (TWO) 15M BARS CONT. 3 IN. FROM BOTT ON UNDISTURBED SOIL (SOLID BEARING)
- F3. 4" PERIMETER DRAIN 3" TIGHT PIPE FOR RWL DRAIN ROCK
- F4. ANCHOR BOLTS @ 4.0 FT. O/C MAX C/W SILL GASKETS
- F5. UNDER SLAB INSULATION 2 1/2" (RSI 2.15) EXTRUDED POLYSTYRENE RIGID INSULATION 4'-0" (1.2M) CONT. AROUND PERIMETER UNDER SLAB INSTALLED HORIZONTALLY (VERIFY WITH MUNICIPALITY DEPTH OF FROST LINE)

W4. B.C. BUILDING CODE (TABLE 9.10.3.1.A) RATED WALL ASSEMBLY W3c 1 LAYER 1/2" X-TYPE GYPSUM BOARD RESILIENT METAL CHANNELS @ 24" O/C 2×4 STUDS @ 16" O/C OR 2×6 STUDS @ 16" O/C (IF NOTED) C/W 3 1/2" FIBRE GLASS SOUND BATTS 6 MIL. POLY'N V.B 1 LAYER 1/2" X-TYPE GYPSUM BOARD 45 MIN. F.R.R 43 S.T.C (BETWEEN GARAGE & SECONDARY SUITE)

W5. INTERIOR PARTITION 1/2" GYPSUM BOARD ON EACH SIDE OF 2×4 STUDS @ 16" O/C OR 2×6 STUDS @ 16" O/C (IF NOTED)

W6. 5/8" X-TYPE GYPSUM BOARD ON 2×6 STUDS @ 16" O/C C/W R-20 INSULATION 6 MIL. POLY'N V.B 1/2" GYPSUM BOARD (BETWEEN GARAGE & LIVING) (NOT SHOWN IN SECTION)

W7. 1/2" GYPSUM BOARD ON 6 MIL. POLY'N V.B. 2×4 STUDS @ 24" O/C C/W R-12 BATT INSULATION HOUSE WRAP (A.B.) (TYVEK OR EQ.) OR 12.7MM (1/2") AIR SPACE (PROVIDE REQUIRED FIRE STOPS IN WALL ASSEMBLIES TO COMPLY WITH B.C. BLDG. CODE 9.10.16.)E

## Date

Nov 15, 2024

#103 - 891ATTREE AVENUE

VICTORIA, B.C.

V9B 0A6

P. 250.382.7374

F. 250.382.7364

**Project Address** 3599 Temperate Place Lot 27 - Royal Bay Colwood, B.C. Prepared for

Verity Construction

Project #

8298-27

Scale

As Noted


Drawn By

MDK

BASE PLAN E TYPE A

# Development Permit Presentation

COPYRIGHT RESERVED. WRITTEN CONSENT IS REQUIRED FROM THE DESIGNER BEFORE ANY REPRODUCTION.

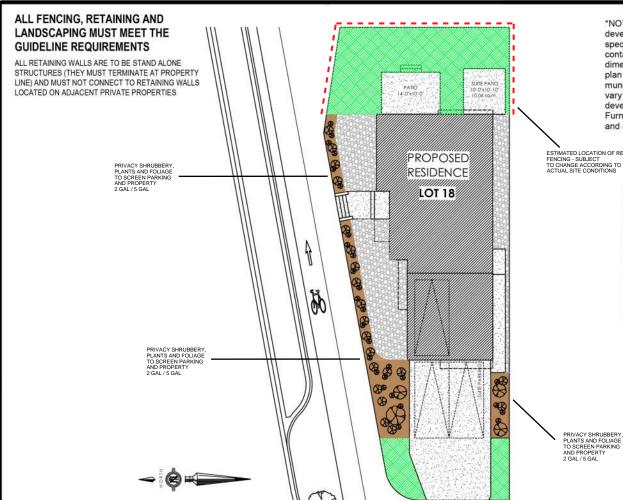


\*NOTE: In the interest of maintaining high standards, the developer reserves the right to modify plans. specifications and design without prior notice. Drawings contained within are artist renderings only. Sizes and dimensions are approximate and may vary with actual plan and survey. Exterior style may change pending municipal approval. Retaining wall location and types may vary and are subject to municipal, engineering or developer discretion. Subject to change without notice. Furniture as shown on plans are for layout purposes only and are not included in the sale.


ESTIMATED LOCATION OF REAR FENCING - SUBJECT TO CHANGE ACCORDING TO ACTUAL SITE CONDITIONS

	ITEM	AREA (sf)	%
90	GARDEN BED	367	13%
想對	GRAVEL	630	22%
23,000	CONCRETE	1,038	37%
	SOD	782	28%
	TOTAL	2,817	100%

LEGEND UPGRADE SHRUBBERY, PLANTS AND FOLIAGE PRIVACY SHRUBBERY PRIVACY SHRUBBERY - 2 GAL - 5 GAL

**KEY PLAN** NOT TO SCALE Schedule 2

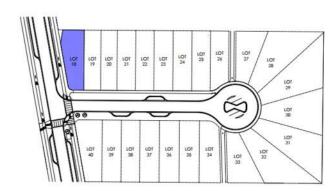

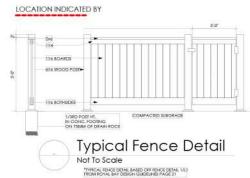

ADDITIONAL NOTES:

PROPERTY TO BE IRRIGATED 6" PIPE FOR DRIVEWAY SLEEVES TO BE INSTALLED FOR CITY IRRIGATION LINES

OCATION INDICATED BY	Ibblasi   Idomm (4) Doptift Mulch,   Keep Mulch   Idomm off Inels
206	100mm (4") Depth Mulch/ Me. 730mm Mn. 730mm Roof Flore to be 25-50mm A
TAS SOARDS - SAS WOOD POST-	Adjacent Clowing Medium  Adjacent Clowing Medium  Finished Crax
IXE SOTHSDES . COMPACTED SUBGRADE IN COMPACTED SUBGRADE	Set Roofball on Compacted Subgrade
ON 75MM OF DRAIN ROCK	Tree Planting Detail
Typical Fence Detail	Not To Scale
Not To Scale	All trees and plants by the home owner to be

LANDSCAPE PLAN NOT TO SCALE

	MM/DD/YY	ISSUED/REVISED
01	05/03/24	FOR APPROVAL
02	10/22/24	SITE PLAN UPDATE
03	11/01/24	SITE PLAN REVISION

DATE **PROJECT** 

> LANDSCAPING PLAN LOT 18, 3581 TEMPERATE PL. **ROYAL BAY, SECTOR 7** CITY OF COLWOOD



QUALITY CONSTRUCTION. TRUSTED SERVICE.

106 - 1039 Langford Parkway Victoria, B.C. V9B 0A6


#### ALL FENCING, RETAINING AND LANDSCAPING MUST MEET THE **GUIDELINE REQUIREMENTS**

ALL RETAINING WALLS ARE TO BE STAND ALONE STRUCTURES (THEY MUST TERMINATE AT PROPERTY LINE) AND MUST NOT CONNECT TO RETAINING WALLS LOCATED ON ADJACENT PRIVATE PROPERTIES



ESTIMATED LOCATION OF REAR FENCING - SUBJECT TO CHANGE ACCORDING TO ACTUAL SITE CONDITIONS SUITE PATIO 10'-0'x10'-10'

\*NOTE: In the interest of maintaining high standards, the developer reserves the right to modify plans. specifications and design without prior notice. Drawings contained within are artist renderings only. Sizes and dimensions are approximate and may vary with actual plan and survey. Exterior style may change pending municipal approval. Retaining wall location and types may vary and are subject to municipal, engineering or developer discretion. Subject to change without notice. Furniture as shown on plans are for layout purposes only and are not included in the sale.

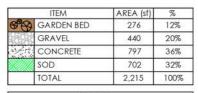

LEGEND PRIVACY SHRUBBERY UPGRADE SHRUBBERY, PLANTS AND FOLIAGE PRIVACY SHRUBBERY


LANDSCAPE PLAN

NOT TO SCALE




**KEY PLAN** 

NOT TO SCALE

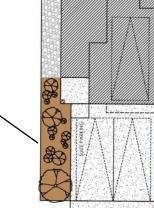


PRIVACY SHRUBBERY, PLANTS AND FOLIAGE TO SCREEN PARKING AND PROPERTY 2 GAL / 5 GAL

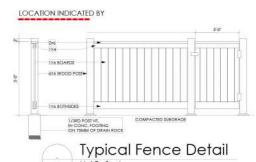

Not To Scale "TYPICAL FENCE DETAIL BASED OFF FENCE DETAIL 1/L1 FROM ROYAL BAY DESIGN GUIDELINES PAGE 21

#### ADDITIONAL NOTES:

PROPERTY TO BE IRRIGATED 6" PIPE FOR DRIVEWAY SLEEVES TO BE INSTALLED FOR CITY IRRIGATION LINES

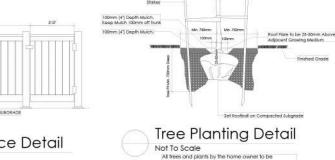

	MM/DD/YY	ISSUED/REVISED
01	05/03/24	FOR APPROVAL
02	10/16/24	SITE PLAN UPDATE
03	11/01/24	SITE PLAN REVISION

PRIVACY SHRUBBERY PLANTS AND FOLIAGE TO SCREEN PARKING AND PROPERTY


> DATE **PROJECT**

> > LANDSCAPING PLAN LOT 19, 3583 TEMPERATE PL. **ROYAL BAY, SECTOR 7** CITY OF COLWOOD



QUALITY CONSTRUCTION, TRUSTED SERVICE.


106 - 1039 Langford Parkway Victoria, B.C. V9B 0A6

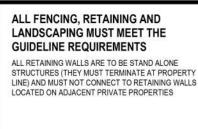


ESTIMATED LOCATION OF REAR FENCING - SUBJECT TO CHANGE ACCORDING TO ACTUAL SITE CONDITIONS

> PROPOSED RESIDENCE LOT 20

\*NOTE: In the interest of maintaining high standards, the developer reserves the right to modify plans. specifications and design without prior notice. Drawings contained within are artist renderings only. Sizes and dimensions are approximate and may vary with actual plan and survey. Exterior style may change pending vary and are subject to municipal, engineering or developer discretion. Subject to change without notice. Furniture as shown on plans are for layout purposes only and are not included in the sale.

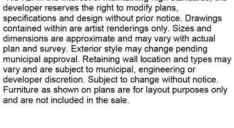

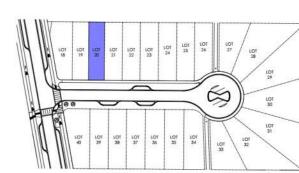


**KEY PLAN** 

NOT TO SCALE



LEGEND				
8	PRIVACY SHRUBBERY PRIVACY SHRUBBERY		UPGRADE SHRUBBERY, PLANTS AND FOLIAGE -2 GAL -5 GAL	

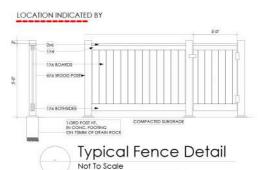

"TYPICAL FENCE DETAIL BASED OFF FENCE DETAIL 1/L1 FROM ROYAL BAY DESIGN GUIDELINES PAGE 21



### ADDITIONAL NOTES:

PROPERTY TO BE IRRIGATED 6" PIPE FOR DRIVEWAY SLEEVES TO BE INSTALLED FOR CITY IRRIGATION LINES

ANDSCAPE PLAN	
IOT TO SCALE	

	MM/DD/YY	ISSUED/REVISED
01	05/29/24	FOR APPROVAL
02	10/16/24	SITE PLAN UPDATE
03	11/01/24	SITE PLAN REVISION

PRIVACY SHRUBBERY, PLANTS AND FOLIAGE TO SCREEN PARKING

DATE **PROJECT** 

> LANDSCAPING PLAN LOT 20, 3585 TEMPERATE PL. **ROYAL BAY, SECTOR 7** CITY OF COLWOOD

PRIVACY SHRUBBERY PLANTS AND FOLIAGE



QUALITY CONSTRUCTION. TRUSTED SERVICE.


106 - 1039 Langford Parkway Victoria, B.C. V9B 0A6


#### ALL FENCING, RETAINING AND LANDSCAPING MUST MEET THE GUIDELINE REQUIREMENTS

ALL RETAINING WALLS ARE TO BE STAND ALONE STRUCTURES (THEY MUST TERMINATE AT PROPERTY LINE) AND MUST NOT CONNECT TO RETAINING WALLS LOCATED ON ADJACENT PRIVATE PROPERTIES \*NOTE: In the interest of maintaining high standards, the developer reserves the right to modify plans, specifications and design without prior notice. Drawings contained within are artist renderings only. Sizes and dimensions are approximate and may vary with actual plan and survey. Exterior style may change pending municipal approval. Retaining wall location and types may vary and are subject to municipal, engineering or developer discretion. Subject to change without notice. Furniture as shown on plans are for layout purposes only and are not included in the sale.



#### KEY PLAN NOT TO SCALE

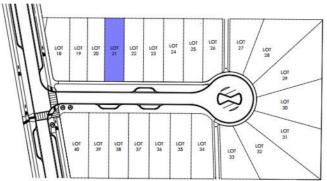

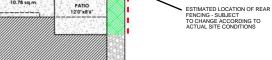

SUITE PATIO 14'6"x8'0" 10.78 sq.m.

0

PROPOSED RESIDENCE


**LOT 21** 

	ITEM	AREA (sf)	%
66	GARDEN BED	270	11%
	GRAVEL	354	15%
	CONCRETE	864	35%
	SOD	956	39%
	TOTAL	2,444	100%

PRIVACY SHRUBBERY PLANIS AND FOLIAGE
PRIVACY SHRUBBERY - 2 CAL

SHRUBBERY - 5 GAL

PRIVACY SHRUBBERY, PLANTS AND FOLIAGE TO SCREEN PARKING AND PROPERTY 2 GAL / 5 GAL

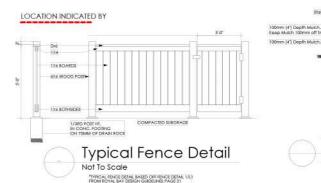

Tree Planting Detail

Not To Scale

All frees and plants by the home owner to be

#### ADDITIONAL NOTES:

PROPERTY TO BE IRRIGATED
6" PIPE FOR DRIVEWAY SLEEVES TO
BE INSTALLED FOR CITY IRRIGATION
LINES

LANDSCAPE PLAN
 NOT TO SCALE

	MM/DD/YY	ISSUED/REVISED
01	06/17/24	FOR APPROVAL
02	10/15/24	SITE PLAN UPDATE
03	11/04/24	SITE PLAN REVISION

PRIVACY SHRUBBERY, PLANTS AND FOLIAGE TO SCREEN PARKING

> DATE PROJECT


> > LANDSCAPING PLAN LOT 21, 3587 TEMPERATE PL. ROYAL BAY CITY OF COLWOOD



QUALITY CONSTRUCTION. TRUSTED SERVICE.

106 - 1039 Langford Parkway Victoria, B.C. V9B 0A6 P: 250.474.1039 www.verityconstruction.ca


Roof Flare to be 25-50mm Above Adjacent Growing Medium

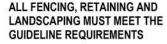

BOULDER LOOSE STACK RETAINING WALL (REFER TO CIVIL PLAN -


ESTIMATED LOCATION OF REAR FENCING - SUBJECT TO CHANGE ACCORDING TO ACTUAL SITE CONDITIONS

\*NOTE: In the interest of maintaining high standards, the developer reserves the right to modify plans, specifications and design without prior notice. Drawings contained within are artist renderings only. Sizes and dimensions are approximate and may vary with actual plan and survey. Exterior style may change pending municipal approval. Retaining wall location and types may vary and are subject to municipal, engineering or developer discretion. Subject to change without notice. Furniture as shown on plans are for layout purposes only and are not included in the sale.

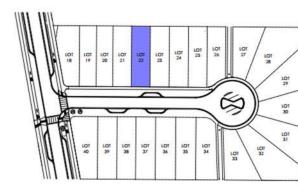

**KEY PLAN** 

NOT TO SCALE

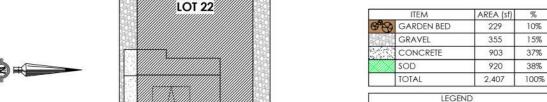

Suite Patio

14'6" x 8'0"

PROPOSED RESIDENCE

Patio

120" x 9'6"


10.60 sq.m.

PRIVACY SHRUBBERY

PRIVACY SHRUBBERY

UPGRADE SHRUBBERY, PLANTS AND FOLIAGE

PLANTS AND FOLIAGE TO SCREEN PARKING AND PROPERTY 2 GAL / 5 GAL

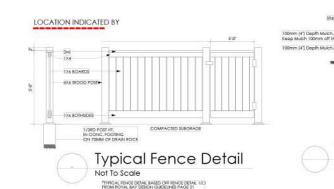

Tree Planting Detail Not To Scale All trees and plants by the home owner to be

#### ADDITIONAL NOTES:

PROPERTY TO BE IRRIGATED 6" PIPE FOR DRIVEWAY SLEEVES TO BE INSTALLED FOR CITY IRRIGATION LINES

LANDSCAPE PLAN	
NOT TO SCALE	

	MM/DD/YY	ISSUED/REVISED
01	06/04/24	FOR APPROVAL
02	10/15/24	SITE PLAN UPDATE
03	11/04/24	SITE PLAN REVISION
04	11/14/24	BOULDER WALL INCLUDED

PRIVACY SHRUBBERY,

PLANTS AND FOLIAGE TO SCREEN PARKING AND PROPERTY

2 GAL / 5 GAL

DATE **PROJECT** 

> LANDSCAPING PLAN LOT 22, 3589 TEMPERATE PL. **ROYAL BAY** CITY OF COLWOOD



QUALITY CONSTRUCTION. TRUSTED SERVICE.


106 - 1039 Langford Parkway Victoria, B.C. V9B 0A6

P: 250.474.1039 www.verityconstruction.ca

Roof Flare to be 25-50mm Above Adjacent Growing Medium

#### ALL FENCING, RETAINING AND LANDSCAPING MUST MEET THE **GUIDELINE REQUIREMENTS**

ALL RETAINING WALLS ARE TO BE STAND ALONE STRUCTURES (THEY MUST TERMINATE AT PROPERTY LINE) AND MUST NOT CONNECT TO RETAINING WALLS LOCATED ON ADJACENT PRIVATE PROPERTIES

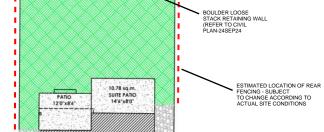


PROPOSED RESIDENCE

**LOT 23** 

\*NOTE: In the interest of maintaining high standards, the developer reserves the right to modify plans. specifications and design without prior notice. Drawings contained within are artist renderings only. Sizes and dimensions are approximate and may vary with actual plan and survey. Exterior style may change pending municipal approval. Retaining wall location and types may vary and are subject to municipal, engineering or developer discretion. Subject to change without notice. Furniture as shown on plans are for layout purposes only and are not included in the sale.


#### **KEY PLAN** NOT TO SCALE

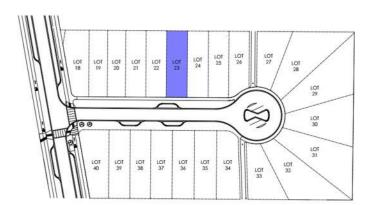

100mm (4") Depth Mulch.



PRIVACY SHRUBBERY PLANTS AND FOLIAGE TO SCREEN PARKING AND PROPERTY 2 GAL / 5 GAL

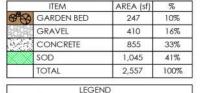

PRIVACY SHRUBBERY PRIVACY SHRUBBERY

PRIVACY SHRUBBERY PLANTS AND FOLIAGE TO SCREEN PARKING AND PROPERTY AND FOLIAGE

LANDSCAPE PLAN

NOT TO SCALE

UPGRADE SHRUBBERY, PLANTS

LOCATION INDICATED BY 6X6 WOOD POST 1X6 SOTHSIDES COMPACTED SUBGRADE

Typical Fence Detail

"TYPICAL FENCE DETAIL BASED OFF FENCE DETAIL 1/L1 FROM ROYAL BAY DESIGN GUIDELINES PAGE 21

PROPERTY TO BE IRRIGATED 6" PIPE FOR DRIVEWAY SLEEVES TO BE INSTALLED FOR CITY IRRIGATION LINES

## Not To Scale ADDITIONAL NOTES:

	MM/DD/YY	ISSUED/REVISED
01	06/05/24	FOR APPROVAL
02	10/15/24	SITE PLAN UPDATE
03	11/04/24	SITE PLAN REVISION
04	11/14/24	BOULDER WALL INCLUDED
ř.	i	

DATE **PROJECT** 

> LANDSCAPING PLAN LOT 23, 3591 TEMPERATE PL. **ROYAL BAY** CITY OF COLWOOD



QUALITY CONSTRUCTION, TRUSTED SERVICE.


106 - 1039 Langford Parkway Victoria, B.C. V9B 0A6

P: 250.474.1039 www.verityconstruction.ca

Roof Flare to be 25-50mm Above Adjacent Growing Medium

Tree Planting Detail

All trees and plants by the home owner to be

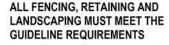


ESTIMATED LOCATION OF REAR FENCING - SUBJECT
TO CHANGE ACCORDING TO
ACTUAL SITE CONDITIONS

PRIVACY SHRUBBERY,
PLANTS AND FOLIAGE
TO SCREEN PARKING
AND PROPERTY
2 GAL / 5 GAL

BOULDER LOOSE STACK RETAINING WALL (REFER TO CIVIL PLAN -

\*NOTE: In the interest of maintaining high standards, the developer reserves the right to modify plans. specifications and design without prior notice. Drawings contained within are artist renderings only. Sizes and dimensions are approximate and may vary with actual plan and survey. Exterior style may change pending municipal approval. Retaining wall location and types may vary and are subject to municipal, engineering or developer discretion. Subject to change without notice. Furniture as shown on plans are for layout purposes only and are not included in the sale.

**KEY PLAN** NOT TO SCALE

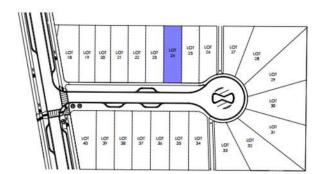

100mm (4") Depth Mulch.



SUITE PATIO 16'2'x8'0" 10.78 sq.m.

**LOT 24** PROPOSED

PATIO 12'0"x8'6"



LEGEND PRIVACY SHRUBBERY UPGRADE SHRUBBERY, PLANTS AND FOLIAGE PRIVACY SHRUBBERY

LANDSCAPE PLAN

NOT TO SCALE

LOCATION INDICATED BY 6X6 WOOD POST 1X6 SOTHSIDES COMPACTED SUBGRADE Typical Fence Detail

Not To Scale "TYPICAL FENCE DETAIL BASED OFF FENCE DETAIL 1/L1 FROM ROYAL BAY DESIGN GUIDELINES PAGE 21 Tree Planting Detail All trees and plants by the home owner to be

#### ADDITIONAL NOTES:

PROPERTY TO BE IRRIGATED 6" PIPE FOR DRIVEWAY SLEEVES TO BE INSTALLED FOR CITY IRRIGATION LINES

		-
MM/DD/YY	ISSUED/REVISED	DATE
06/13/24	FOR APPROVAL	PROJEC

01	06/13/24	FOR APPROVAL
02	10/15/24	SITE PLAN UPDATE
03	11/05/24	SITE PLAN REVISION
04	11/14/24	BOULDER WALL INCLUDED
r e	i i	

PLANTS AND FOLIAGE

TO SCREEN PARKING AND PROPERTY 2 GAL / 5 GAL

LANDSCAPING PLAN LOT 24, 3593 TEMPERATE PL. **ROYAL BAY** CITY OF COLWOOD




QUALITY CONSTRUCTION, TRUSTED SERVICE.

106 - 1039 Langford Parkway Victoria, B.C. V9B 0A6

P: 250.474.1039 www.verityconstruction.ca

Roof Flare to be 25-50mm Above Adjacent Growing Medium

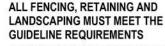



BOULDER LOOSE STACK RETAINING WALL (REFER TO CIVIL PLAN -

> ESTIMATED LOCATION OF REAR FENCING - SUBJECT TO CHANGE ACCORDING TO

\*NOTE: In the interest of maintaining high standards, the developer reserves the right to modify plans. specifications and design without prior notice. Drawings contained within are artist renderings only. Sizes and dimensions are approximate and may vary with actual plan and survey. Exterior style may change pending municipal approval. Retaining wall location and types may vary and are subject to municipal, engineering or developer discretion. Subject to change without notice. Furniture as shown on plans are for layout purposes only and are not included in the sale.

#### **KEY PLAN** NOT TO SCALE

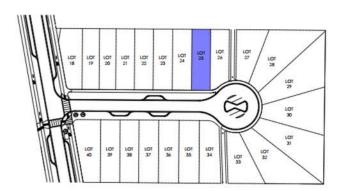

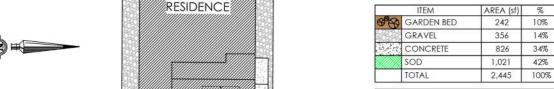

SUITE PATIO

14'6"x8'0" 10.78 sq.m.

**LOT 25** 

PROPOSED

12'0"x8'6"

PRIVACY SHRUBBERY

PRIVACY SHRUBBERY PLANTS AND FOLIAGE

TO SCREEN PARKING

LEGEND UPGRADE SHRUBBERY, PLANTS AND FOLIAGE

LOCATION INDICATED BY 6X6 WOOD POST 1X6 SOTHSIDES COMPACTED SUBGRADE Typical Fence Detail Not To Scale

100mm (4") Depth Mulch. Roof Flare to be 25-50mm Above Adjacent Growing Medium Tree Planting Detail

All trees and plants by the home owner to be

"TYPICAL FENCE DETAIL BASED OFF FENCE DETAIL 1/L1 FROM ROYAL BAY DESIGN GUIDELINES PAGE 21 ADDITIONAL NOTES:

PROPERTY TO BE IRRIGATED 6" PIPE FOR DRIVEWAY SLEEVES TO BE INSTALLED FOR CITY IRRIGATION LINES

#### LANDSCAPE PLAN NOT TO SCALE

	MM/DD/YY	ISSUED/REVISED
01	06/12/24	FOR APPROVAL
02	10/15/24	SITE PLAN UPDATE
03	11/05/24	SITE PLAN REVISION
04	11/14/24	BOULDER WALL INCLUDED
	T T	

PRIVACY SHRUBBERY PLANTS AND FOLIAGE TO SCREEN PARKING AND PROPERTY


> DATE **PROJECT**

> > LANDSCAPING PLAN LOT 25, 3595 TEMPERATE PL. **ROYAL BAY** CITY OF COLWOOD




QUALITY CONSTRUCTION, TRUSTED SERVICE.

106 - 1039 Langford Parkway Victoria, B.C. V9B 0A6

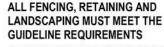

\*NOTE: In the interest of maintaining high standards, the developer reserves the right to modify plans. specifications and design without prior notice. Drawings contained within are artist renderings only. Sizes and dimensions are approximate and may vary with actual plan and survey. Exterior style may change pending municipal approval. Retaining wall location and types may vary and are subject to municipal, engineering or developer discretion. Subject to change without notice. Furniture as shown on plans are for layout purposes only and are not included in the sale.

#### **KEY PLAN** NOT TO SCALE

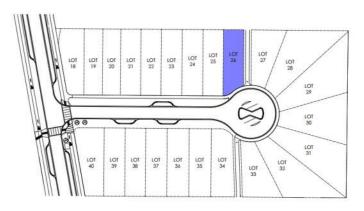



Suite Patio

**LOT 26** 

PROPOSED RESIDENCE

BOULDER LOOSE

Patio

120 x 96

10.60 sq.m.

STACK RETAINING WALL-(REFER TO CIVIL PLAN - 24SEP24)

8 PRIVACY SHRUBBERY PRIVACY SHRUBBERY

PRIVACY SHRUBBERY

PRIVACY SHRUBBERY, PLANTS AND FOLIAGE TO SCREEN PARKING AND PROPERTY 2 GAL / 5 GAL

ESTIMATED LOCATION OF REAR FENCING - SUBJECT TO CHANGE ACCORDING TO ACTUAL SITE CONDITIONS

AND FOLIAGE

AREA (sf

207

285

878

676

2.046

10%

14% 43%

33%

100%

LEGEND UPGRADE SHRUBBERY, PLANTS

LANDSCAPE PLAN

NOT TO SCALE

LOCATION INDICATED BY 6X6 WOOD POST 1X6 SOTHSIDES COMPACTED SUBGRADE Typical Fence Detail Not To Scale "TYPICAL FENCE DETAIL BASED OFF FENCE DETAIL 1/L1 FROM ROYAL BAY DESIGN GUIDELINES PAGE 21

100mm (4") Depth Mulch Roof Flare to be 25-50mm Above Adjacent Growing Medium Tree Planting Detail All trees and plants by the home owner to be

#### ADDITIONAL NOTES:

PROPERTY TO BE IRRIGATED 6" PIPE FOR DRIVEWAY SLEEVES TO BE INSTALLED FOR CITY IRRIGATION LINES

		88	
	MM/DD/YY	ISSUED/REVISED	$\Box$
01	06/06/24	FOR APPROVAL	
02	10/21/24	SITE PLAN UPDATE	
03	11/05/24	SITE PLAN REVISION	
	i ii		$\neg$

PRIVACY SHRUBBERY, PLANTS AND FOLIAGE TO SCREEN PARKING AND PROPERTY


> DATE **PROJECT**

> > LANDSCAPING PLAN LOT 26, 3597 TEMPERATE PL. **ROYAL BAY** CITY OF COLWOOD



QUALITY CONSTRUCTION, TRUSTED SERVICE.


106 - 1039 Langford Parkway Victoria, B.C. V9B 0A6

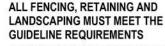



\*NOTE: In the interest of maintaining high standards, the developer reserves the right to modify plans. specifications and design without prior notice. Drawings contained within are artist renderings only. Sizes and dimensions are approximate and may vary with actual plan and survey. Exterior style may change pending municipal approval. Retaining wall location and types may vary and are subject to municipal, engineering or developer discretion. Subject to change without notice. Furniture as shown on plans are for layout purposes only and are not included in the sale.

ESTIMATED LOCATION OF REAR

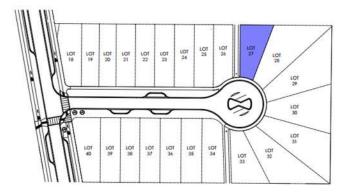

**KEY PLAN** 

NOT TO SCALE




LEGEND

# SHRUBBERY

PRIVACY SHRUBBERY

UPGRADE SHRUBBERY, PLANTS AND FOLIAGE - 2 GAL

- 5 GAL

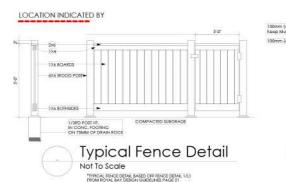

ADDITIONAL NOTES:

PROPERTY TO BE IRRIGATED 6" PIPE FOR DRIVEWAY SLEEVES TO BE INSTALLED FOR CITY IRRIGATION LINES

Stakes 100mm (4") Depth Mulch. Keep Mulch 100mm off Trunk 100mm (4") Depth Mulch.	Min. 750mm 100mm	Win 750mm	Roof Flore to be 25-50mm Adjacent Grawing Medium
Tree Ft John 7 Chrym, Deep	5		Finished Gro
		Set Roofball on	Compacted Subgrade
	e Plar	nting [	Detail
	s and plants by	the home owne om² of tertile tops	r to be oil, 700mm Deep

LANDSCAPE PLAN NOT TO SCALE

	MM/DD/YY	ISSUED/REVISED
01	06/28/24	FOR APPROVAL
02	07/30/24	SITE PLAN REVISION
03	09/04/24	SITE PLAN REVISION
04	11/05/24	SITE PLAN REVISION
05	11/18/24	CITY COMMENTS

PRIVACY SHRUBBERY, PLANTS AND FOLIAGE TO SCREEN PARKING

AND PROPERTY 2 GAL / 5 GAL

DATE **PROJECT**  PRIVACY SHRUBBERY

LANDSCAPING PLAN LOT 27, 3599 TEMPERATE PL. **ROYAL BAY** CITY OF COLWOOD



QUALITY CONSTRUCTION. TRUSTED SERVICE.

106 - 1039 Langford Parkway Victoria, B.C. V9B 0A6